

Owner **H. H. KOBLEGARD** Mailing Address **Permit No. 9482**
 Lot **19-20** Block **2** Subdivision **Di Lido Island No. 424** Street **West Di Lido Drive** Date **Jan. 25-1937**
 General Contractor **Wilbert Harborn** Address **9546**
 Architect **Russell T. Pancoast** Address **3232-11-0280**
 Front **65** Depth **35** Height _____ Stories **2** Use **Residence & garage**
 Type of construction **c-b-s-** Cost **\$ 14,500.00** Foundation **Concrete Pile** Roof **Tile**

Plumbing Contractor **McCaughan # 9861** Address _____ Date **Feb. 4-1937**
 No. fixtures **11** Rough approved by _____ Date _____
 No. Receptacles _____ Gas stove **1** Gas Heater **4**
 Plumbing Contractor _____ Address _____ Date _____
 No. fixtures set _____ Final approved by _____ Date _____
 Sewer connection _____ Septic tank **one 600 gal** Make **O'Neal Septic Tank** Date **March 24, '37**

Electrical Contractor **Hardy # 8320** Address _____ Date **Feb. 22-1937**
 No. outlets **22** Heaters _____ Stoves **1** Motors **1-ref** Fans _____ Temporary service _____
 Receptacles- **20** _____
~~Rough approved by~~ Centers of distribution - **1** Date _____
 Electrical Contractor **E.M. Landis # 8556-** **30 fixtures** Address _____ Date **Apr. 27-1937**
 No. fixtures set **30** Final approved by _____ Date _____
 Date of service **final OK May 4-1937- HCI**

Alterations or repairs _____ Date _____
 PLUMBING PERMIT # **20486** Alex. Orr. Replace 1 lavatory - Nov. 27, 1946
 BUILDING PERMIT # **31771** Addition of garage - 14' x 25' x 10' - J. C. Woodruff, contr.
 \$ 1,200..... Dec. 27, 1949

PLUMBING PERMITS

- #52751 Owner (Realtor John T. Larkin)- For Sale Sign - \$5.00- March 1, 1957
#55149 Syjack Construction: Remodel garage into bedroom, & other minor alterations - \$1000.00 -
December 9, 1957
#74720 AAA Atomic Sandblasting Co.: Sandblast residence and garage - \$332. - 9/9/65
#76927 Williams Paving: Pave driveway - \$850 - 8/25/66 OK MCLAUGHLIN 9/30/66
#82383 Dock & Marine Repair Dock \$700.00 5/20/69
#06656-Allen Fuller-For Sale Sign-12-26-74
#89011-Anthony Disimone-Wood decking and fence-\$6000-2-27-76
#89185-New Enterprises, Inc.-Room addition, carport, PHase I of plans-\$12000-10-19-76
#10258-Hacks Roofing-Roof addition 12 sqs on family room-\$600-11-19-76
#89690-Skip Soule and Son-Interior remodeling-\$25,000-9-19-78
7/30/80 #18584 Skip Soule 400 ' fence \$1000.
#M04787 Air Comfort Construction Inc/central air conditioning/9-24-80
#90261 Skip Sosle & Son Inc/remodel & new pool/\$25,000/11-4-80

ELECTRIC PERMITS

- X1 switch outlets, X6 receptacles, X2 light outlets, 2 fixtures, 1 center of distrib, 2 motors (1HP)-
Dec. 12, 1957
#67116 Vern Griffith Elect. Inc. - 1 range outlet, 5 motors 0-1 H.P. 1 Sewvice equip. 200A 6/30/69
#08790-Marine Found. Co.-Replace 2 existing pilings-\$550-3-22-76
#73684-S. Hompanera- 5 switch outlets; 13 light outlets; 6 receptacles; 200 amps service-12-2-76
#75028-Tri Star Electric- 9 switch outlets, 10 light outlets, 11 recepacles, 1 dryer, 1 range top, 1 water heater, 22
fixtures-9-25-78
PLUMBING: #43964 Economy Plumbing Co.: 1 sewer, size 4" - 10/8/63 OK Jenks 11/4/63
#56531-MidTown Plumbing- 1 bath tub, 2 lavatory, 1 ~~lxkxkxk~~ clothes washer, 1 sink, slop, 2 water closet-10-13-78
#56530-MidTown Plumbing- 1 bath tub, 1 dishwasher, 2 lavatory, 1 clothes washer, 1 sink, residence, 2 water closet-10-13-78

#1330 - BOARD OF ADJUSTMENT - JUNE 5, 1980 - Dr. Leon & Judith Ann Termin: Applicant wishes to exceed the 5 ft. maximum for a wall in a front yard by 2 ft. Subject wall shall have four column mounted lights adjacent to driveways, bringing total height at that point to nine ft. REQUEST APPROVED WITH THE CONDITION THAT LANDSCAPING BE SUBJECT TO APPROVAL BY PLANNING DIVISION.

BOARD OF ADJUSTMENT MEETING - JULY 11, 1980 - FILE NO: 1342: Applicant wishes to waive 2.5 ft. of the required 10 ft. side yard setback to construct a swimming pool, and waive 5 ft. of required 7.6 ft. for a pool deck. APPROVED WITH THE FOLLOWING CONDITION: pool deck elevation shall not exceed 6 ft. 6 in.

BUILDING PERMITS:

3-11--81/#M05124/1 above ground tank, 1 pool/Belcher Oil Co/\$18

#20968 10/1/81 S & S Contractors - remove asphalt and replace with concrete (existing circular driveway
3775 sq ft paving \$1,500.

PLUMBING PERMITS:

1-14-81/#59132/1 pool piping/Greens Pool Service Inc/\$10

ELECTRICAL PERMITS:

#76588 Light outlets, motors(0-1 hp), fixtures/TriStar Electric/9-17-80

#76630 Tri-Star Electric Inc/air conditioners/9-26-80

1-15-81/#76859/1 pool light outlet, (1) 0-1hp motor, (1) 1-3hp motor, 1 pool generator transformer/Tri-Star Electric/
\$21



#77101--Tri-Star Electric--1 Replace Existing Service only--4/9/81



WEST ELEVATION


RESIDENCE FOR THE DEPARTMENT OF THE ARMY

RESIDENCE FOR THE DEPARTMENT OF THE ARMY
ARCHITECTURAL DRAWING
NO. 1000
1917

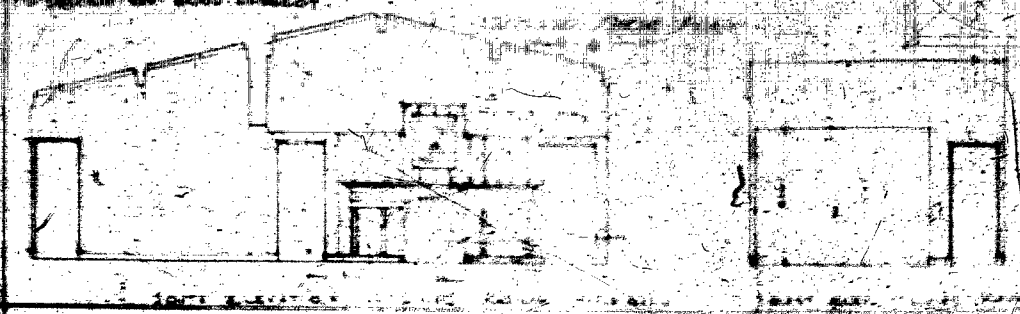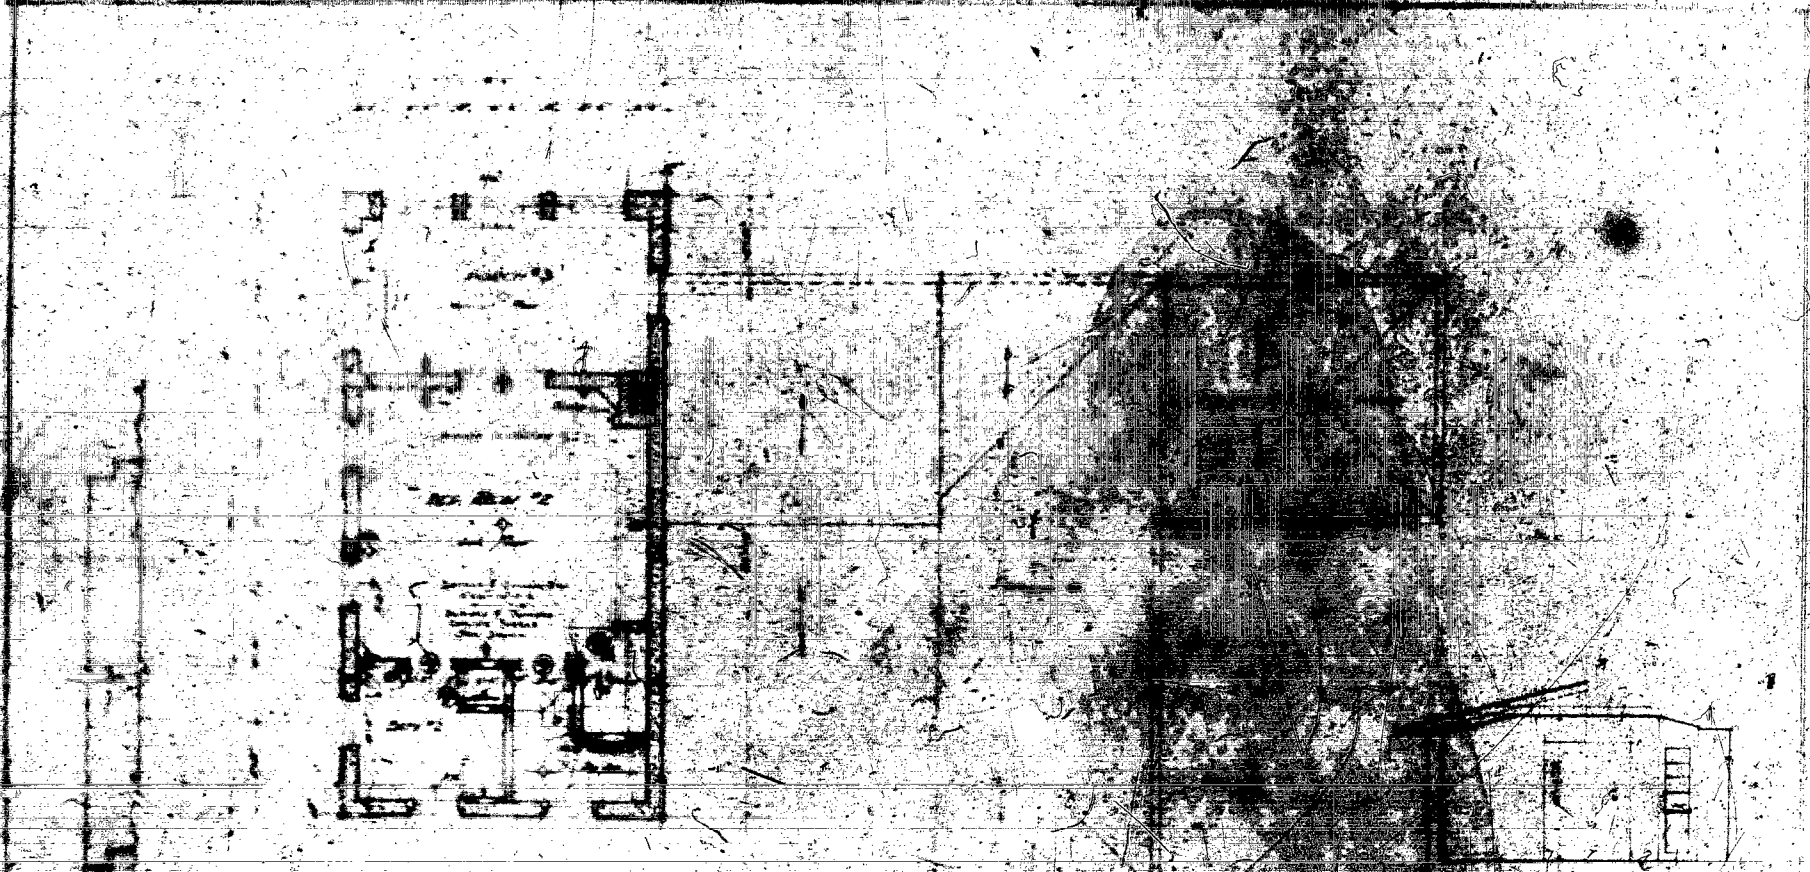


PLAN OF BED ROOM
1910

THESE PLANS WERE PREPARED BY THE ARCHITECT FOR THE USE OF THE ENGINEER IN CONNECTION WITH THE DESIGN OF THE FOUNDATION AND STRUCTURE OF THE BUILDING. THE ARCHITECT IS NOT RESPONSIBLE FOR THE ACCURACY OF THE DIMENSIONS OR THE LOCATION OF THE FOUNDATION OR STRUCTURE OF THE BUILDING.

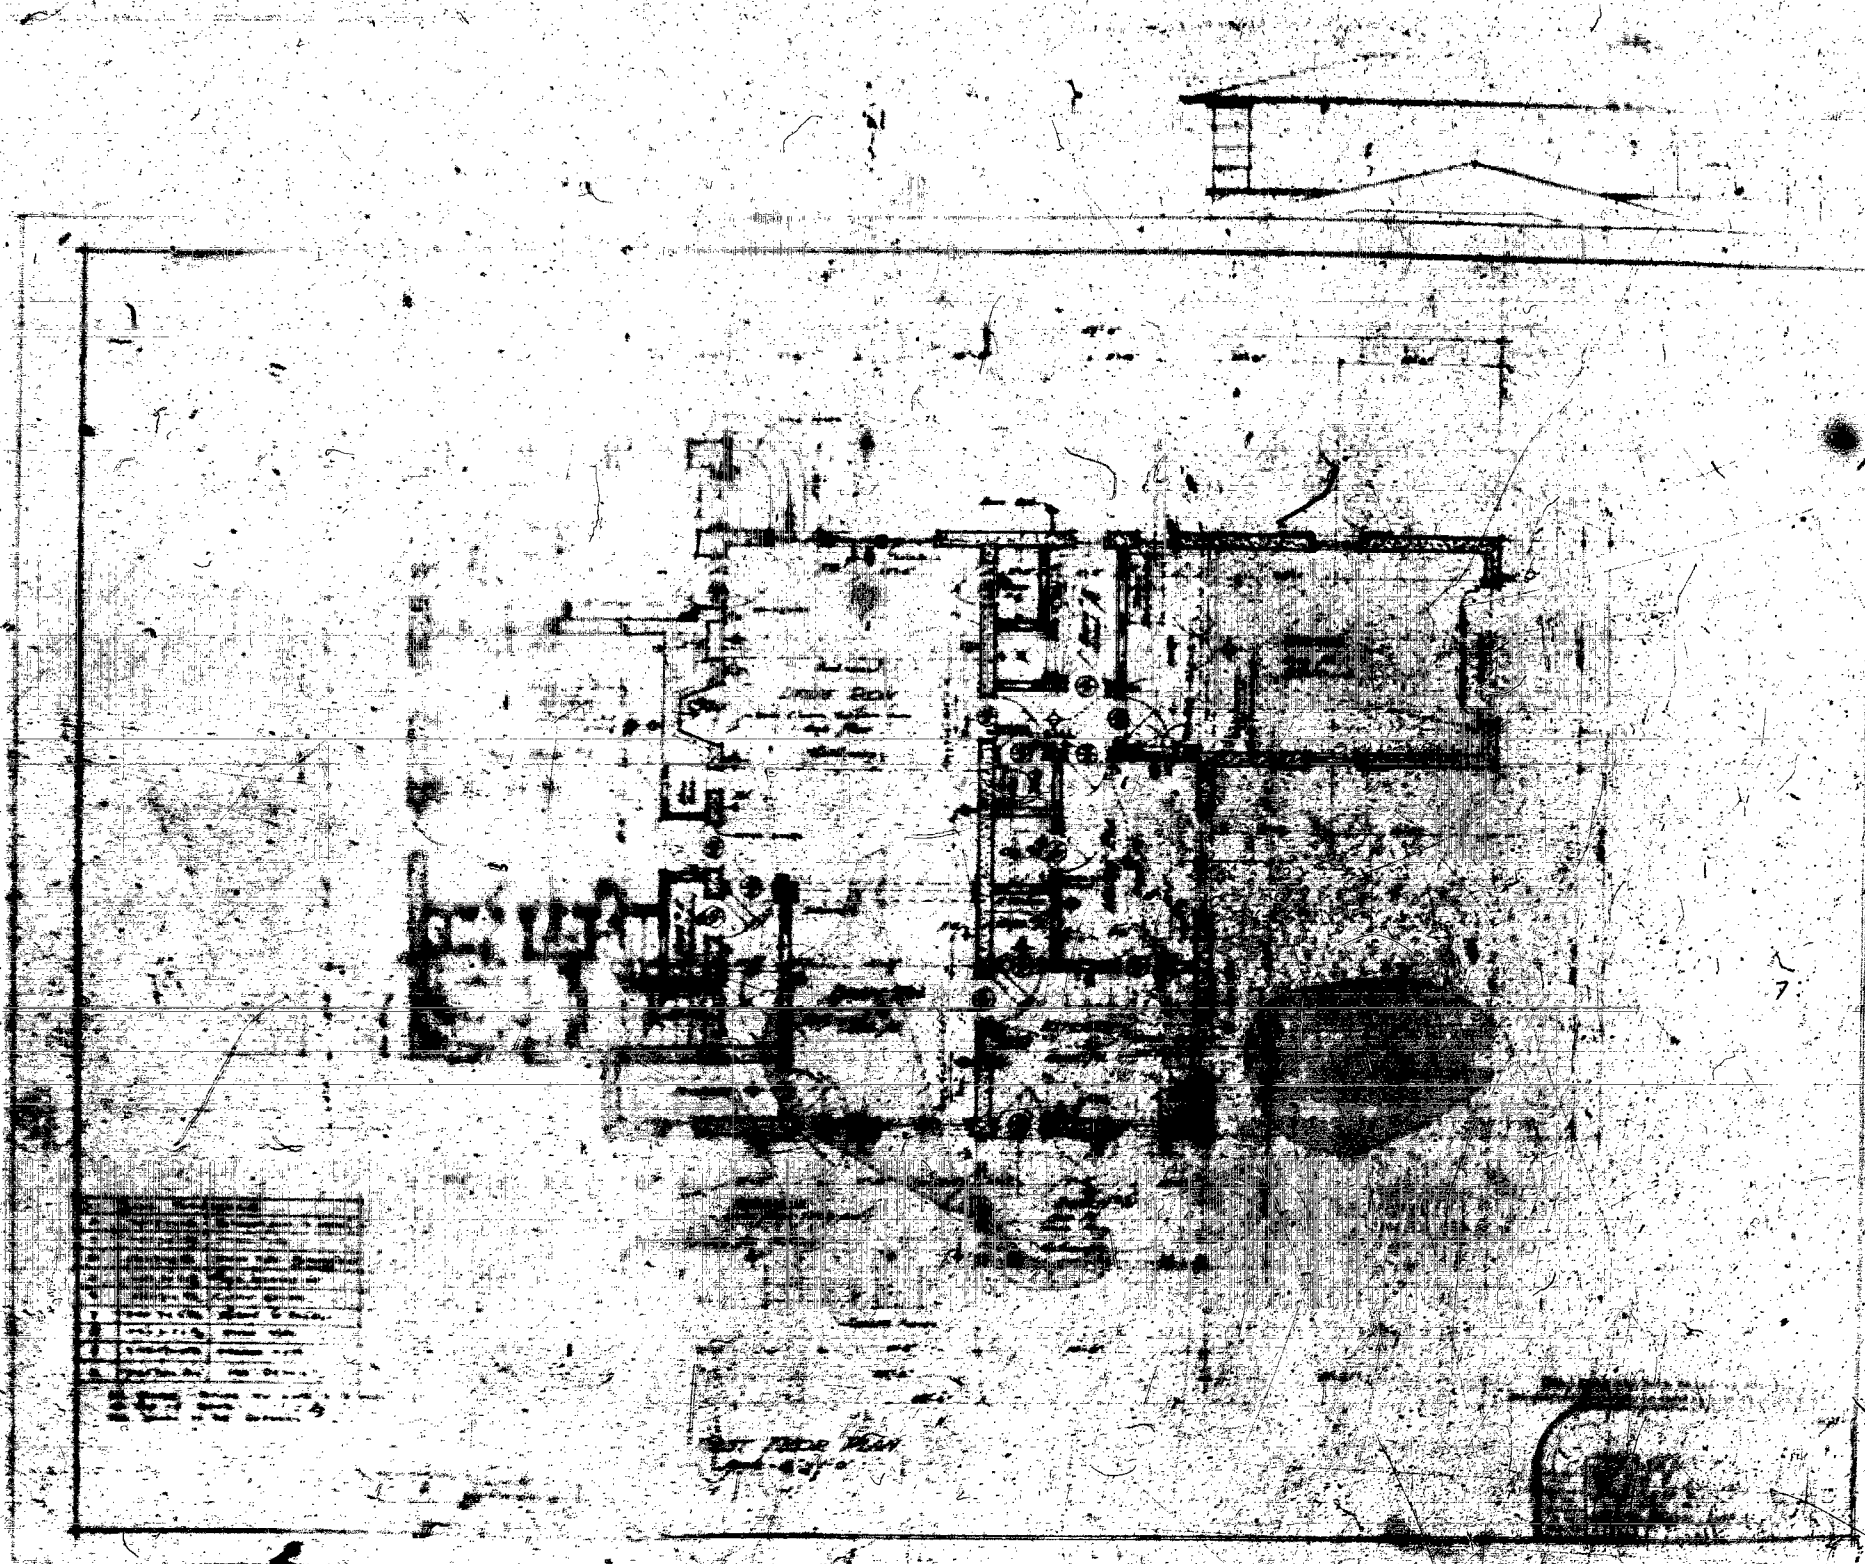

1	Living Room	12' x 14'
2	Bedroom	10' x 12'
3	Bedroom	10' x 12'
4	Bedroom	10' x 12'
5	Bathroom	5' x 7'
6	Kitchen	8' x 10'
7	Dining Room	8' x 10'
8	Hallway	4' x 6'
9	Entry	4' x 6'
10	Staircase	4' x 6'

1st Floor Plan
1/20/50

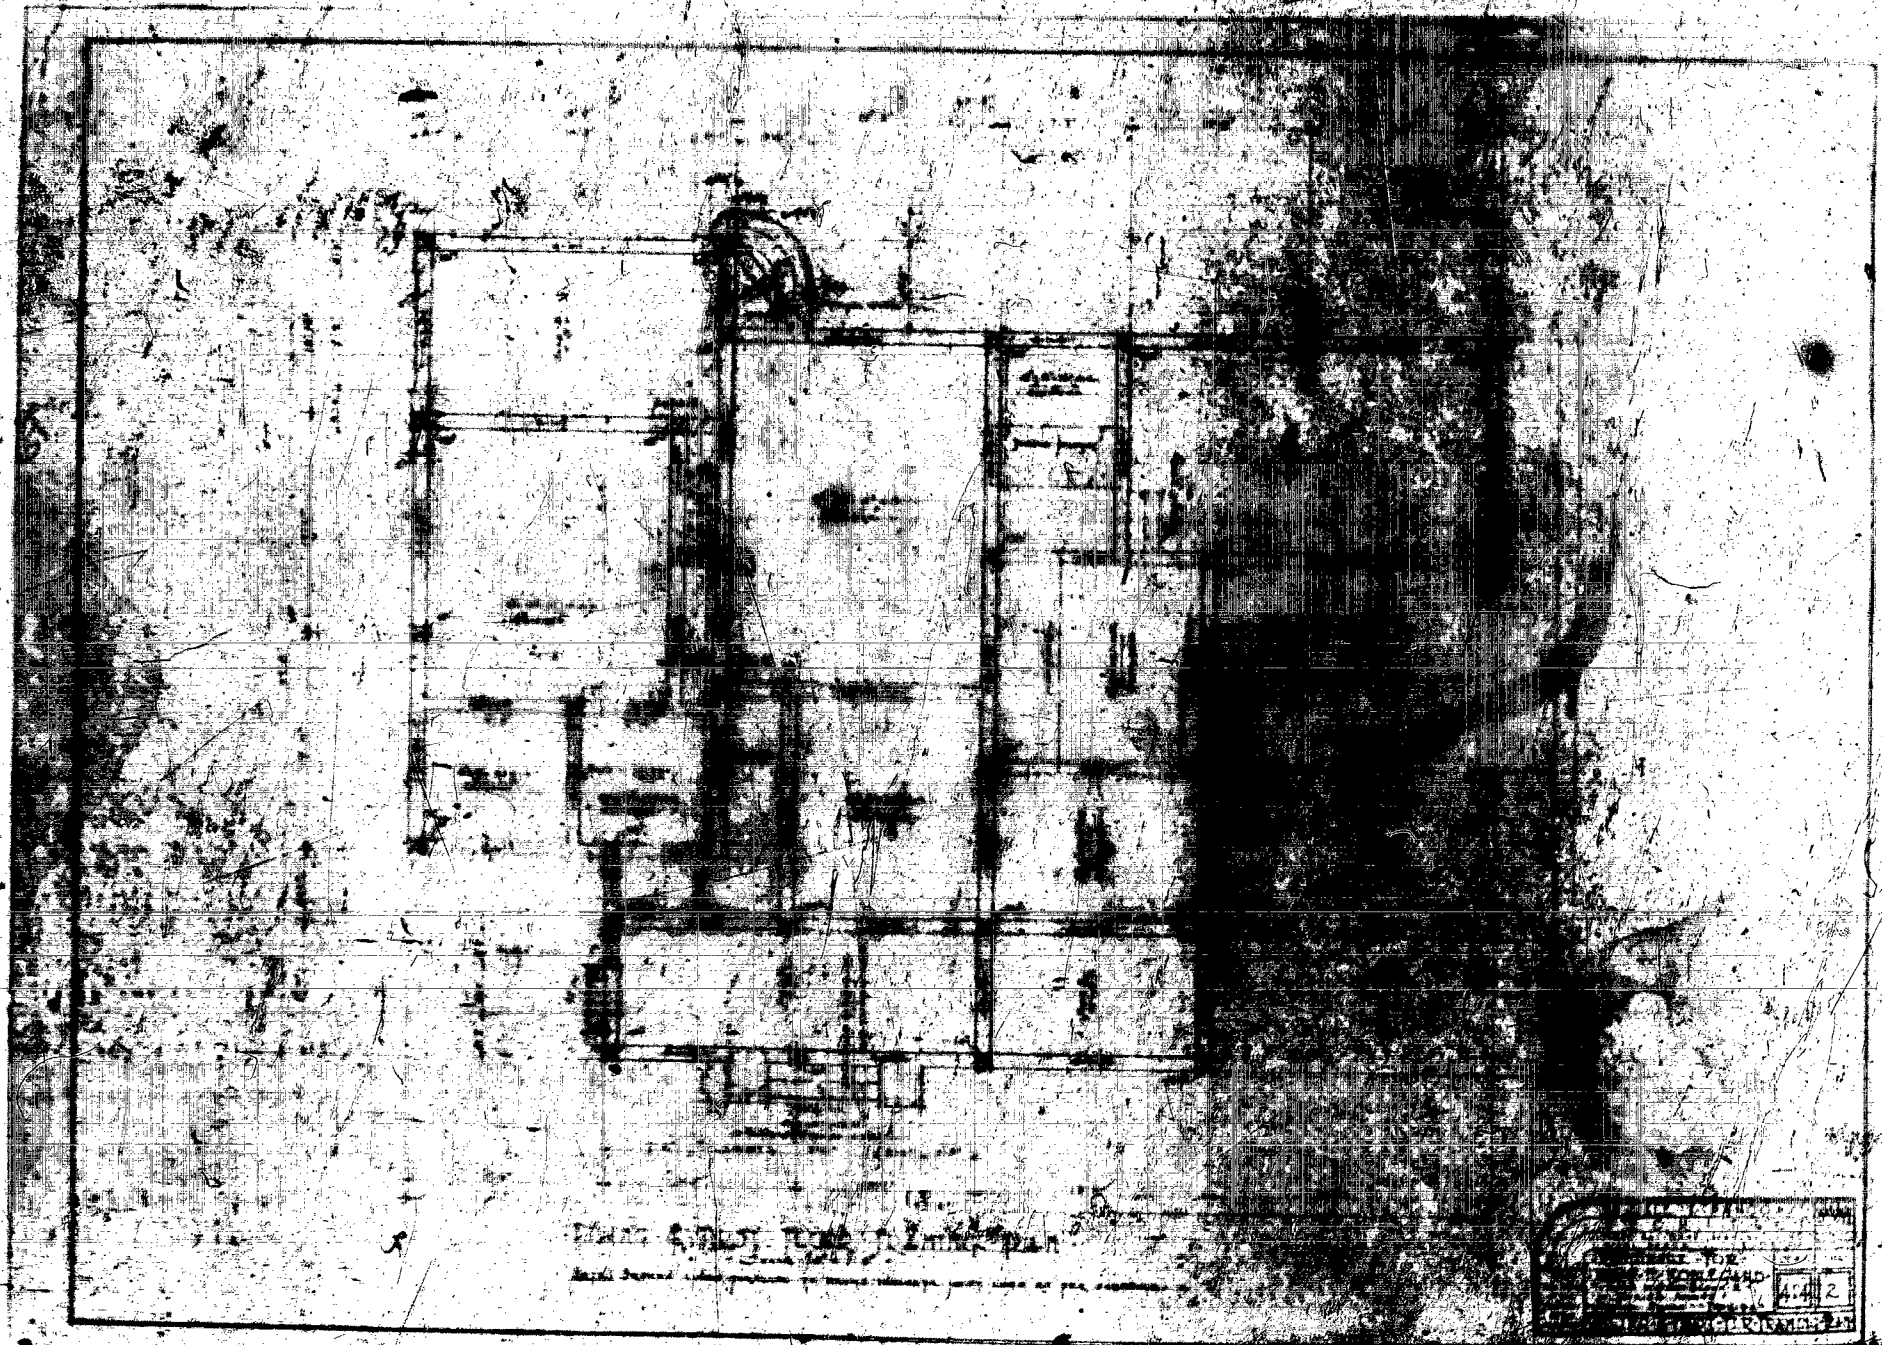

PLAN OF THE BUILDING


FOR THE
RECORDS OF THE
CITY OF
NEW YORK
1882




at the window

9482

FOR SALE

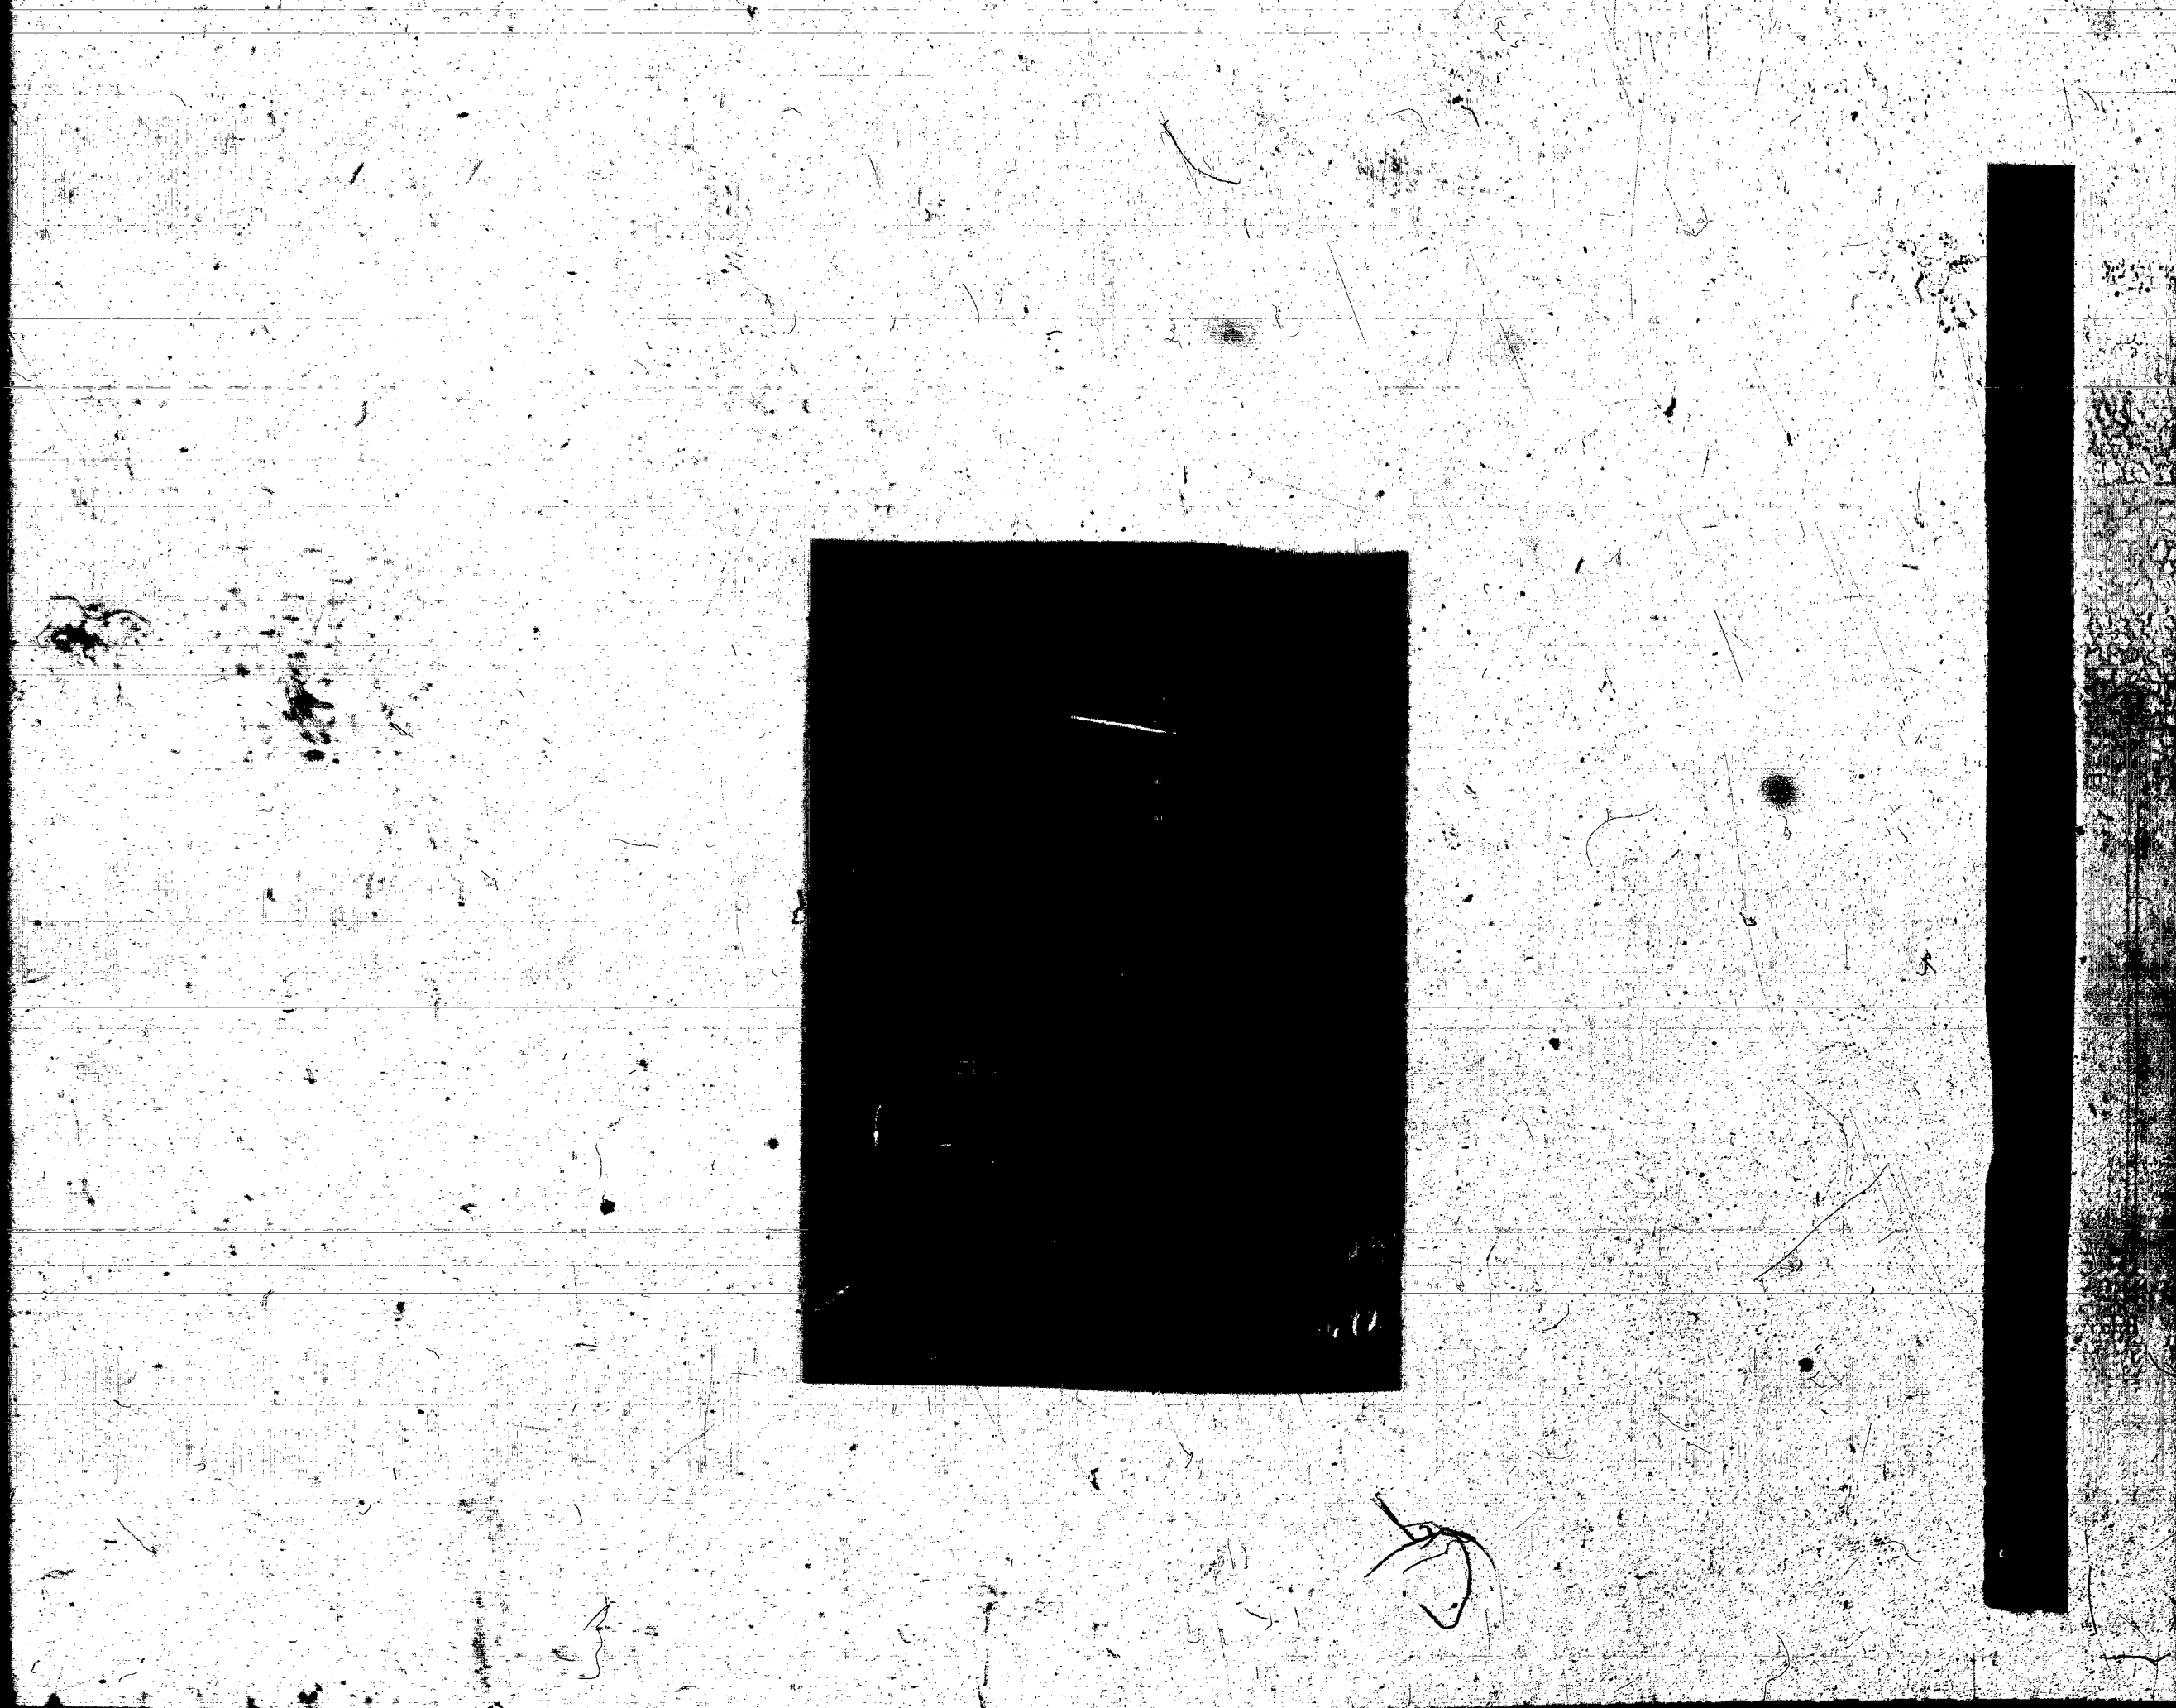

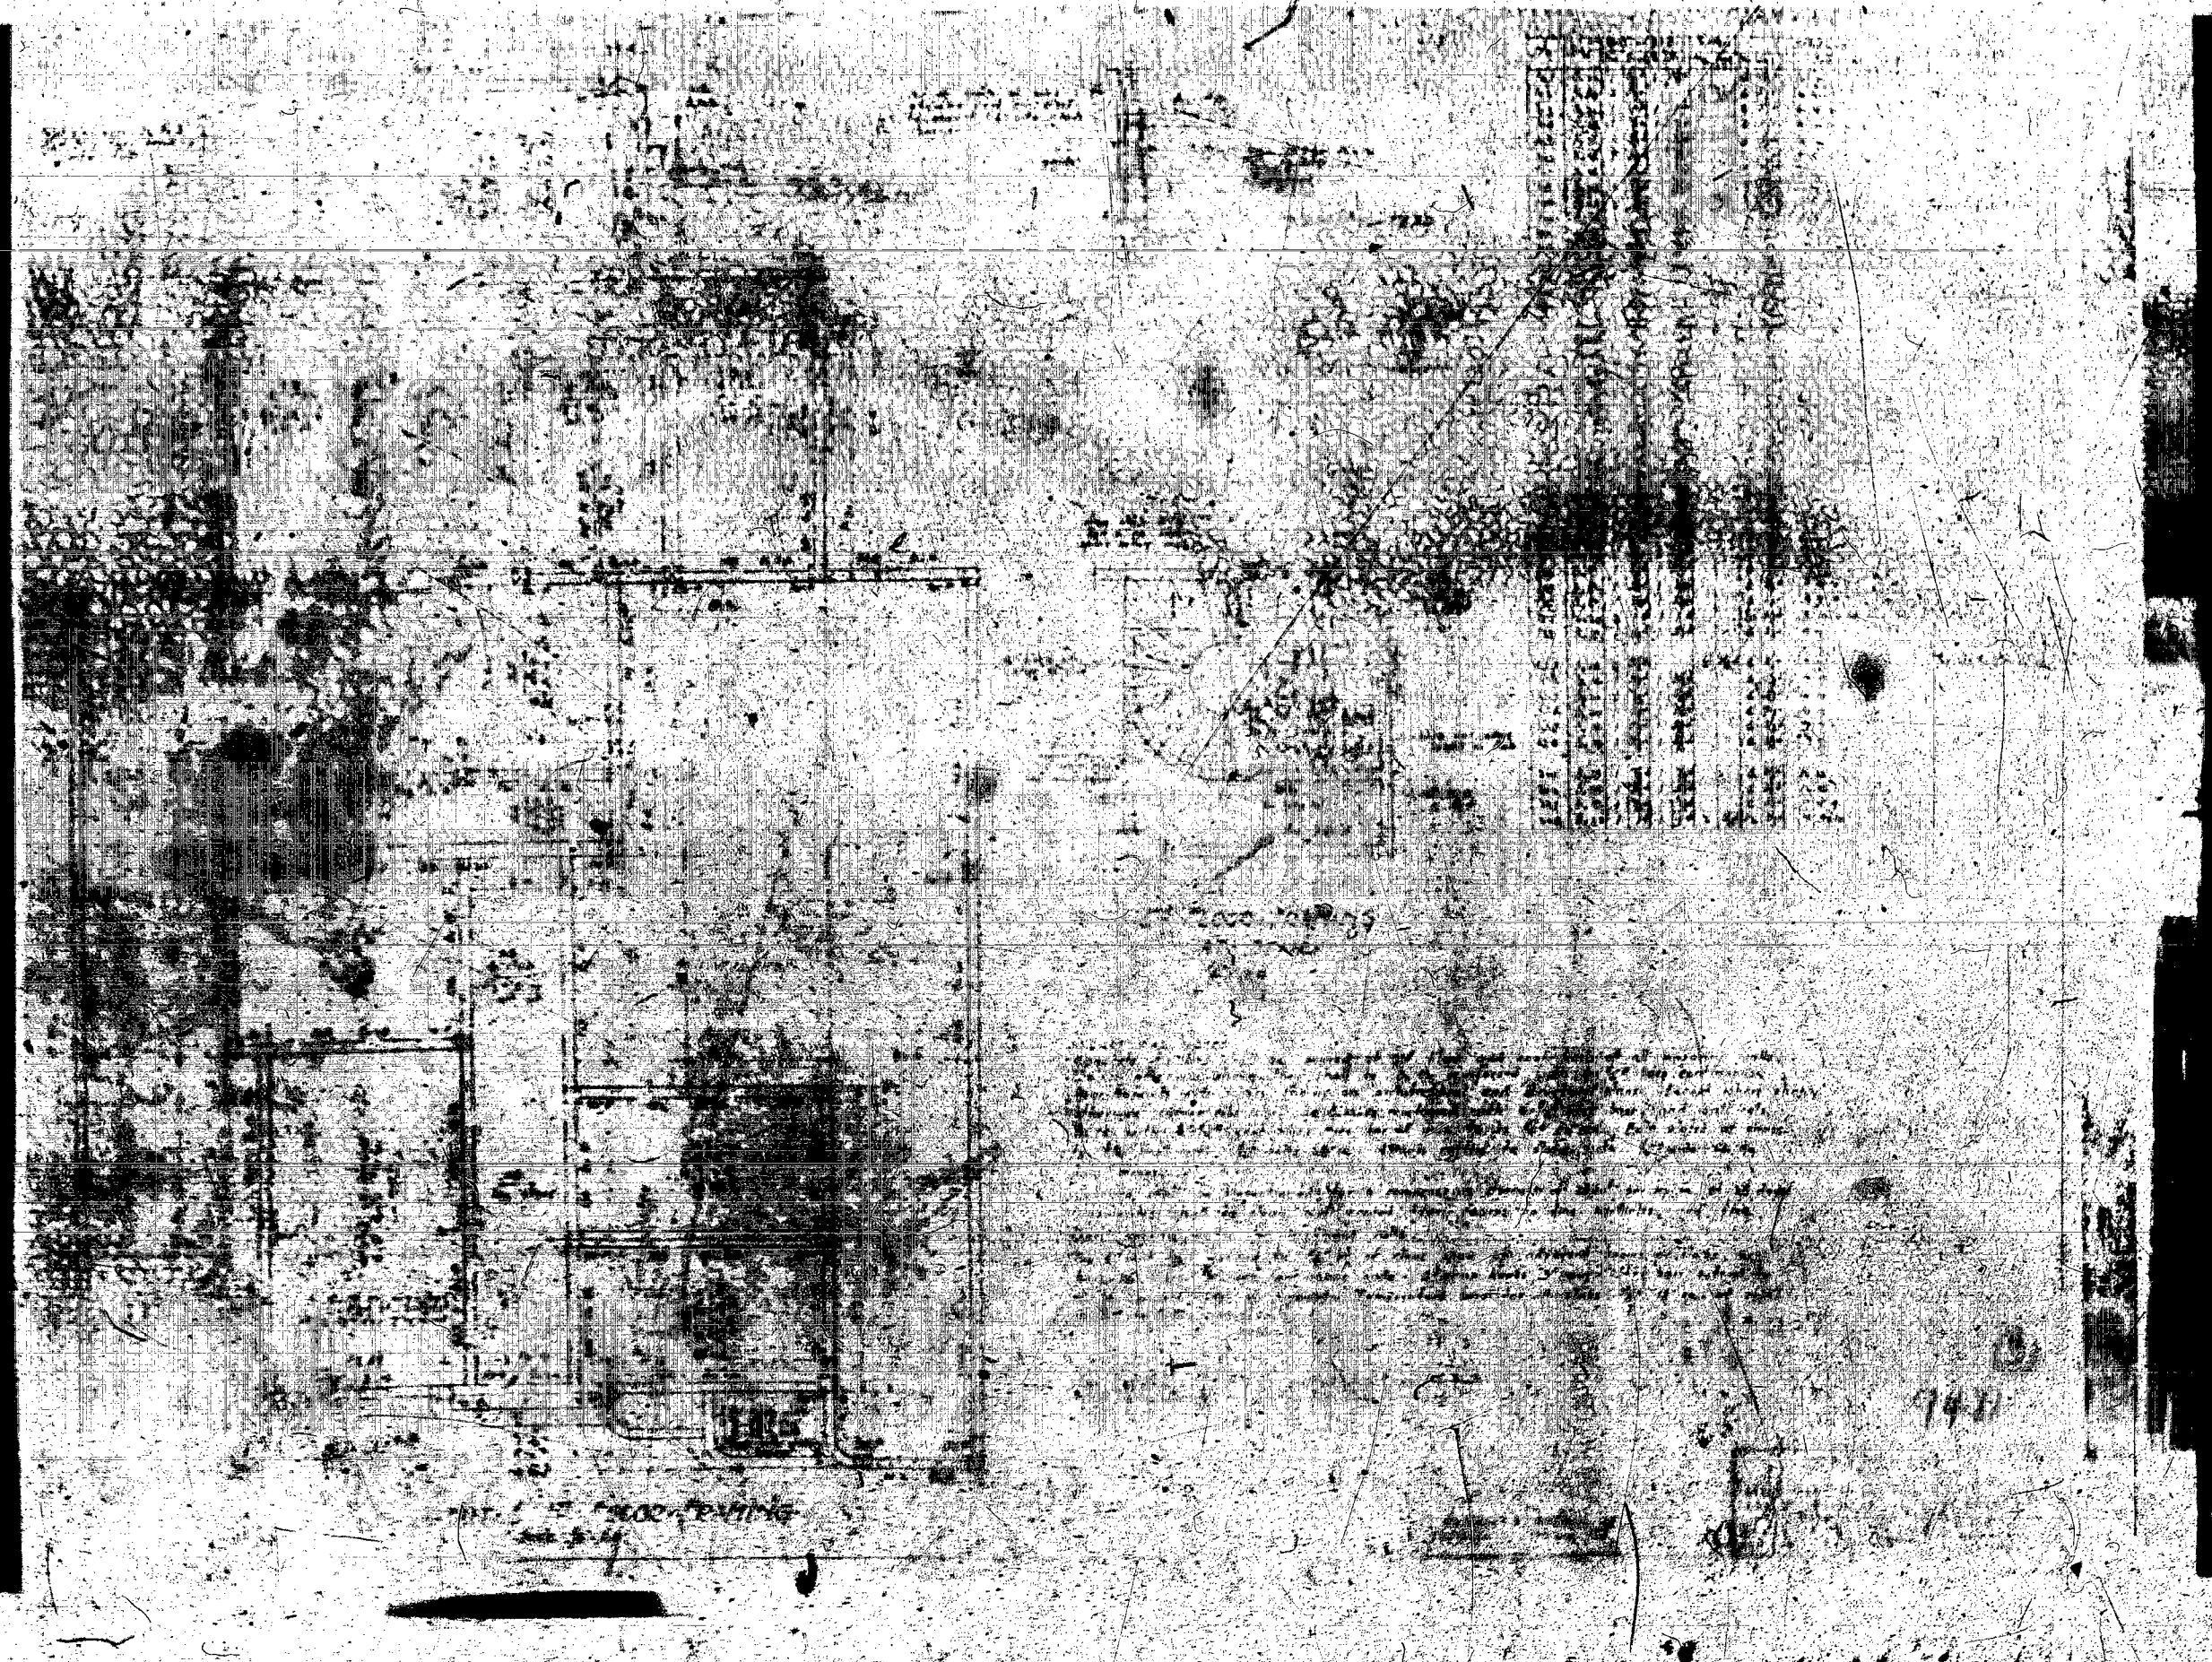


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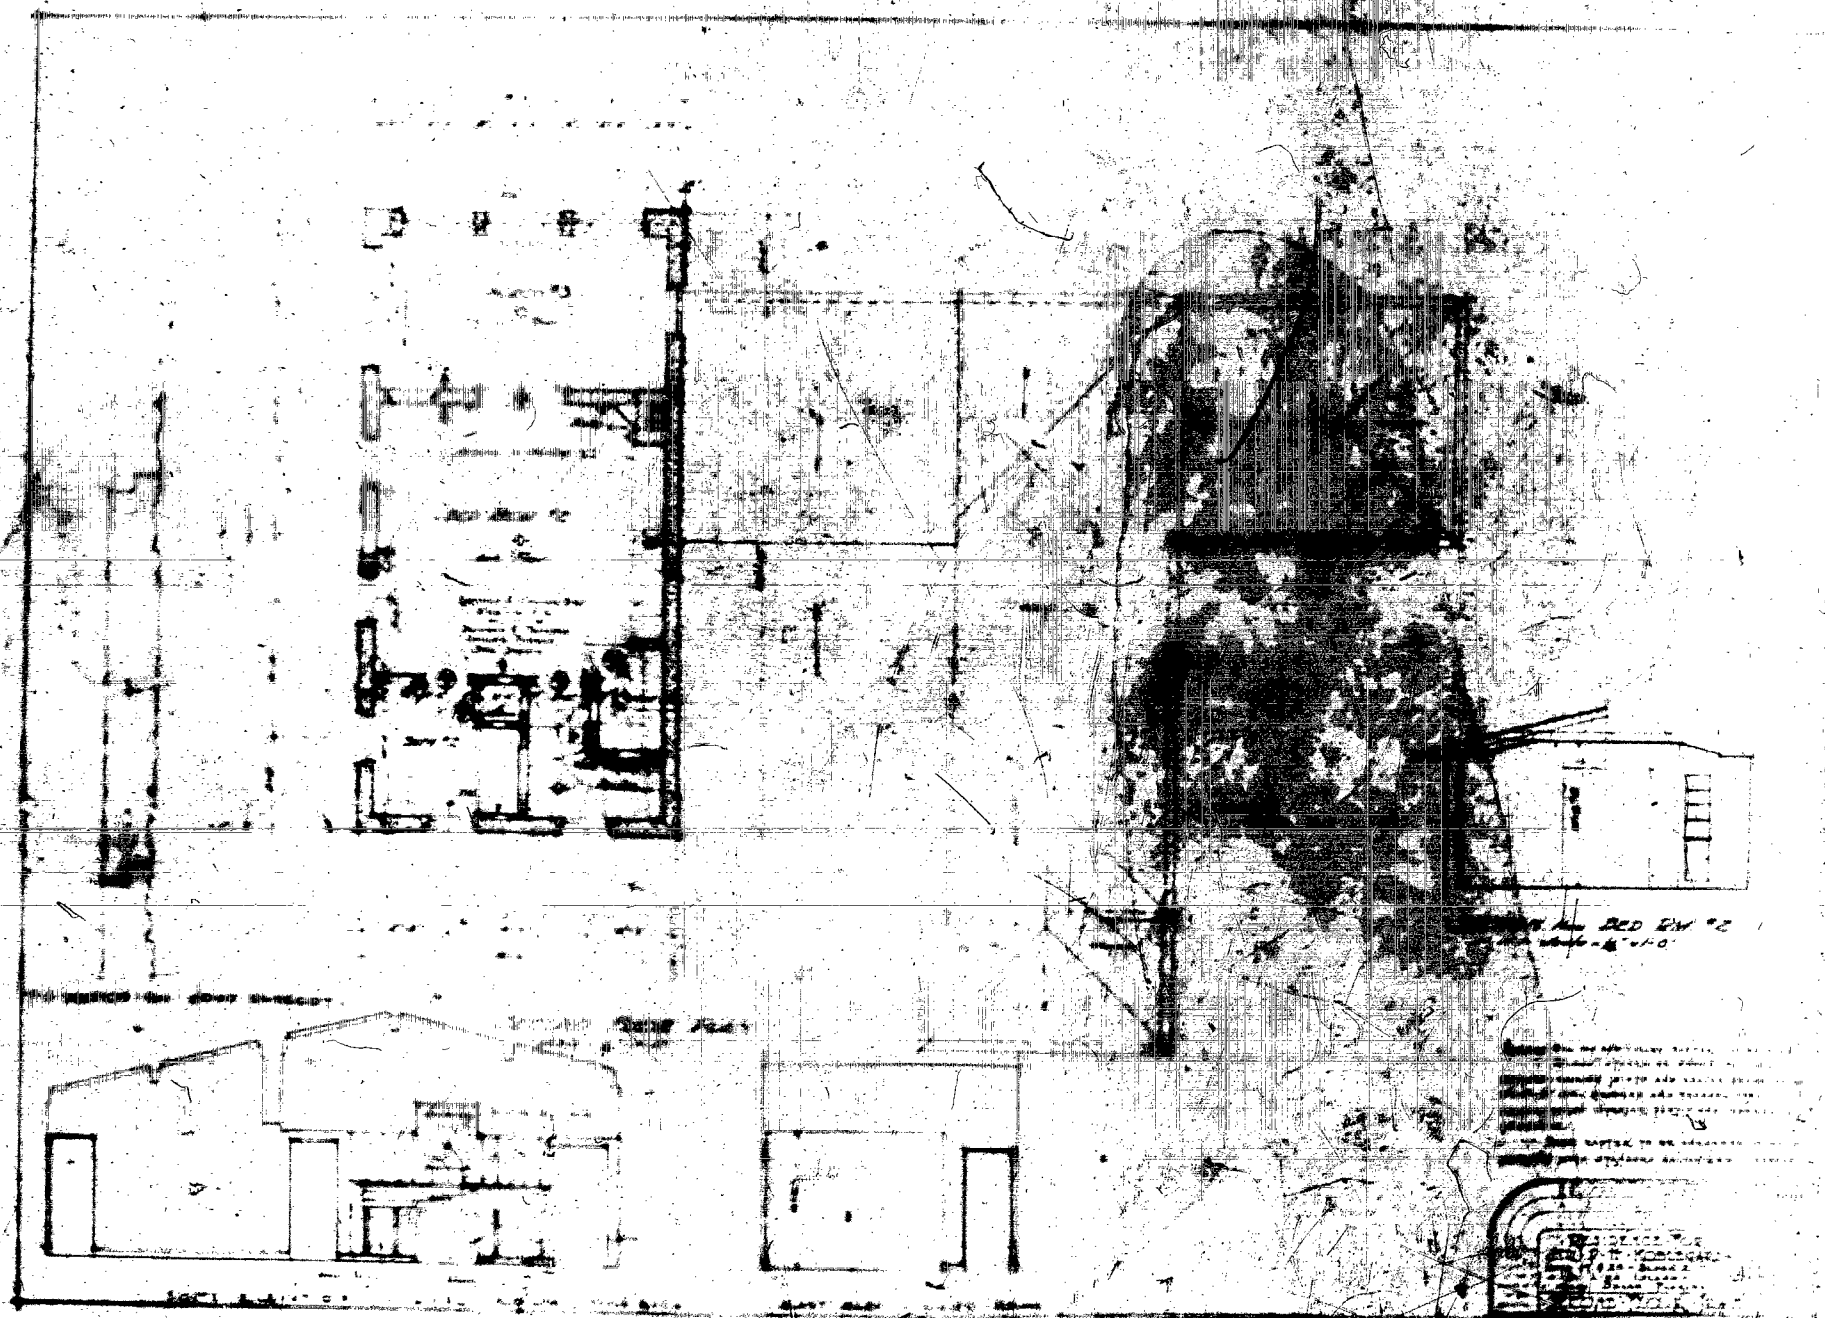


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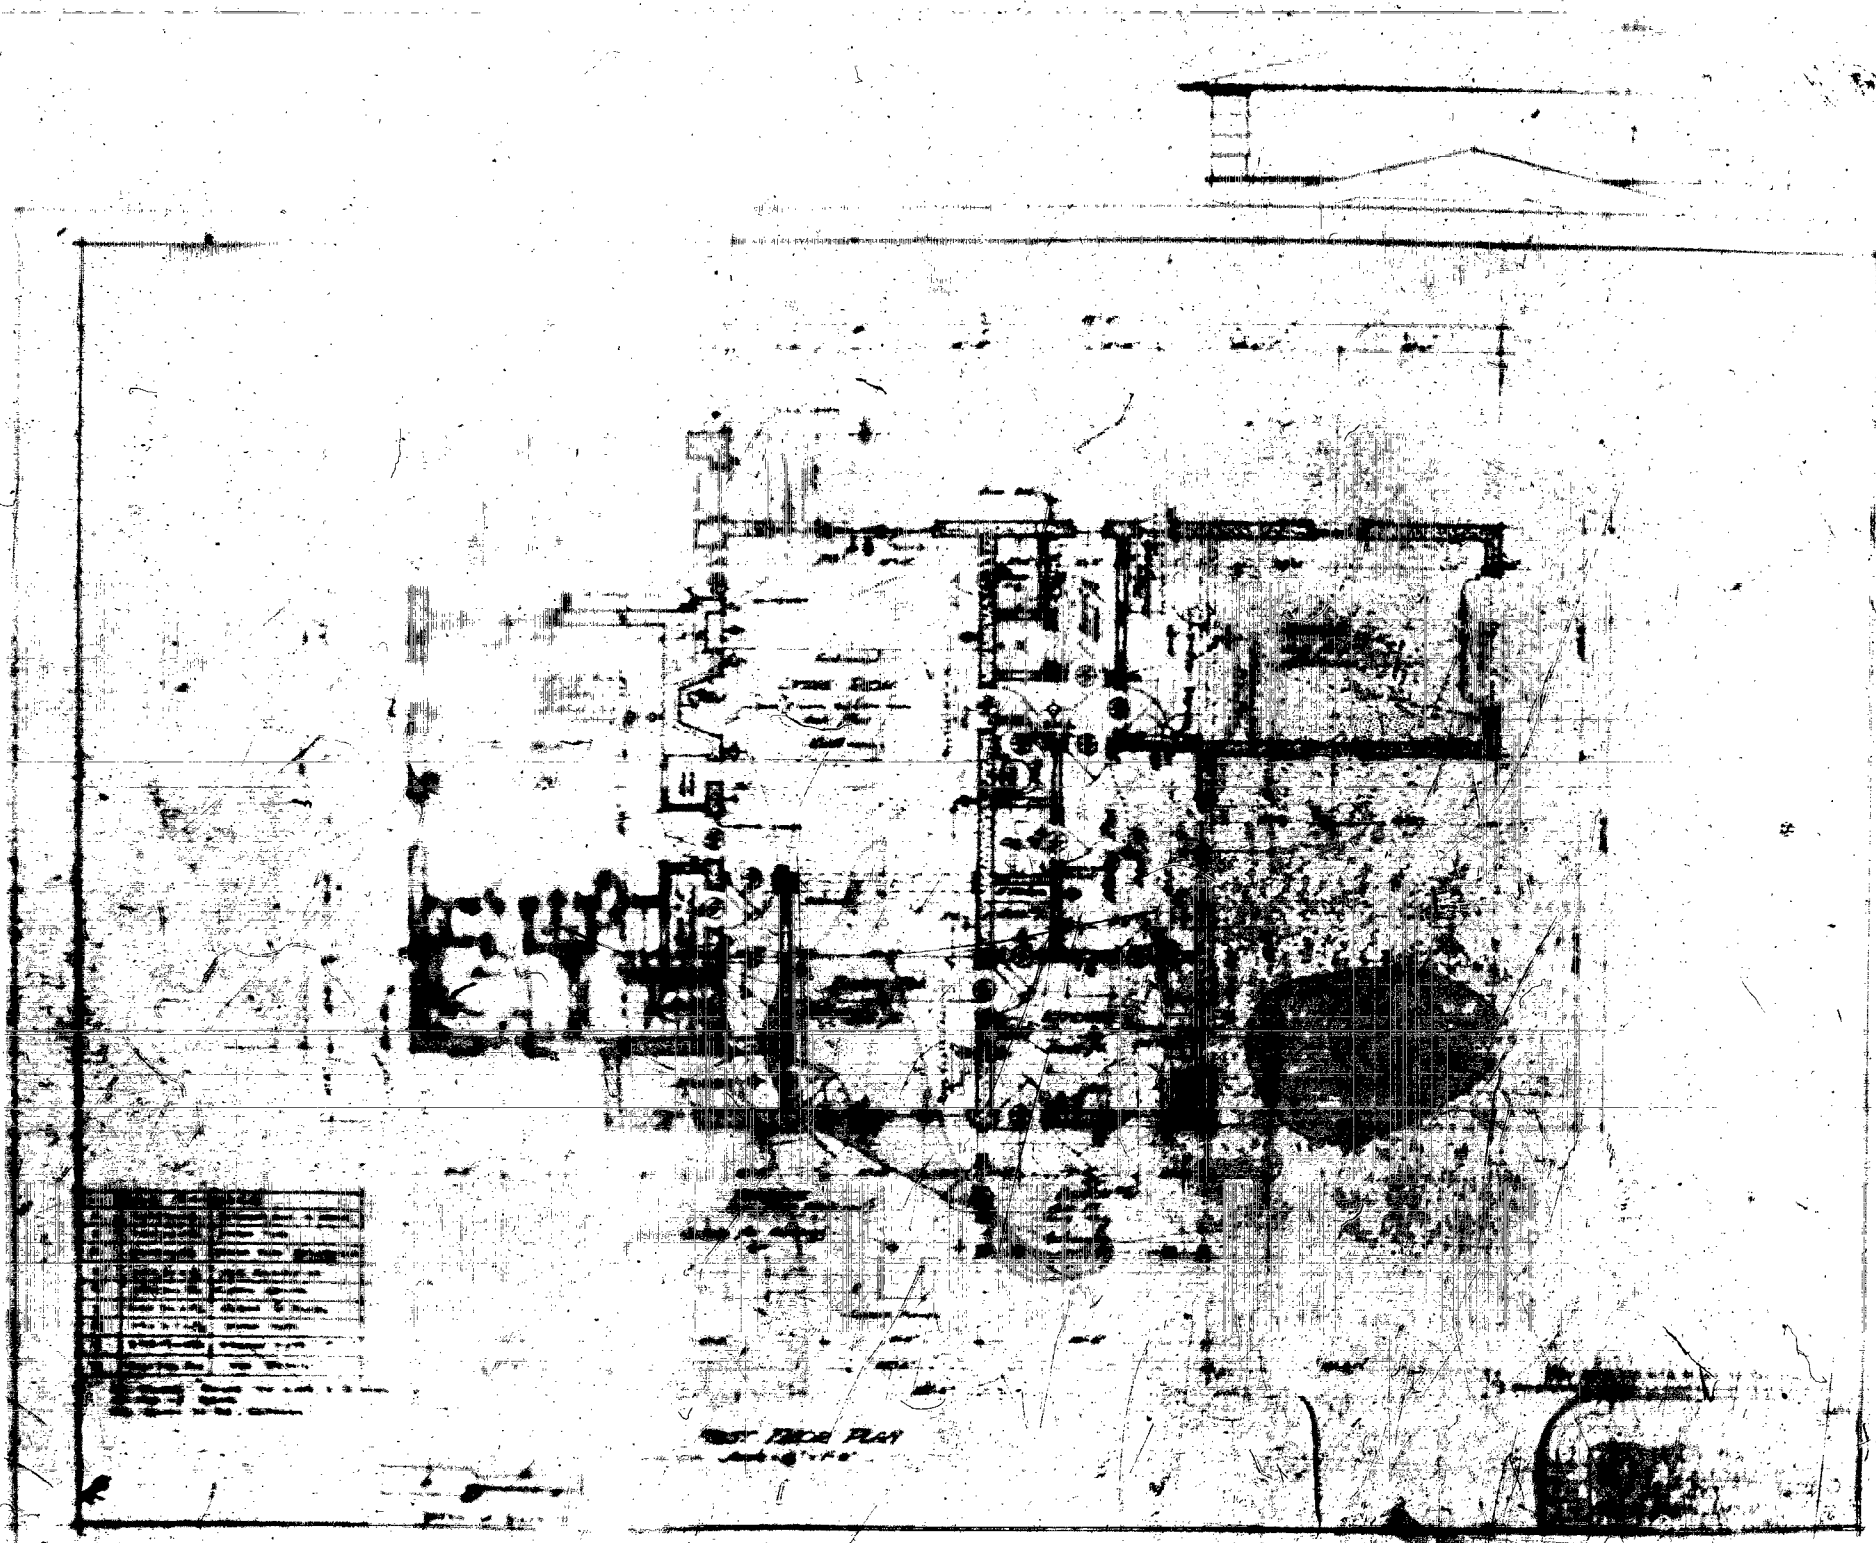


PLAN OF BED RM #2
1/4" = 1'-0"

SECTION THROUGH BUILDING
1/4" = 1'-0"

SECTION THROUGH BUILDING
1/4" = 1'-0"

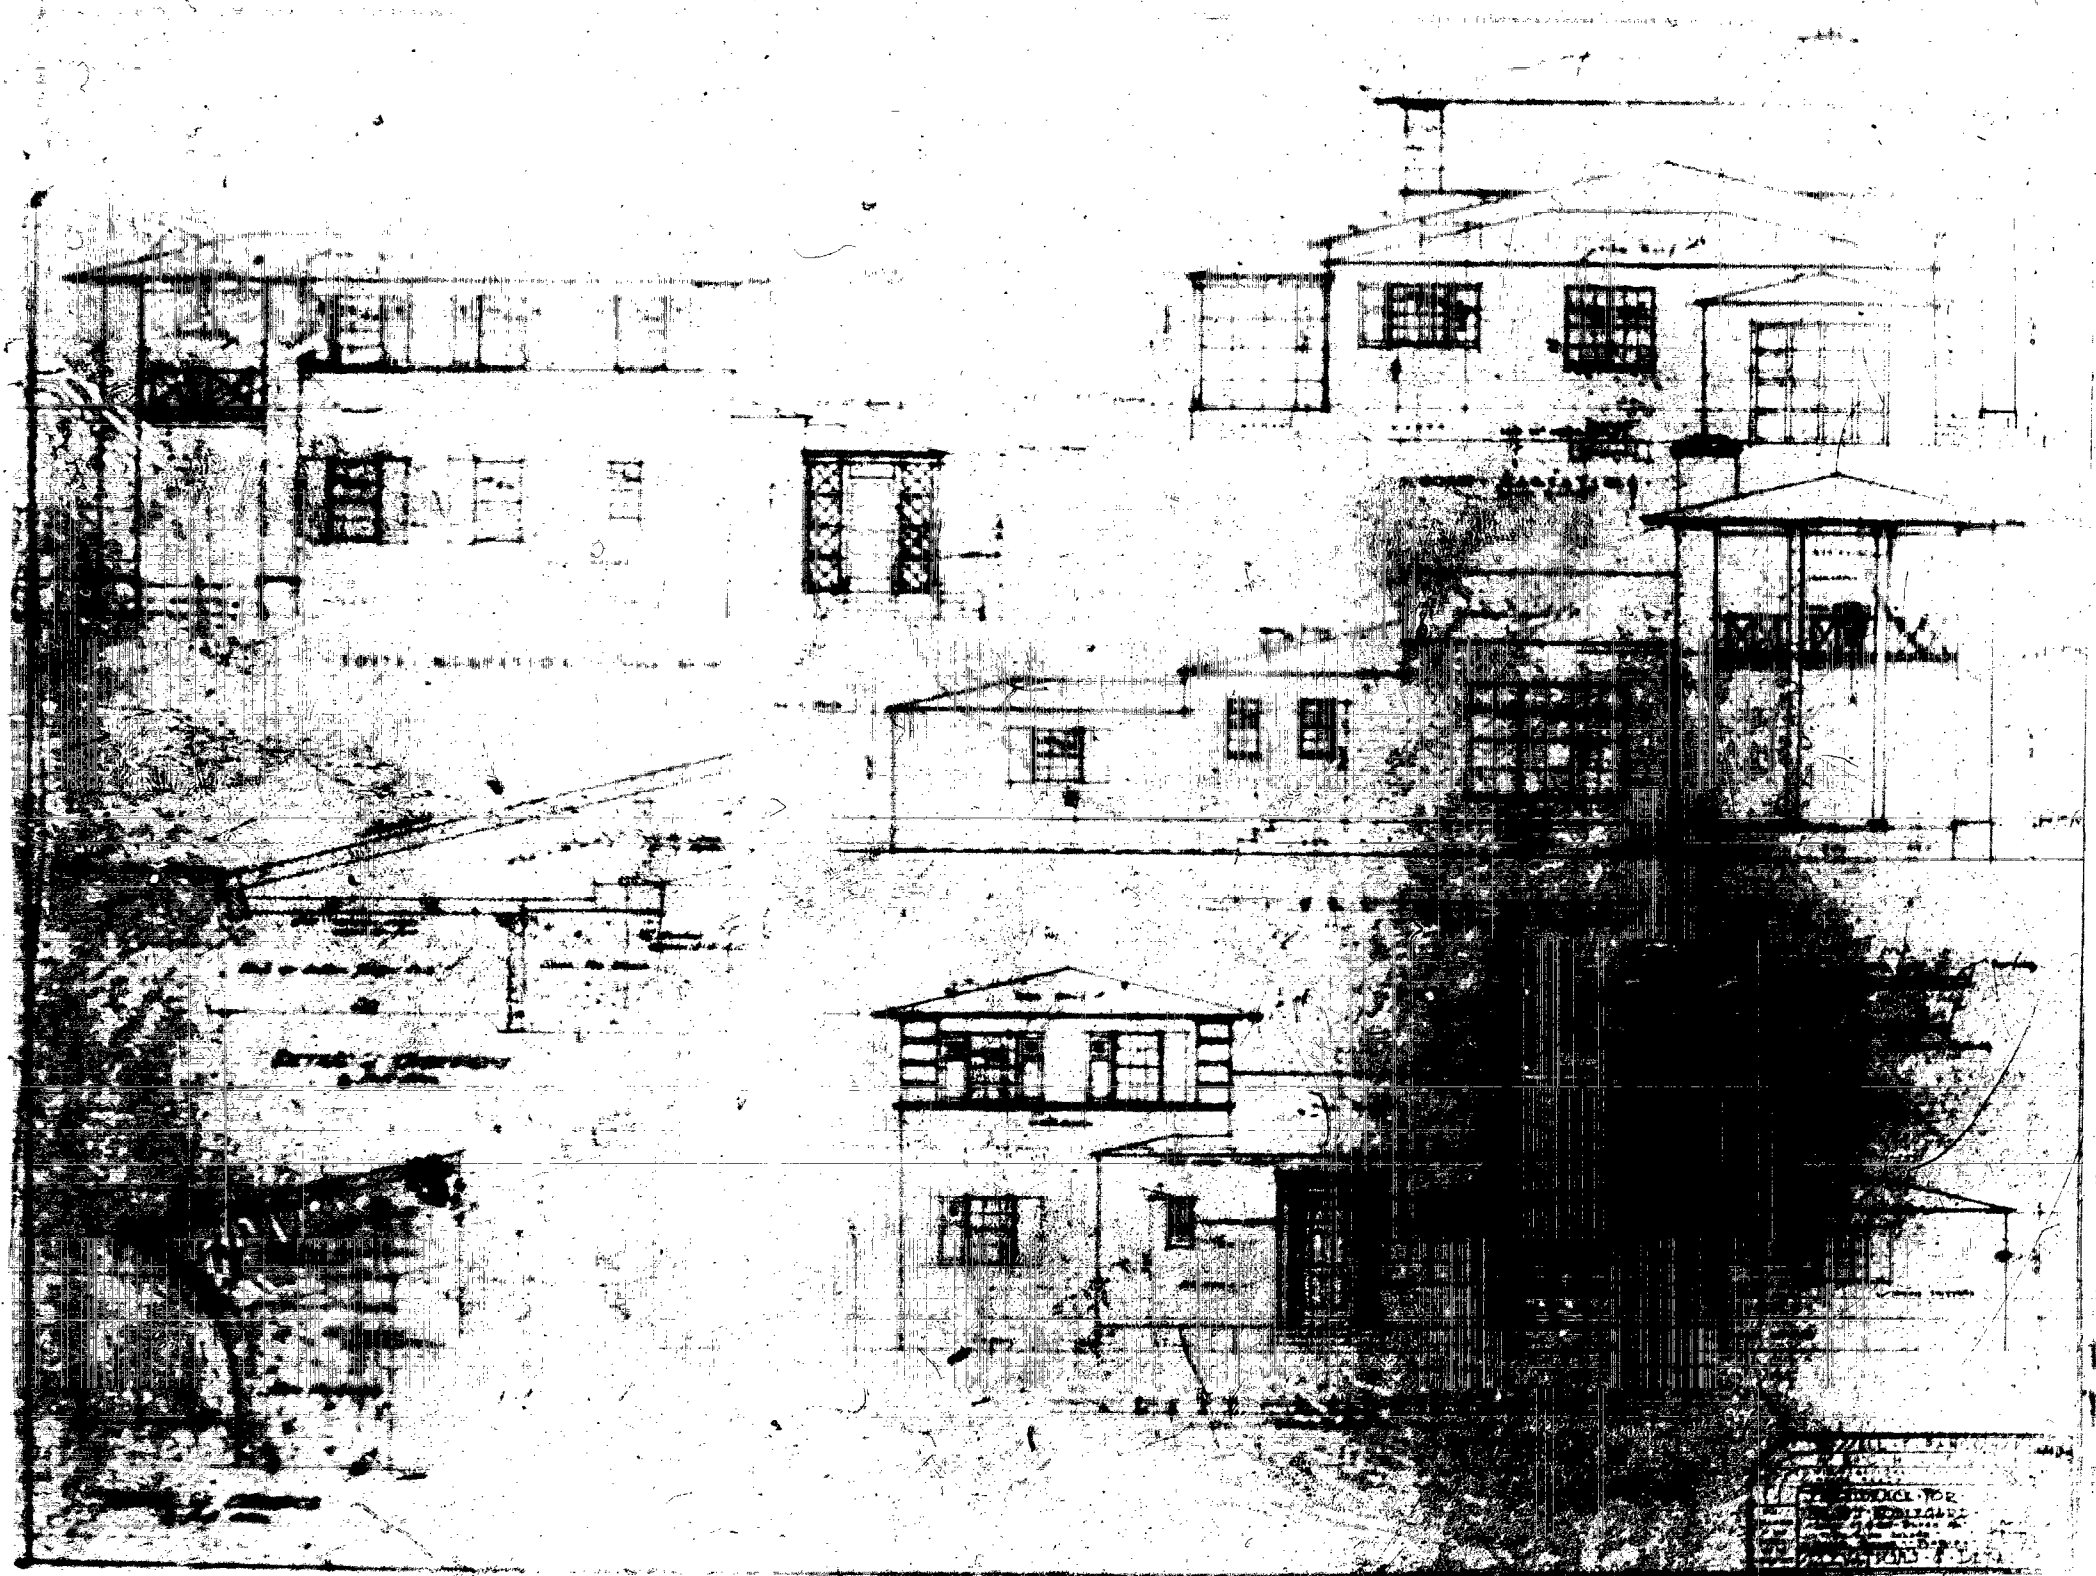





WEST SIDE PLAN

NO.	DESCRIPTION
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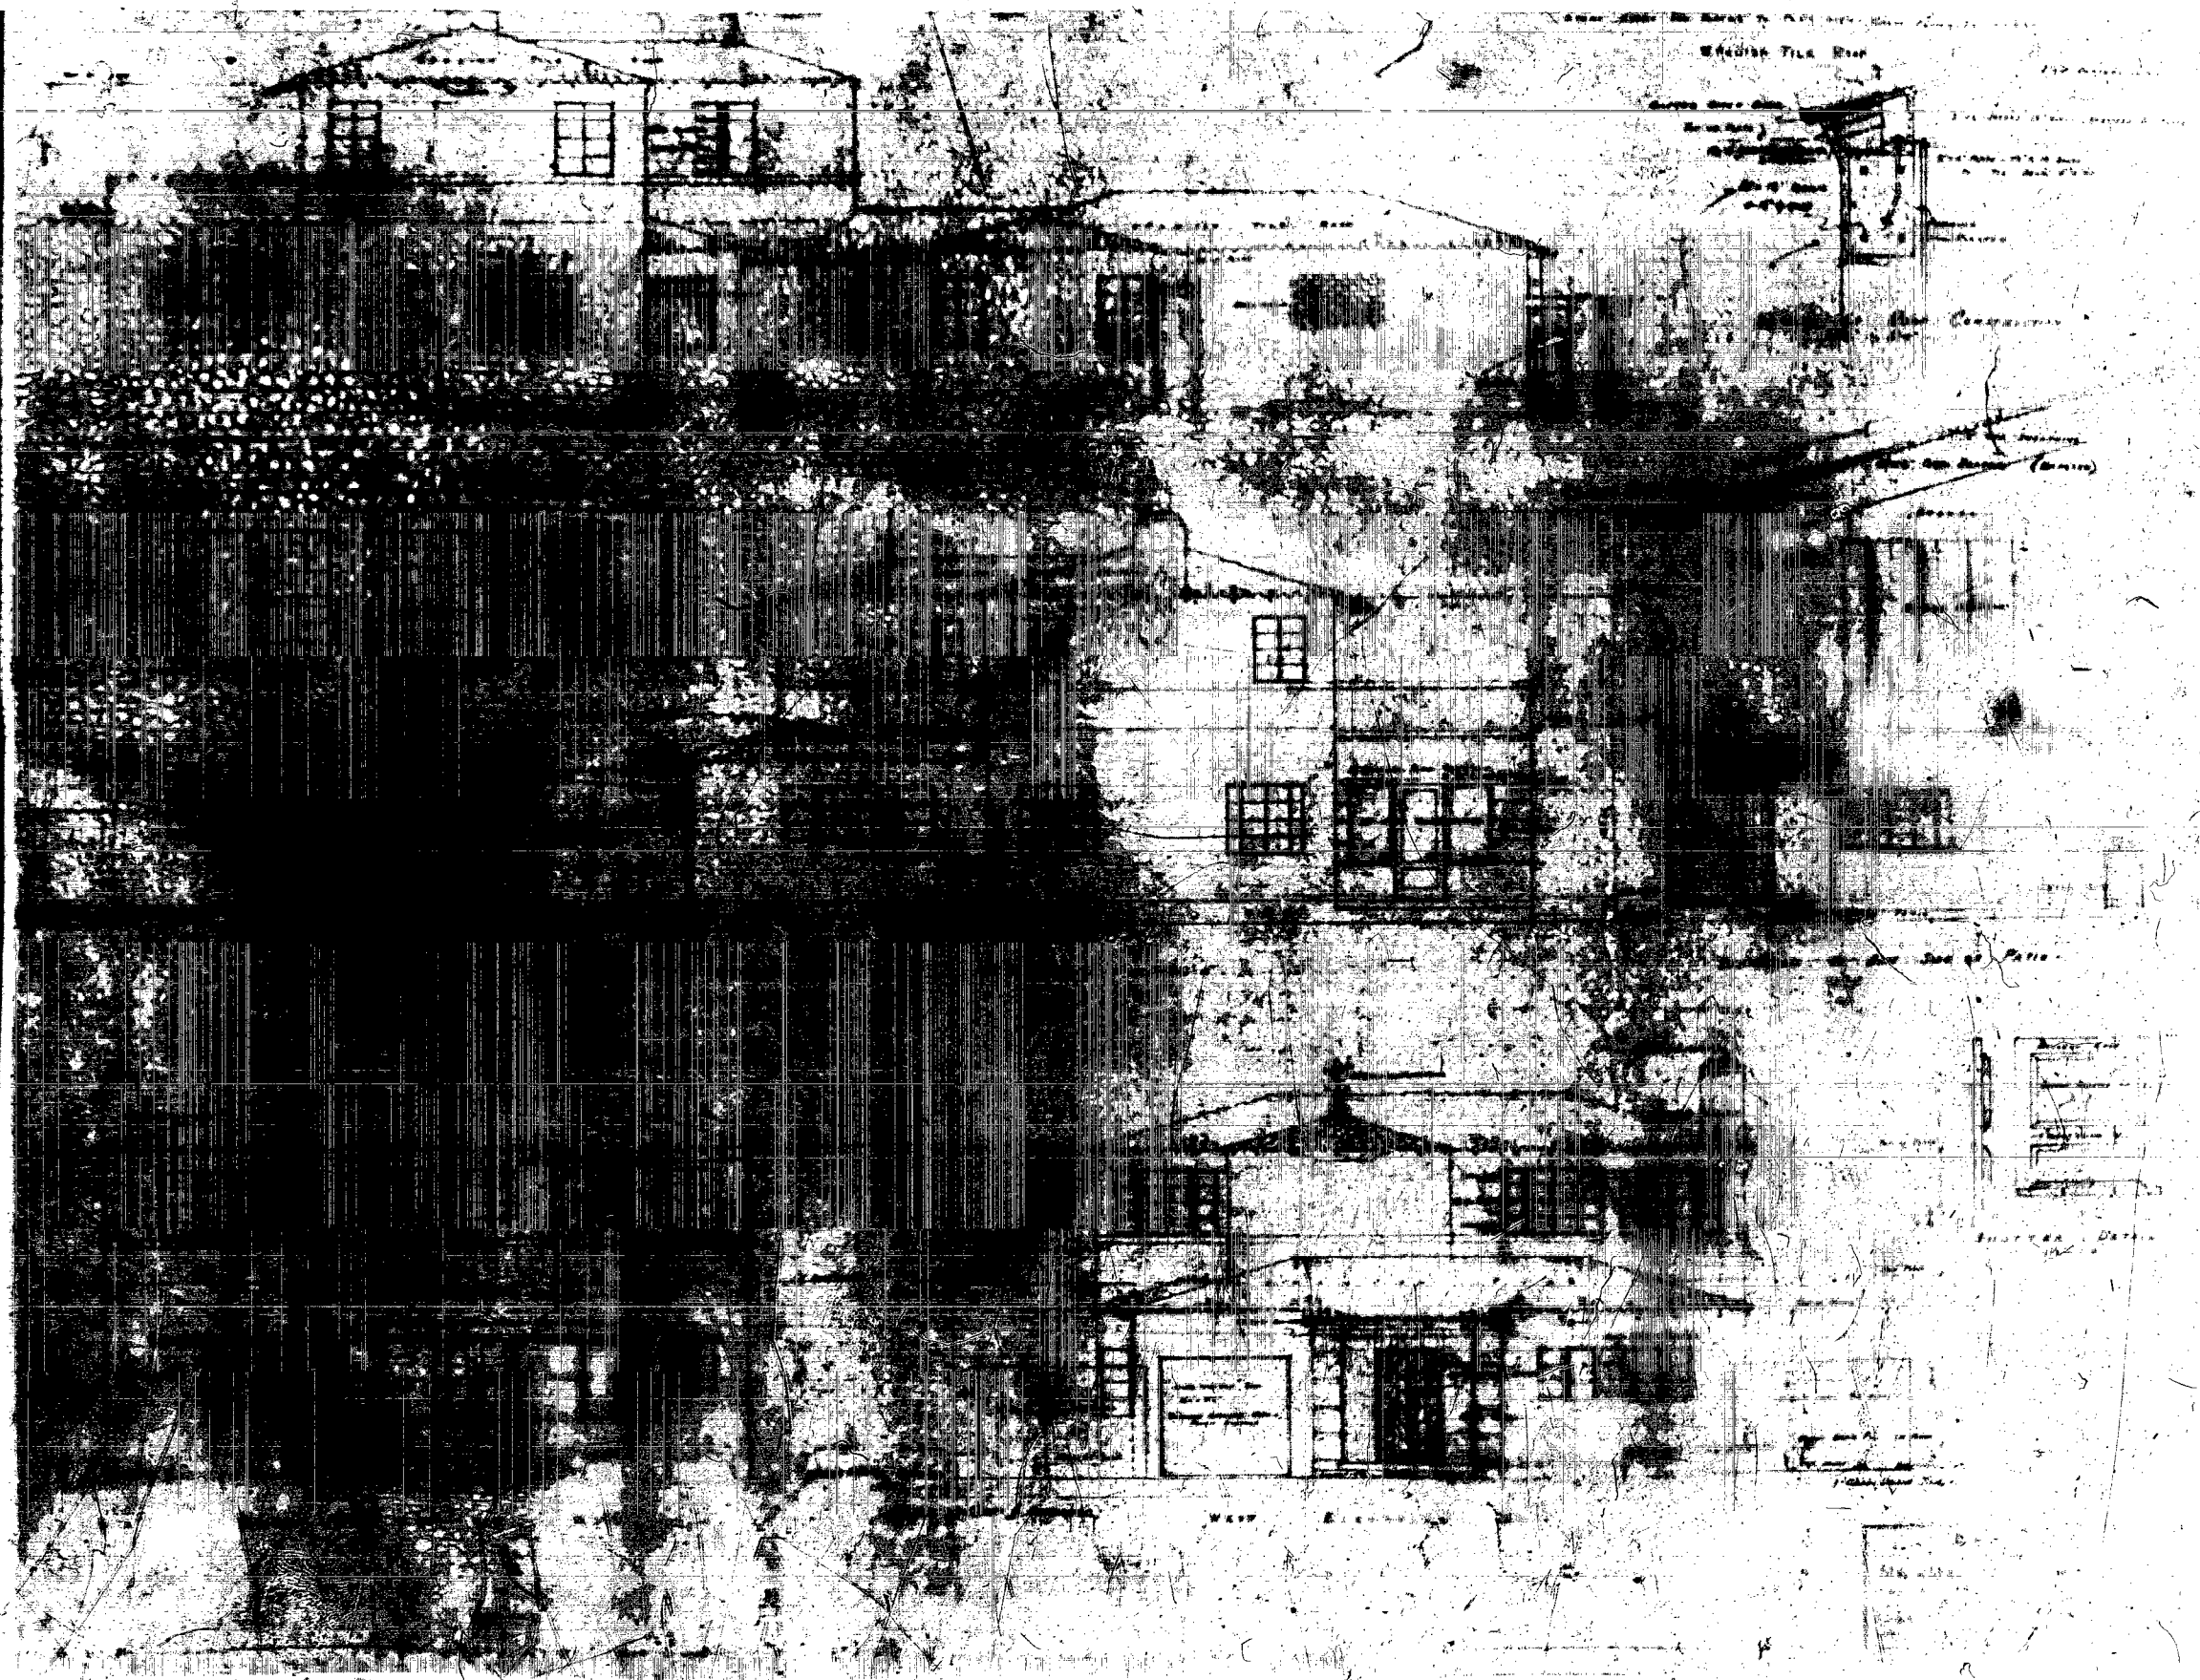





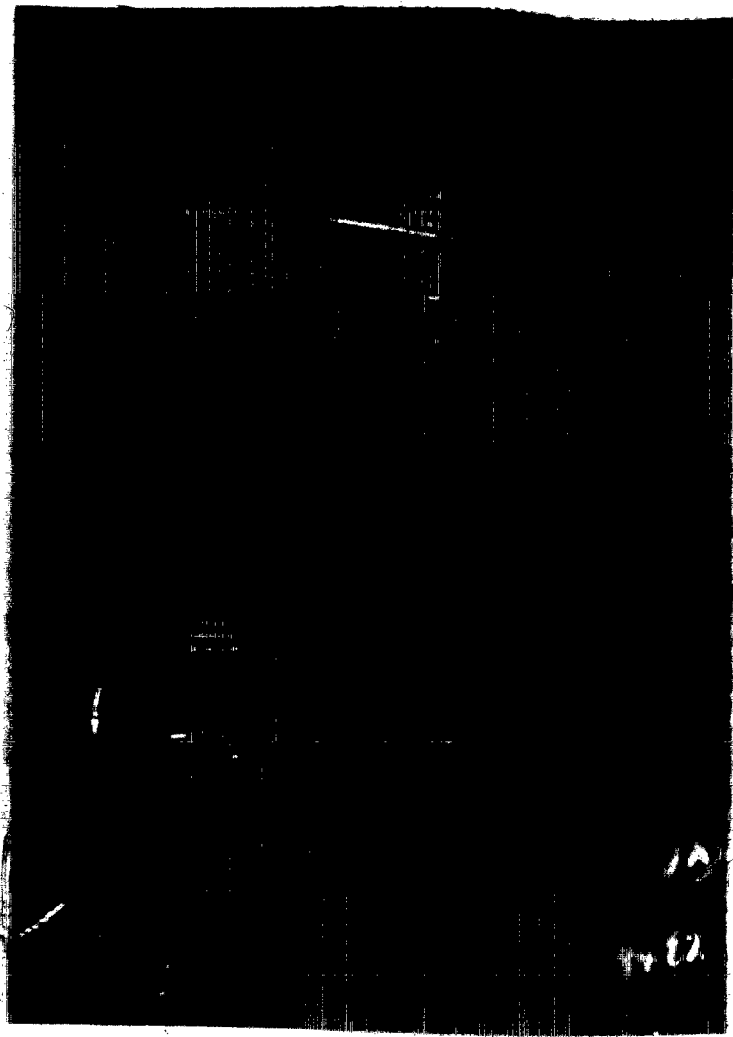

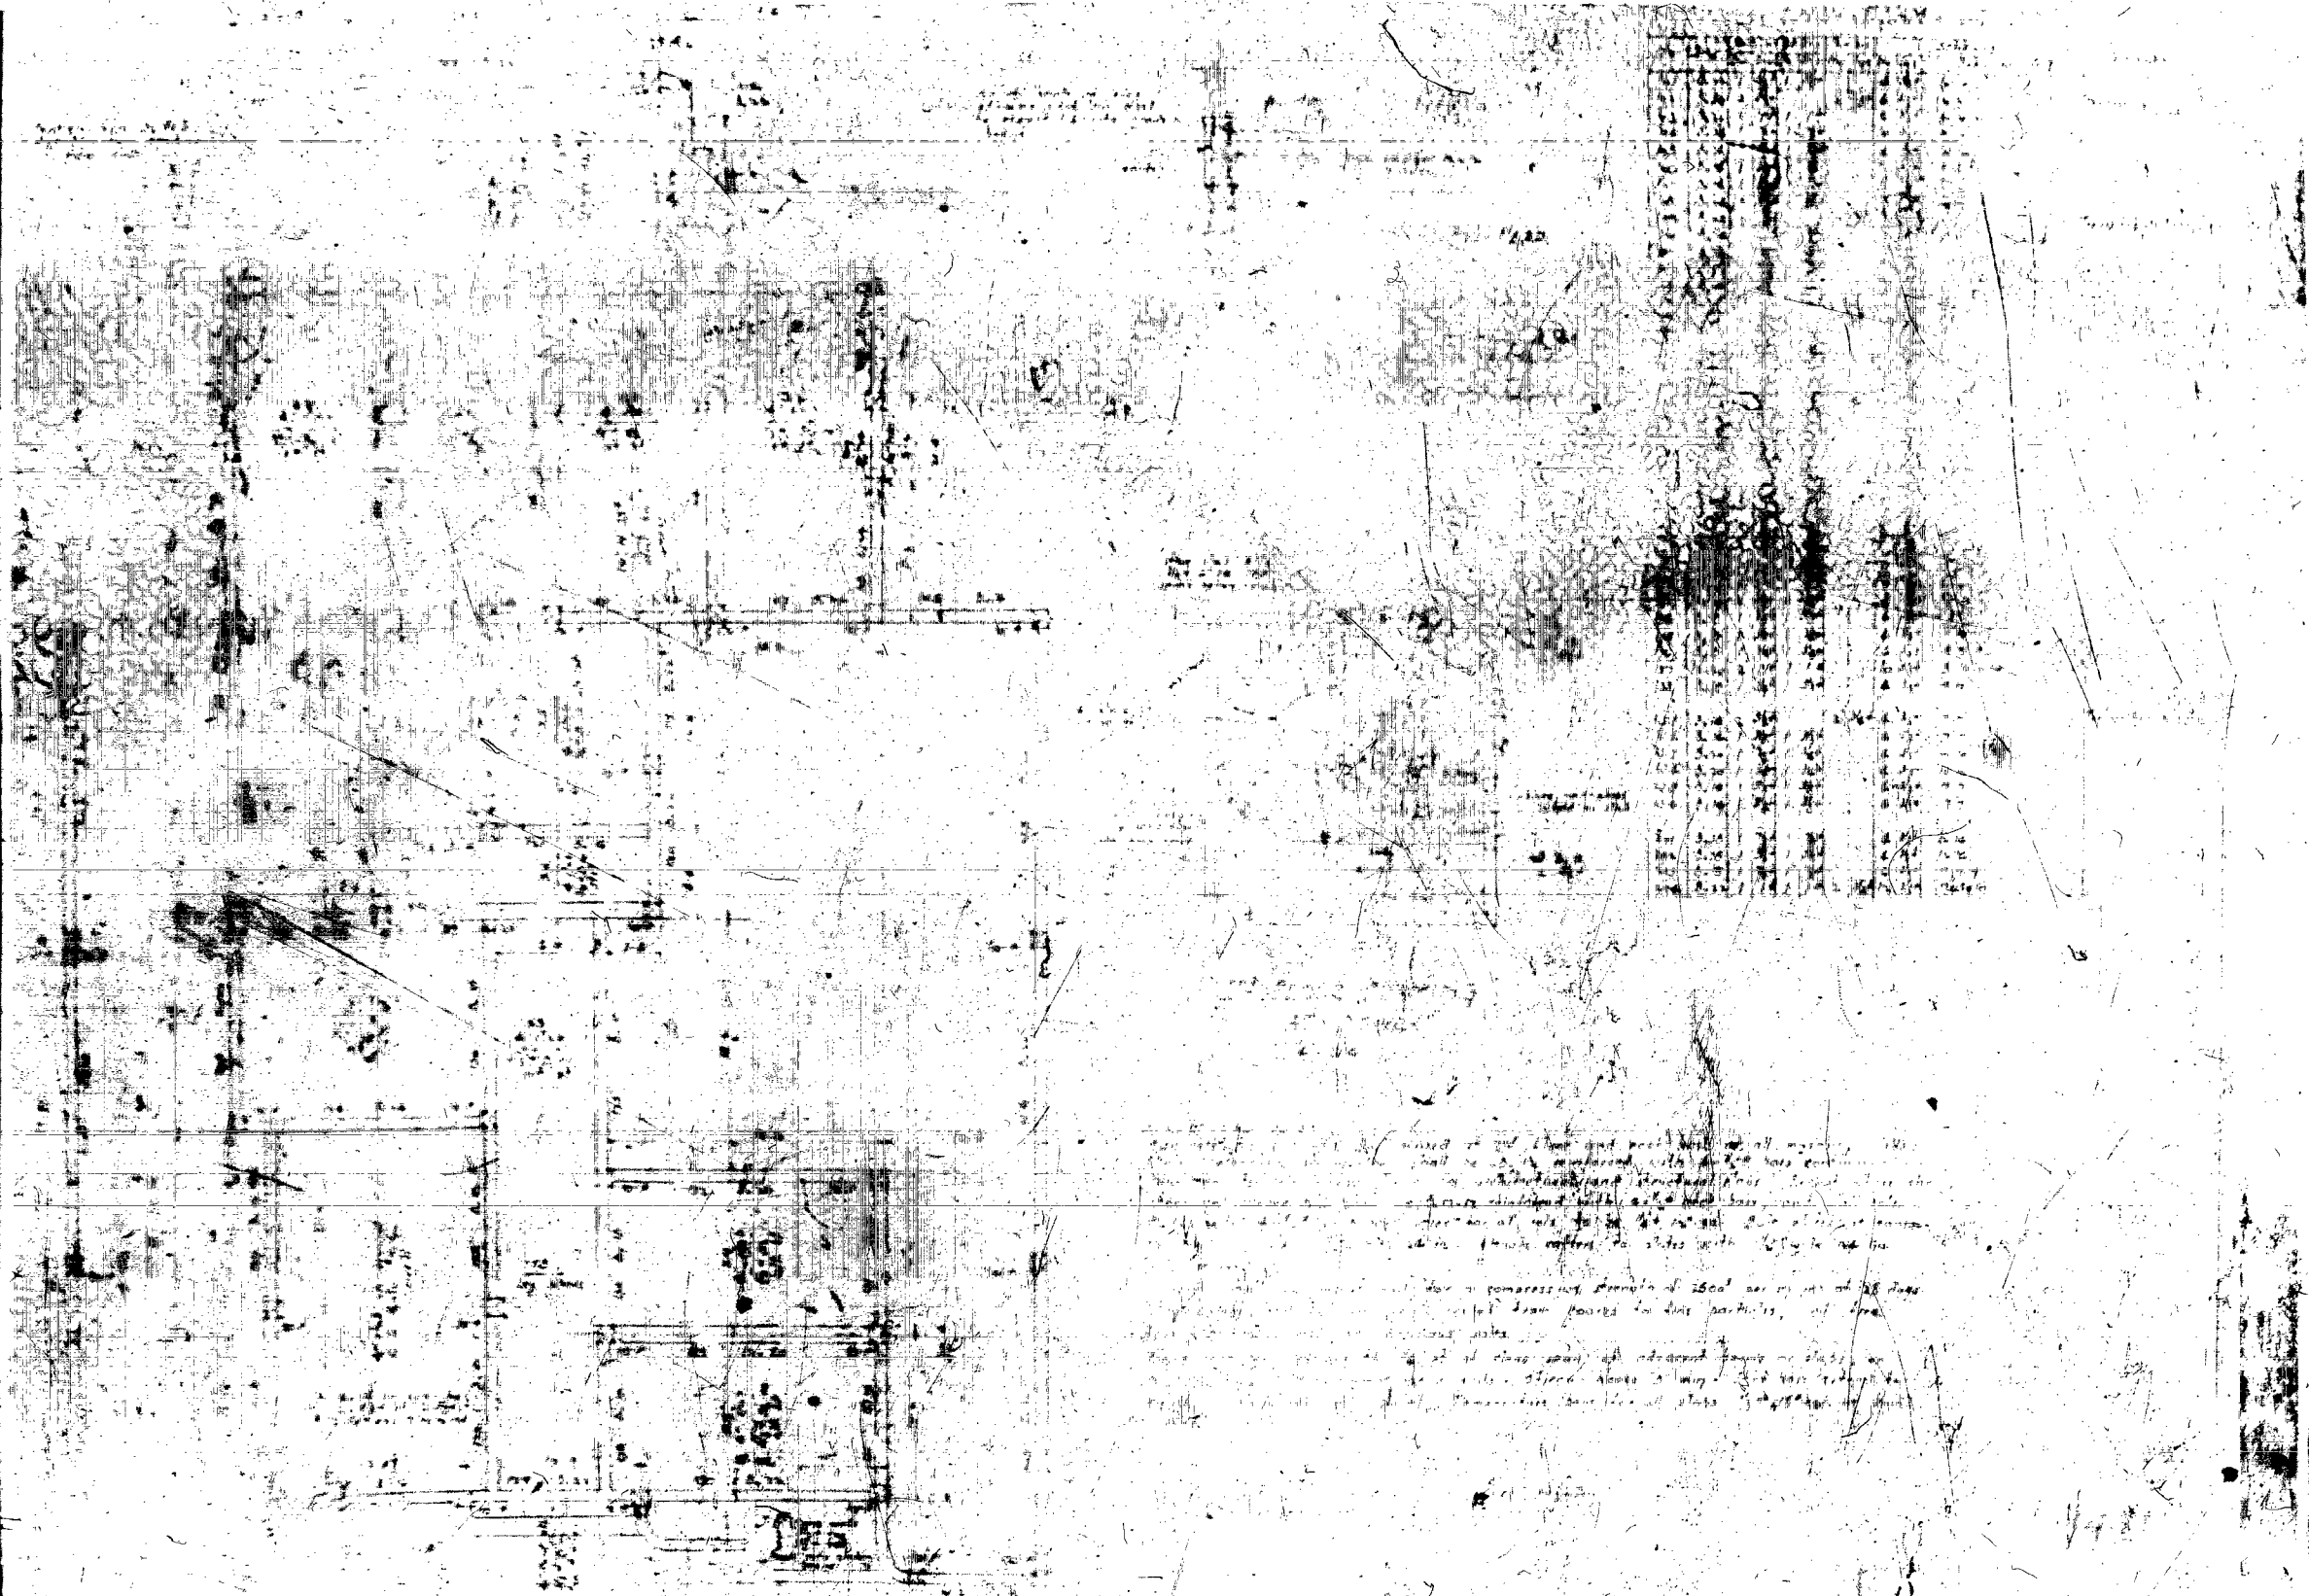
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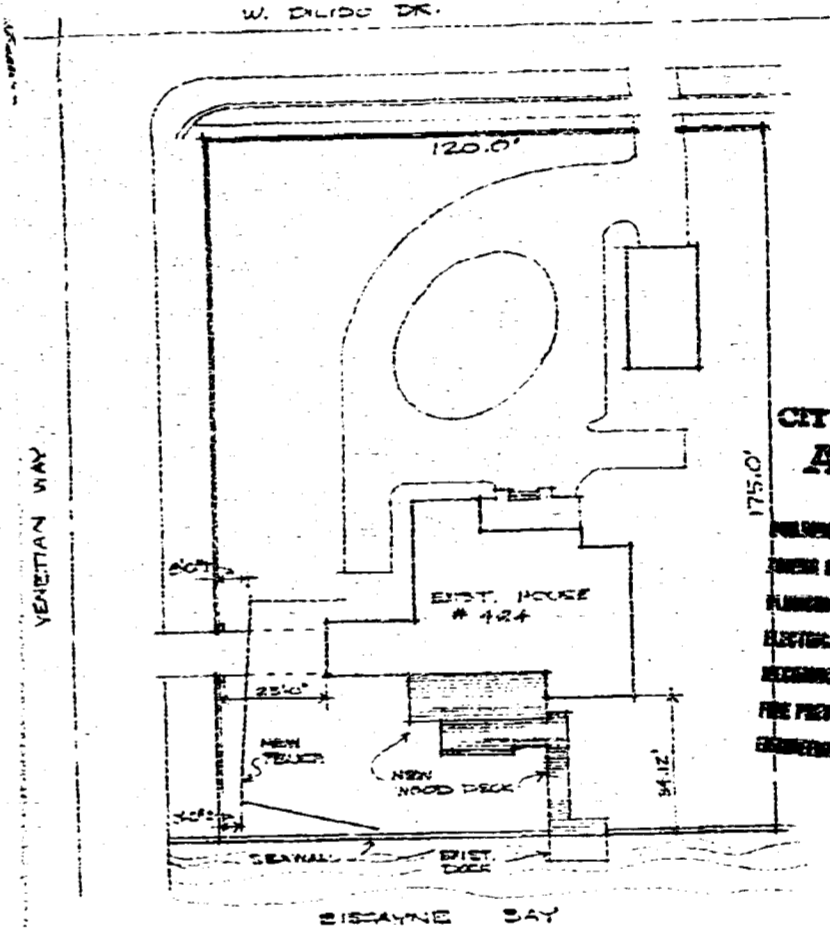




FLOOR PLAN
7/8" = 11'-0"

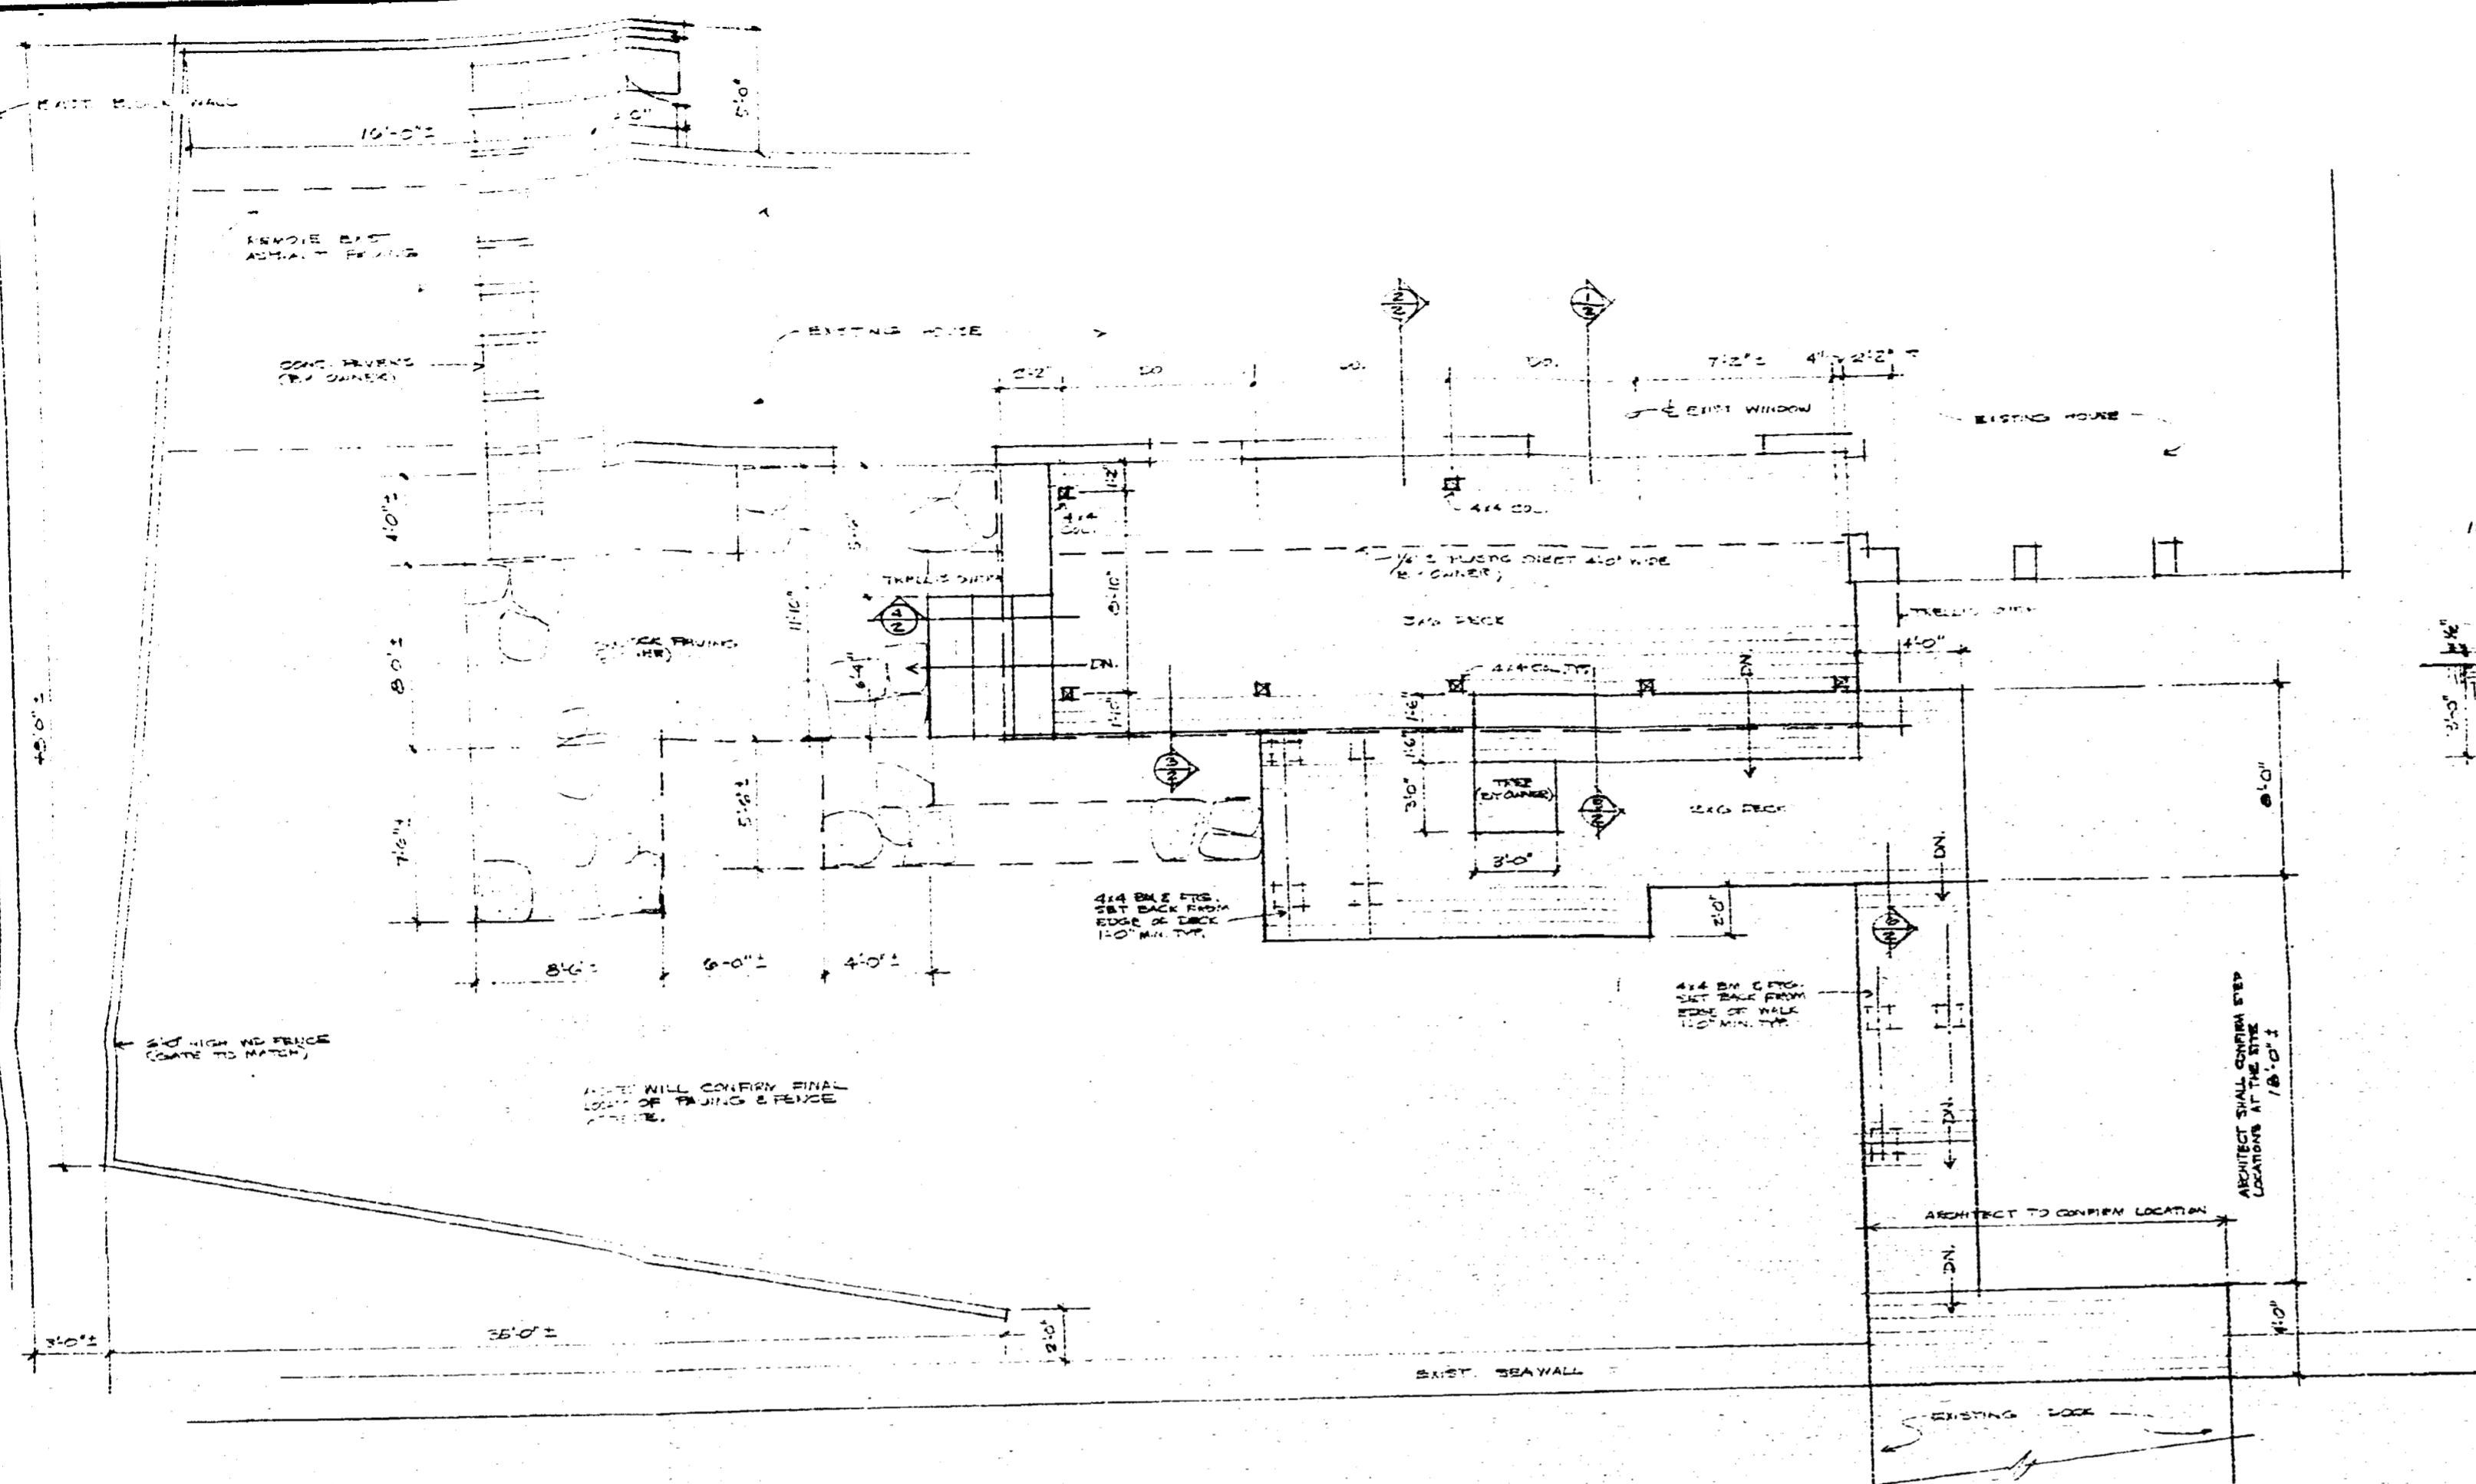

FENCE DETAIL
3/4" = 1'-0"

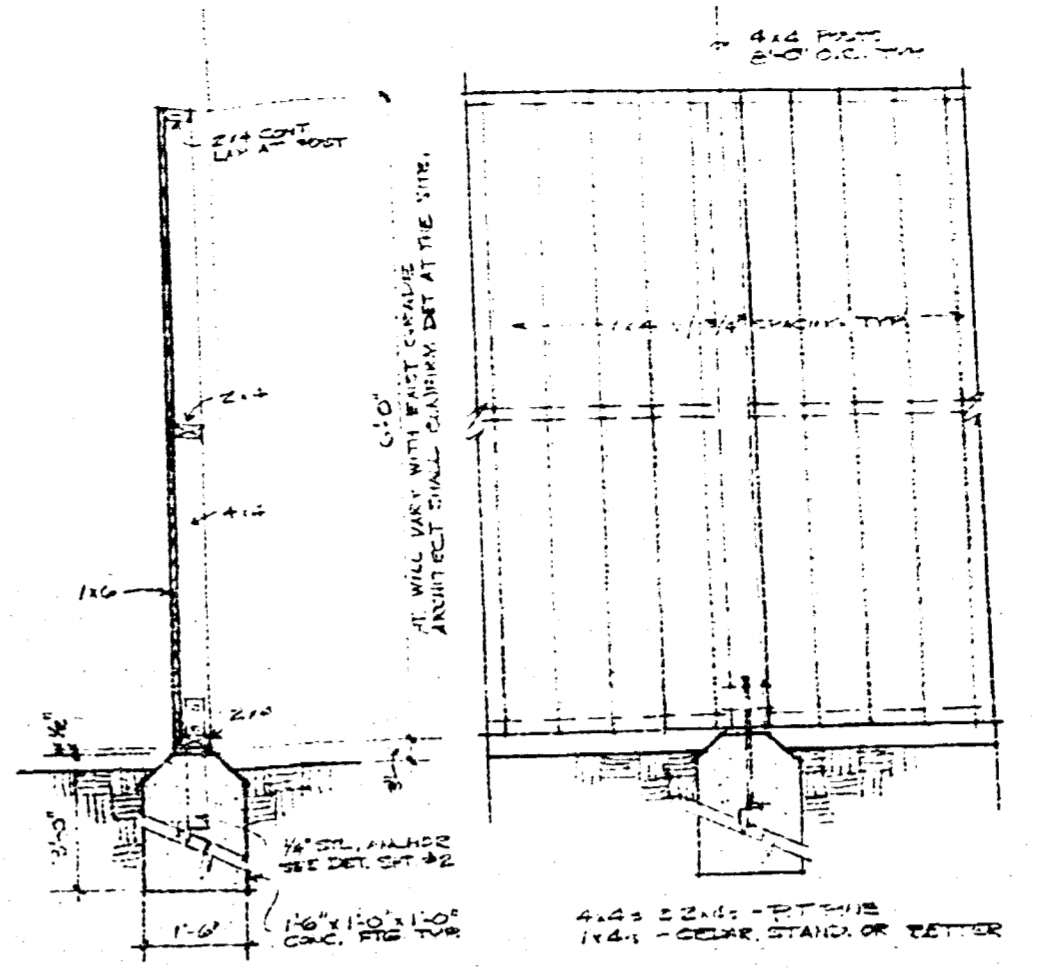

SITE PLAN
1" = 30'-0"

LEGAL DESCRIPTION
LOT 17 B 20 BLOCK 12 DILIDO AVENUE
ACCORDING TO THE PLAT THEREON AS
RECORDED IN PLAT BOOK 6 PAGE 26 OF
THE PUBLIC RECORDS OF DADE CITY, FLA.

CITY OF MIAMI BEACH
APPROVED
DATE: 2-28-76
DESIGNED BY: Stanley H. Greene
DRAWN BY: [Signature]
CHECKED BY: [Signature]
RECORDED BY: [Signature]
FIRE PREVENTION
COMMISSION

OFFICE COPY

RECEIVED

DATE _____
DRAWN BY _____
REVISIONS _____


REMODELING - TERMIN RESIDENCE
424 W. DILIDO DR. MIAMI BEACH FLA.

STANLEY H. GREENE
ARCHITECT
1400 BRICKELL AVENUE MIAMI FLORIDA 33131

Stanley H. Greene
PLANNER


1 OF 2

890111

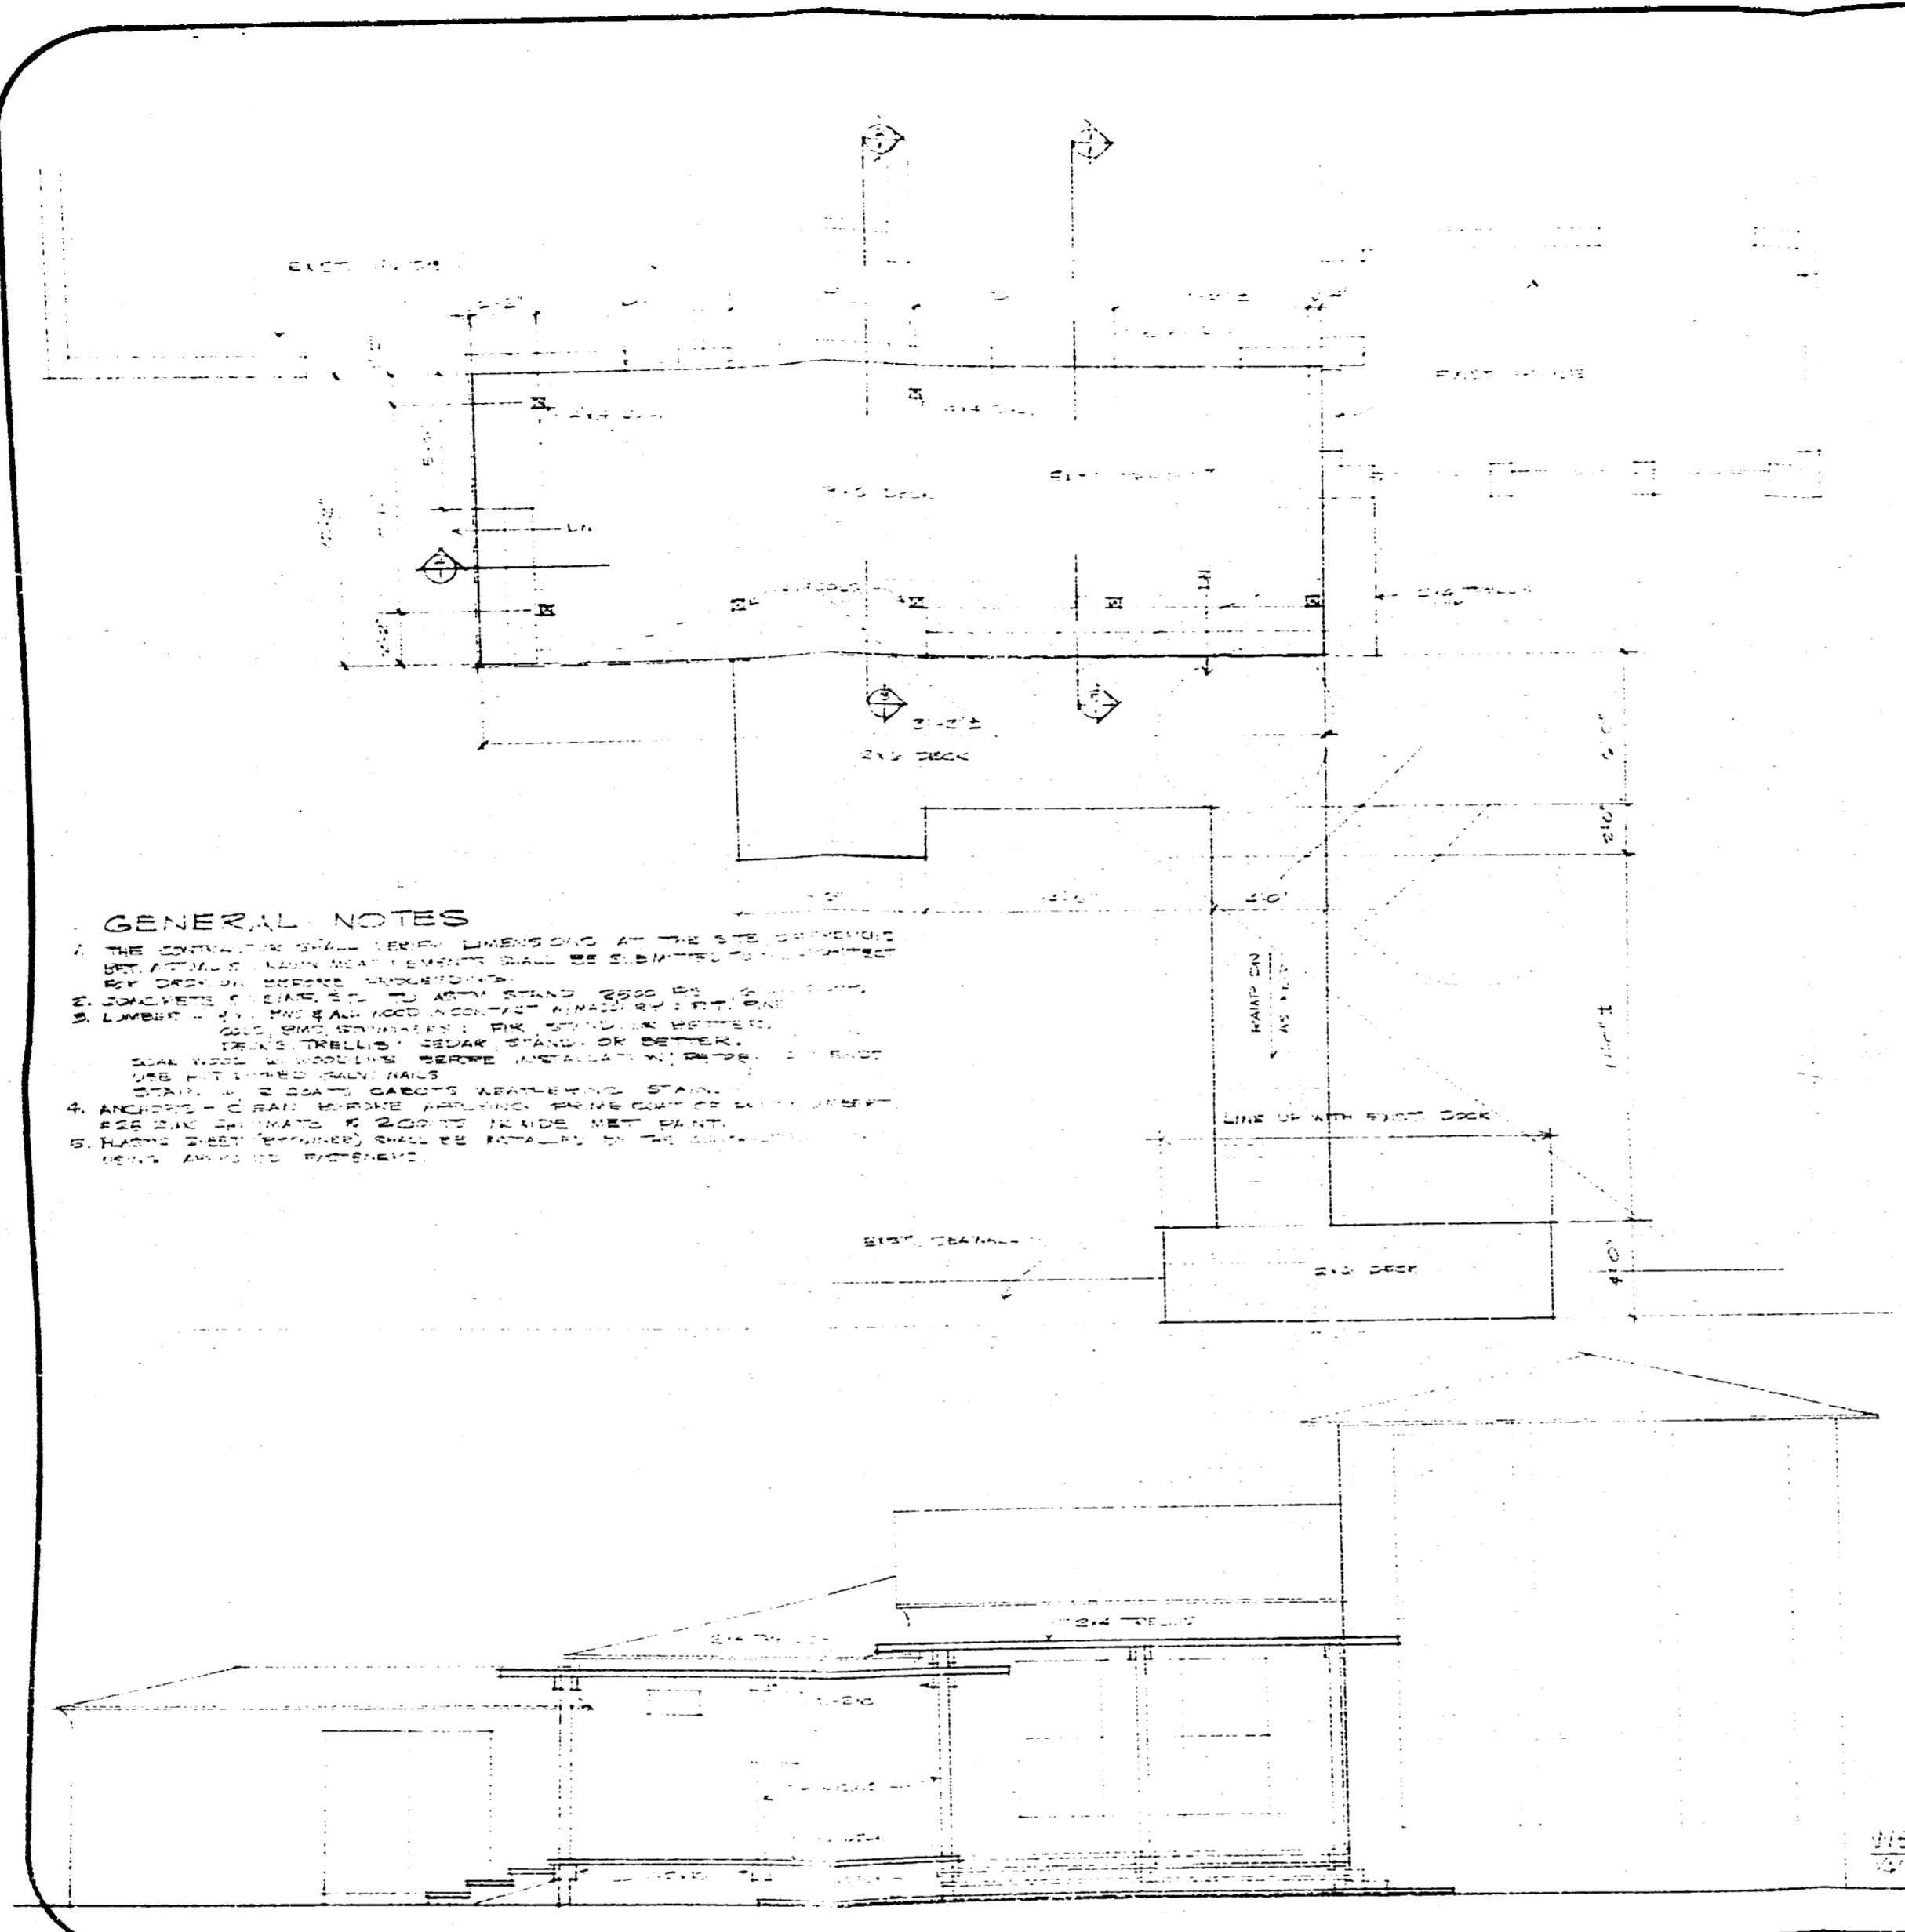

GENERAL NOTES

1. THE CONTRACTOR SHALL VERIFY DIMENSIONS AT THE SITE SURVEYORS USE APPROVED MAIN MEASUREMENT SHALL BE OBTAINED FROM CONTRACTOR BY ORDER OF ARCHITECT'S REPRESENTATIVE.
2. DIMENSIONS OF MATERIALS SHALL BE AS SHOWN UNLESS OTHERWISE NOTED.
3. LUMBER SHALL BE SIKKAH AND WOOD PRESERVATIVE SHALL BE APPLIED TO ALL EXPOSED SURFACES UNLESS OTHERWISE NOTED.
4. ANCHORS SHALL BE GALVANIZED AND SHALL BE SET IN CONCRETE.
5. FINISHES SHALL BE AS SHOWN UNLESS OTHERWISE NOTED.

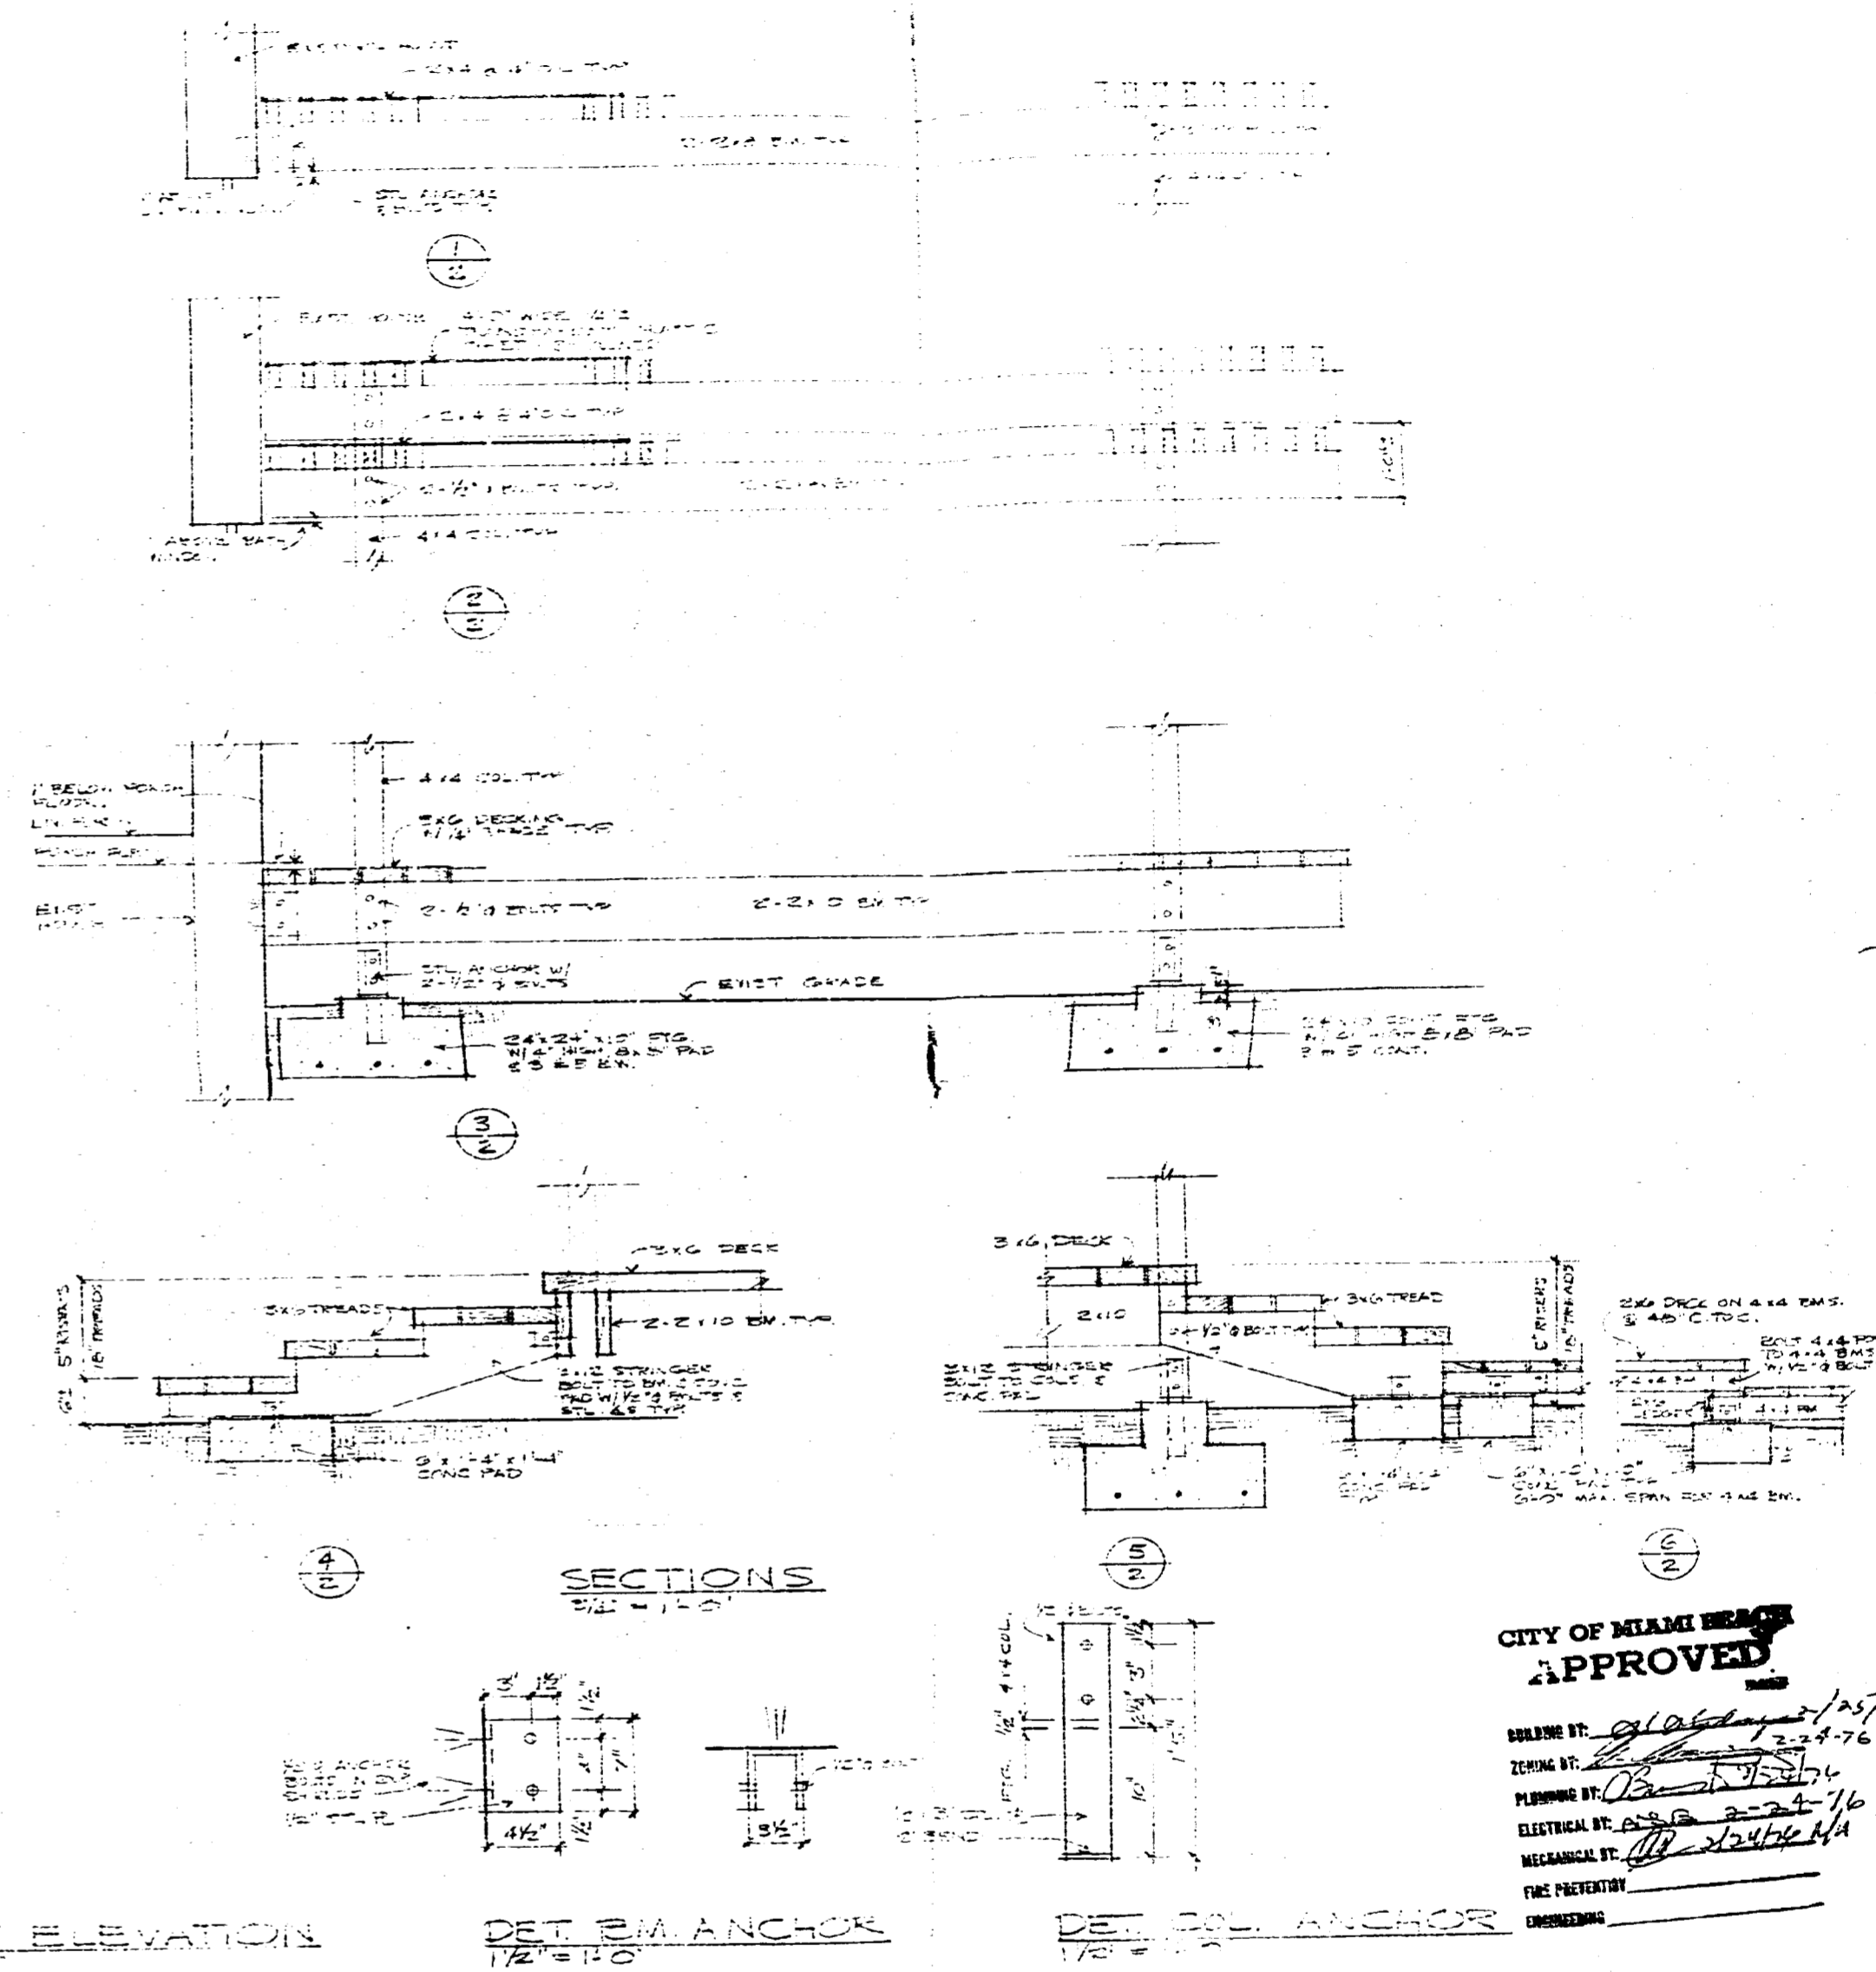

CITY OF MIAMI BEACH APPROVED

BUILDING BY: *Stanley H. Greene*
 ZONING BY: *OB*
 PLANNING BY: *OB*
 ELECTRICAL BY: *OB*
 MECHANICAL BY: *OB*
 FIRE PREVENTION: *OB*
 ENGINEERING: *OB*

DATE	1/27/76
DRAWN BY	STH
REVISIONS	

REMODELING - TERMINAL RETIREMENT
 424 N. BIRDS DR. MIAMI BEACH FLA.

STANLEY H. GREENE
ARCHITECT
 1480 BRICKELL AVENUE MIAMI FLORIDA 33121

Stanley H. Greene
PLANNER

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RECEIVED
 FEB 12 1976
 BUILDING DEPARTMENT DIVISION

890111

VENETIAN - W

LOCATION SKETCH
SCALE: 1" = 100'


LEGAL DESCRIPTION

LOT 19 & 20 Block 2 DI LIDO AMENDED ACCORDING TO THE PLAT THERE OF AS RECORDED IN PLAT BOOK 3 PAGE 34 OF THE PUBLIC RECORDS OF DADE COUNTY, FLORIDA

I HEREBY CERTIFY THAT THE ATTACHED SKETCH OF SURVEY IS TRUE AND CORRECT TO THE BEST OF KNOWLEDGE AND BELIEF AS RECENTLY SURVEYED UNDER MY DIRECTION AND THAT THERE ARE NO ENCROACHMENTS UNLESS SHOWN HEREON

RADES AND ASSOCIATES
Earle M. Rades
EARLE M. RADES
REGISTERED ENGINEER No. 117
REGISTERED LAND SURVOR
No. 106

APRIL 24, 1975. DR: BY ULM. CC: AV. FS MS10092

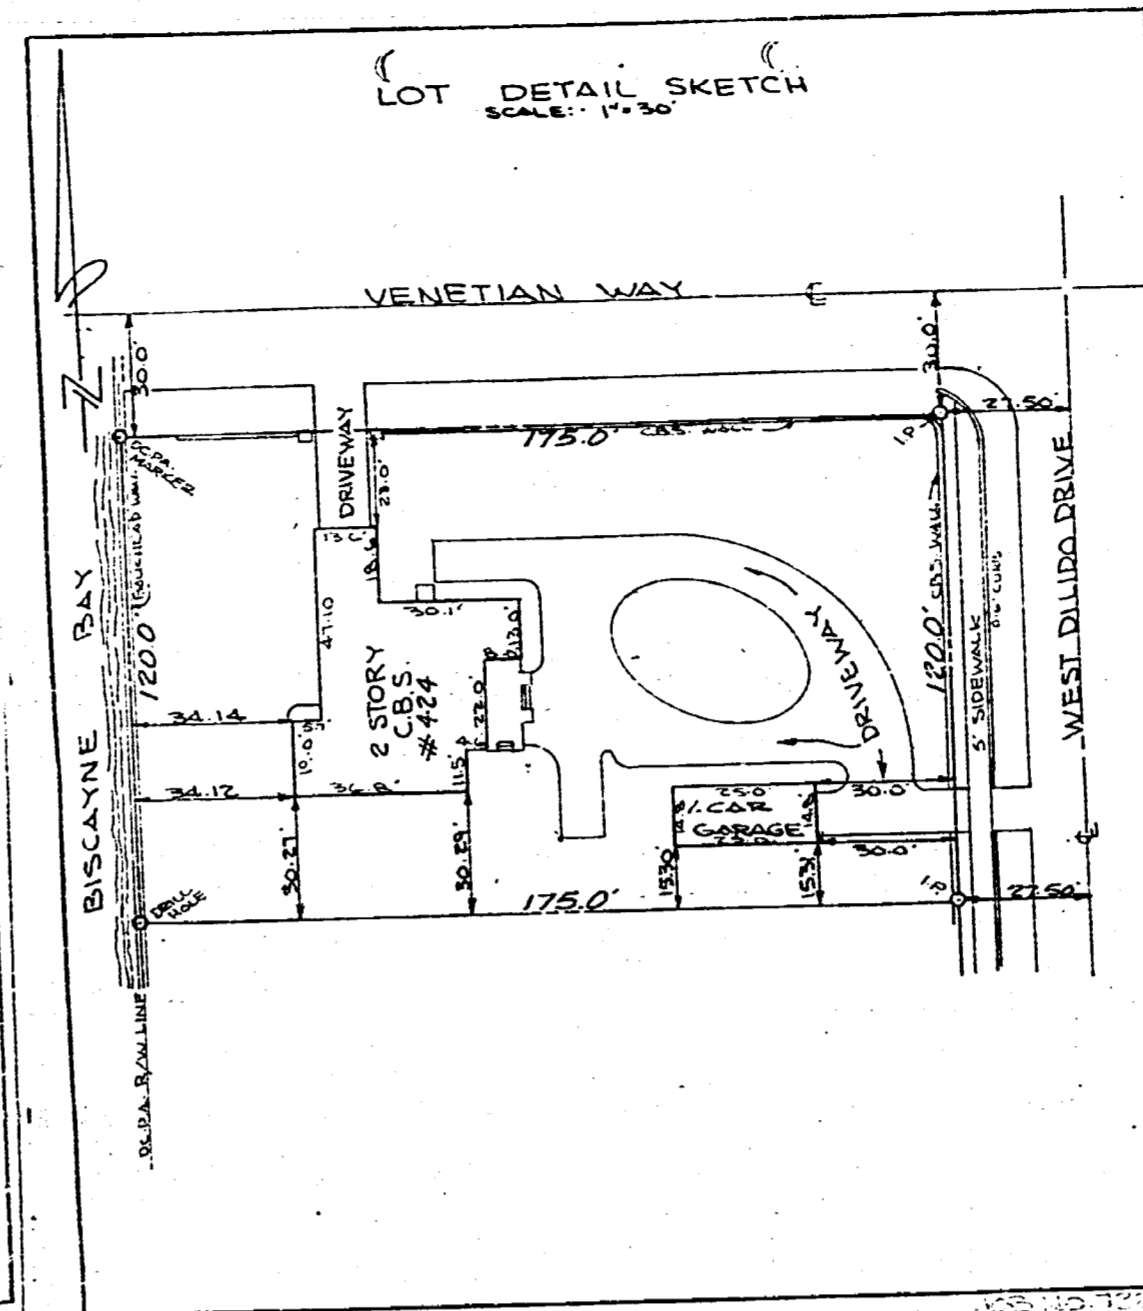

PUBLIC WORKS DEPARTMENT - BUILDING DIVISION

DATE 2/27/76

TO: PUBLIC WORKS DEPARTMENT - ENGINEERING DIVISION

LEGAL DESCRIPTION: Lots 19 and 20, Block 2, DiLido Island

LEGAL ADDRESS: 424 West Dillido Drive

TYPE OF BUILDING: Wood decking and fence, Remodeling of Residence

A plan for this building has been submitted to this Division. Please list any corrections below and return to Building Division.

GARBAGE FACILITIES: To use existing facilities

SANITARY SEWER: To use existing facilities

WATER: To use existing facilities

DRAINAGE: as shown

GRADES: as shown

ENCROACHMENTS - EASEMENTS: None

Public Works Department Permits required for work done on City Property.

COMMENTS: Complete sections of sidewalk to be removed and replaced where necessary.

Anthony Di Simone
Anthony Di Simone

OK for permit subject to above corrections.

Sent to Building Division 2/27/76 P. Avanzin 112:ar
(Date) ENGINEERING DIVISION

DATE:

CITY OF MIAMI BEACH
BUILDING INSPECTION DIVISION
ATTN: BUILDING OFFICIAL

I certify that I am the legal owner of the property described as:

424 W. Dillido Dr., Miami Beach, Fla

The applicant for the building permit is my authorized agent.

APPLICANT FOR LEGAL OWNER: Anthony Di Simone

STATE OF FLORIDA
COUNTY OF DADE

The undersigned, being first duly sworn, deposes and says that he (she) is the legal owner or authorized agent of the above property.

LEGAL OWNER: Leon Weisman M.D.





AUTHORIZED AGENT: Anthony Di Simone

Sworn to and subscribed before me this 17 day of February, 1976

Robert J. Whisman
Notary Public
State of Florida at Large
My Commission Expires June 3, 1977
Bonded by American Title & Guaranty Co.

Notary Seal

890 111

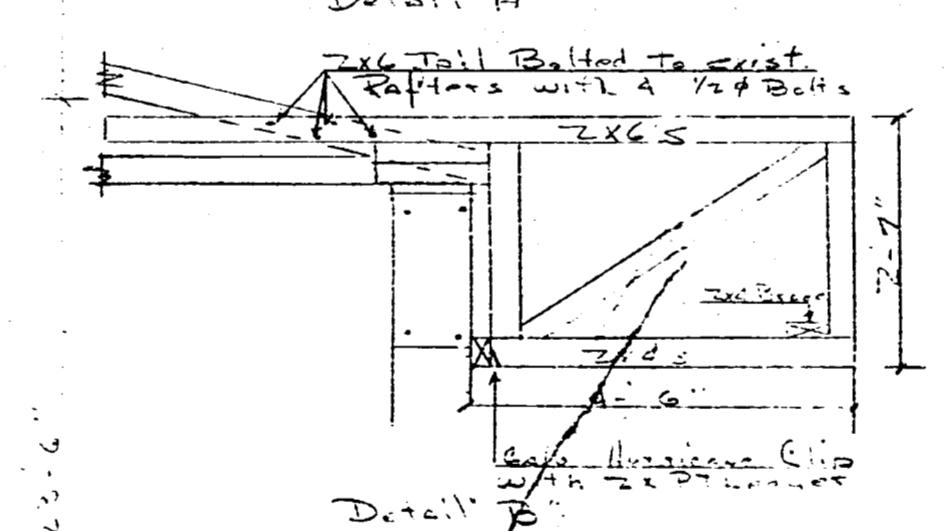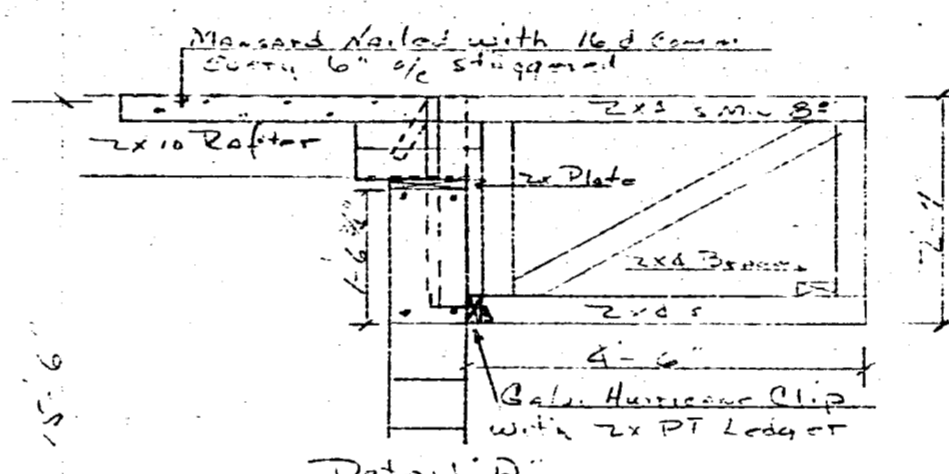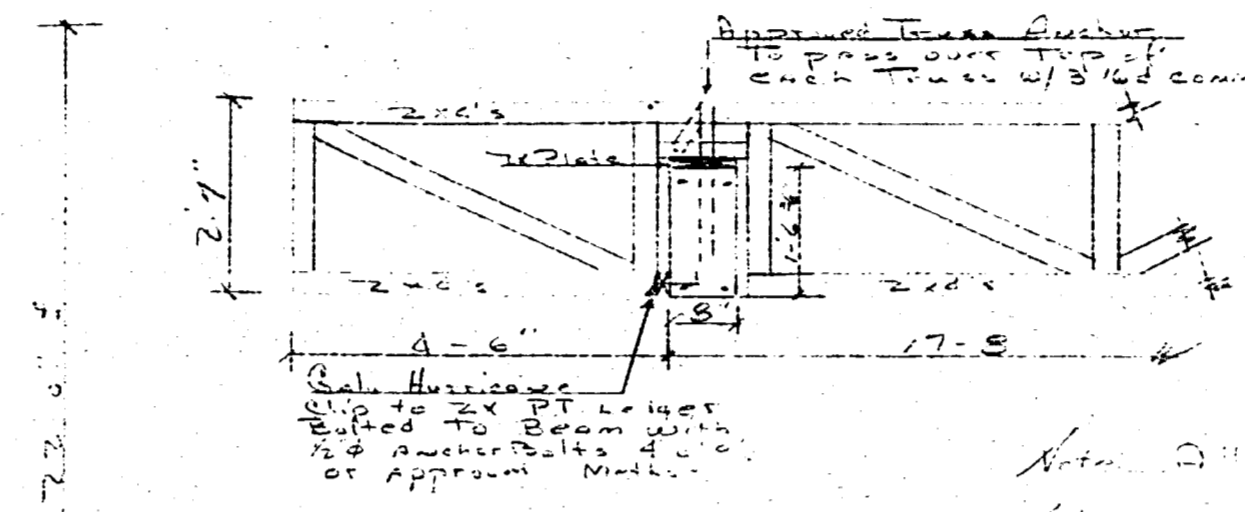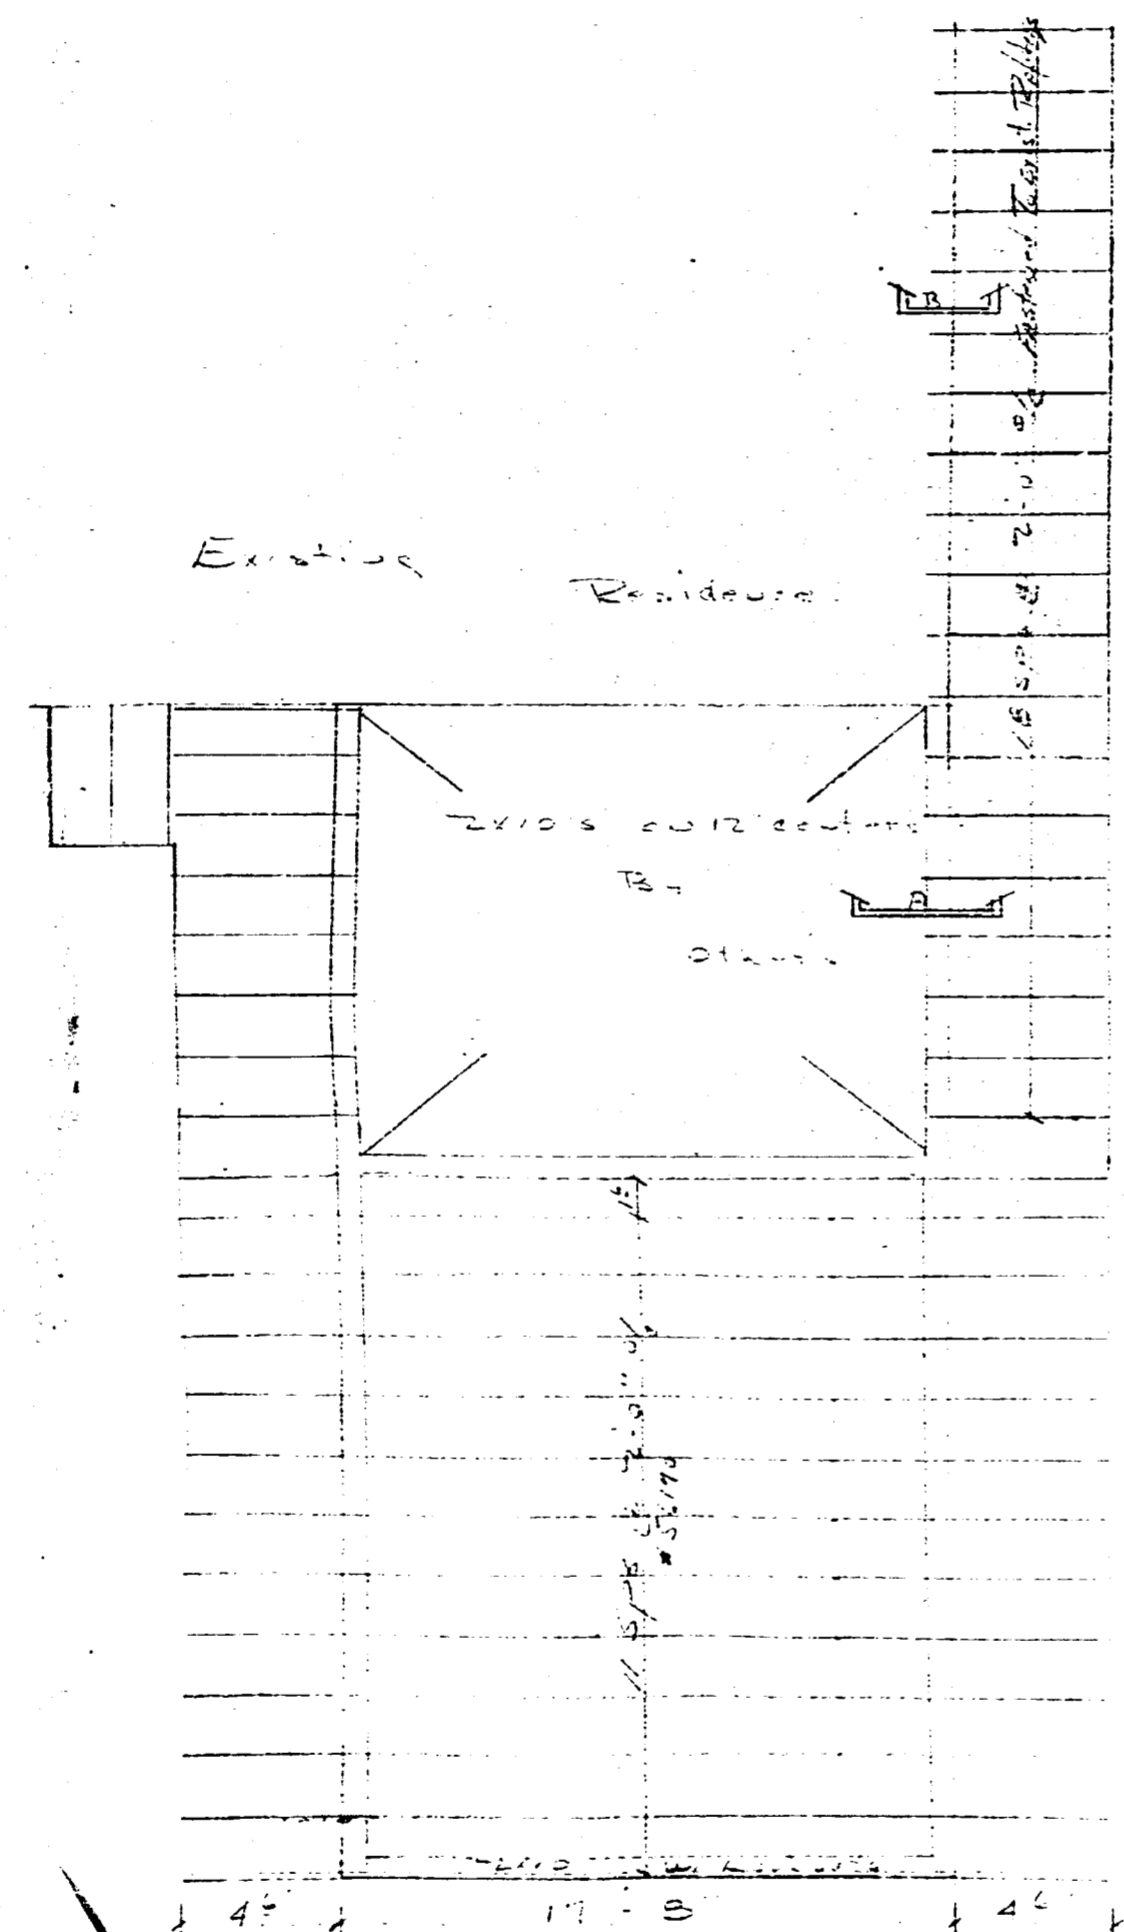

Note: All web members to be #2 S.P.
 Note: Members must be spaced as shown in drawing. Top chords to be fastened in position members to prevent outward thrust.

Note: 2x6 Continuous Lateral Braces must be placed at a connection shown on details.

Note: for Drawn Type Coast, without ceiling strapping, place 2x6 Lateral Braces along Top of Bottom Chords at each end and at mid-span. But cut to exceed 10'-0".


For dimensions only
 Alan Sheels - Architect
 OR SEAL OF
 R.S.
 CITY OF MIAMI BEACH
 APPROVED
 BUILDING BY: _____
 ZONING BY: _____
 PLUMBING BY: _____
 ELECTRICAL BY: _____
 MECHANICAL BY: _____
 FIRE PREVENTION BY: _____
 DATE: _____

Redland Roof Truss
 1730 N. Grand Ave.
 Homestead, Fla 33030
 LEDU TERMIN OWNER


595-5395
 New Enterprises
 Termin 1252
 424 W. Dilido Dr.
 Miami Beach
 Dns # 626

OFFICE COPY P.E. SEAL REQUIRED


89185

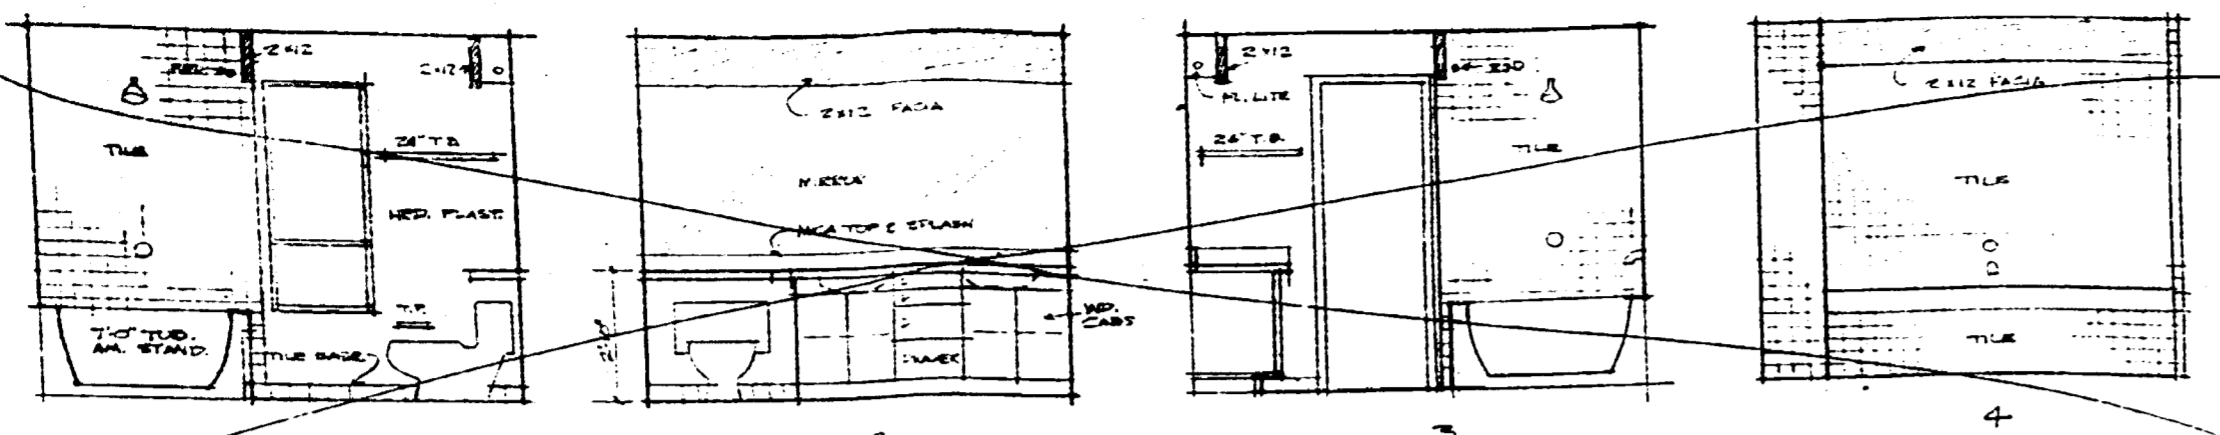


MASTER BATH 3/8" = 1'-0"

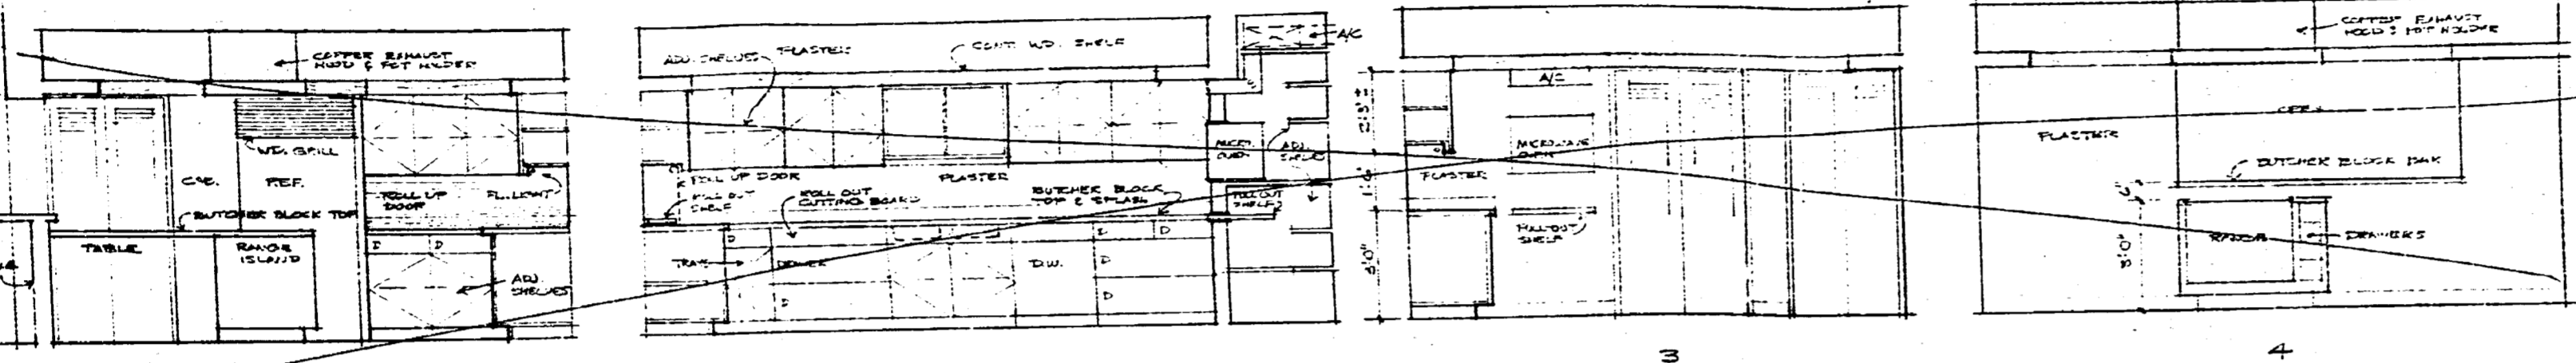

KITCHEN 3/8" = 1'-0"

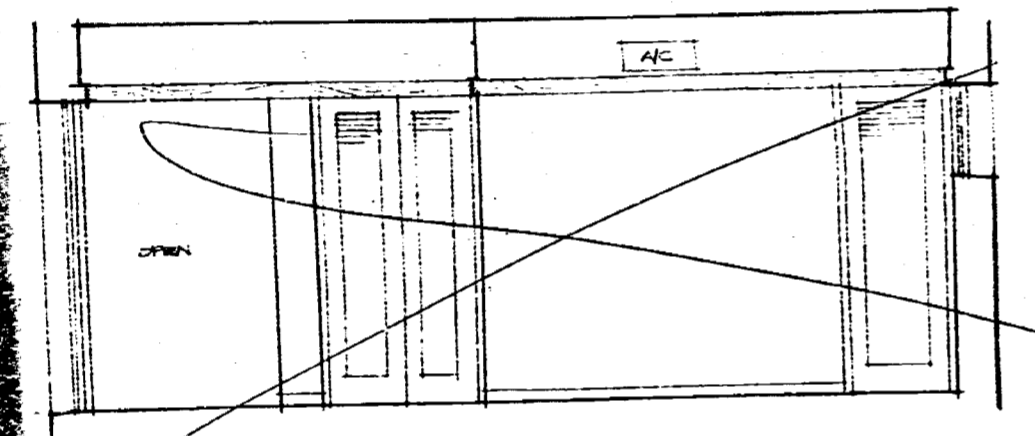


DINING ROOM 3/8" = 1'-0"

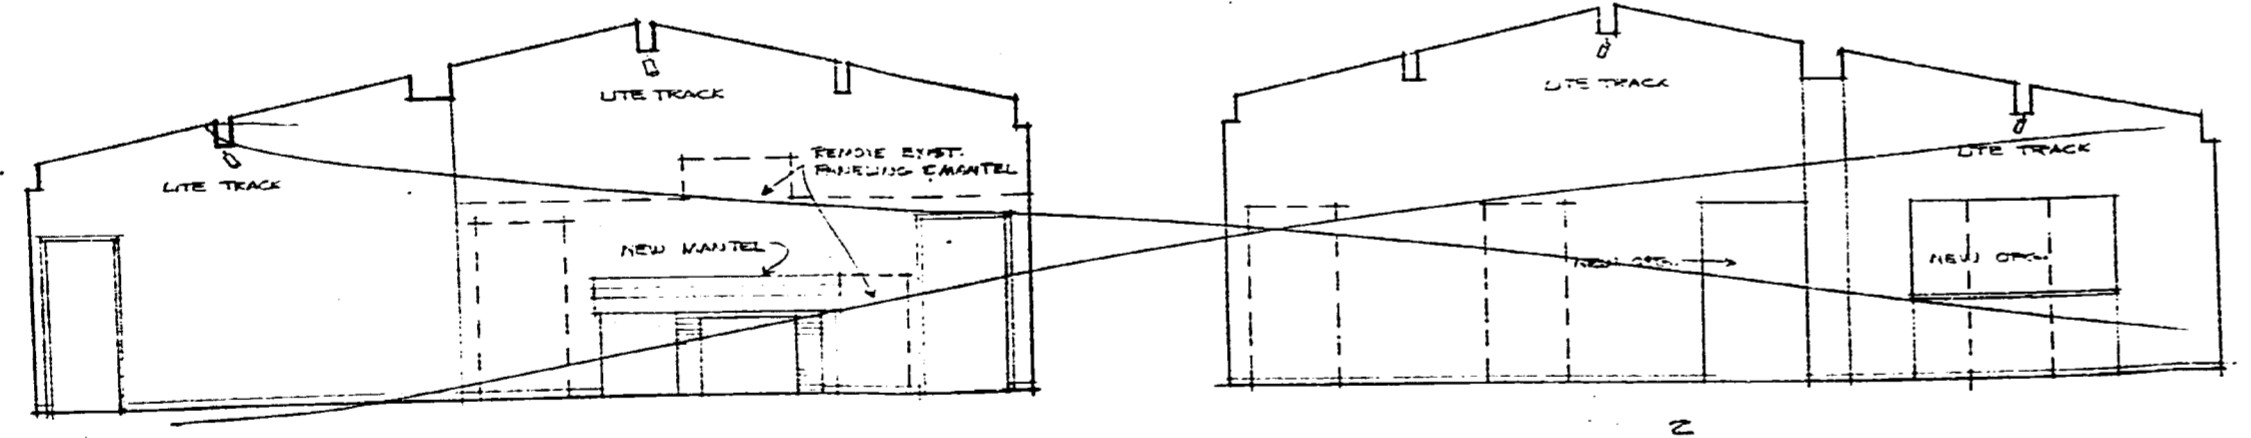

LIVING ROOM 1/2" = 1'-0"

LEGAL DESCRIPTION
 LOT 19620 BLOCK 2 DILIDO
 PLAT BOOK 8 PAGE 30 OF THE
 PUBLIC RECORDS OF DADE CITY FLA

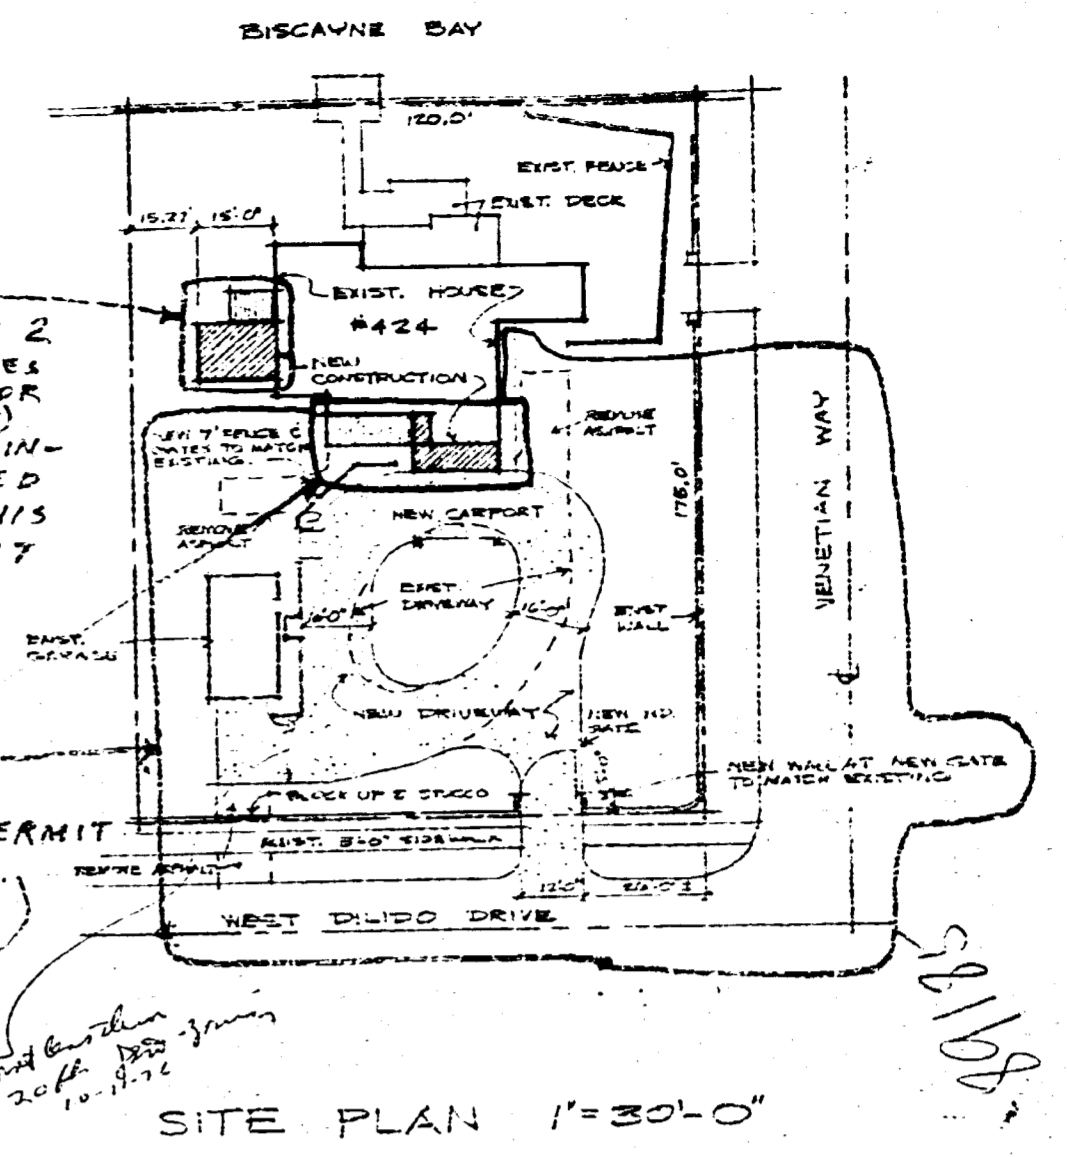

SITE PLAN 1" = 30'-0"

PHASE 2
 INCLUDES
 INTERIOR
 ALT'S
 NOT IN-
 CLUDED
 ON THIS
 PERMIT

PHASE 1
 THIS PERMIT
 (PROCESS NO.
 6599)

D.M.
 10-8-76

OFFICE COPY

RECEIVED
 OCT 8 1976
 BUILDING DEPARTMENT DIVISION

CITY OF MIAMI BEACH
 APPROVED
 DATE 10/8/76

PLANNING BY: [Signature]
 ELECTRICAL BY: [Signature]
 MECHANICAL BY: [Signature]
 FIRE PROTECTION ENGINEERING

GENERAL NOTES:
 THE CONTRACTOR SHALL VERIFY DIMENSIONS AT THE SITE, DIFFERENCES OR CONFLICTS BETWEEN ACTUAL & DRAWN MEASUREMENTS OR DETAILS SHALL BE SUBMITTED TO THE ARCHITECT FOR DECISION BEFORE PROCEEDING. NOT IN CONTRACT - LIGHT FIXTURES, FINISH FLOORS.
 JOBS TO BE LEFT CLEAN, INCLUDING GLASS, HARDWARE, ETC.
 LUMBER: FLOOR & TRUCK - CLEAR SPRUCE PINE, FRAMING - PFT TRIM - PACTA CTRIM
 WOOD TREATMENT - 2 COATS - 1/2 CLEAR 1/2 CRESTS WEATHERING STAIN
 USE GALV. NAILS
 PAINTING & COATING:
 EXT. METL. - CLEAN BEFORE APPLYING PRIMER COAT OF PRATT 2 LAMBERTS. ZINC CHROMATE & 2 COATS HOUSE MET. PRNT.
 EXT. WALLS - PRESERVE TREAT OLD WALLS. USE B. MOORE TRIPLE BODY OR APPROV. EQ. 2 COATS ON NEW WORK.
 INT. WALLS & C.S. - 2. MOORE WALL SATIN, 2 COATS ON NEW WORK.
 CAULKING - COLOR TO BE COMPATIBLE WITH ADJACENT MATERIALS.

ELECTRICAL NOTES:
 PROVIDE NEW UNDERGROUND SERVICE TO EXIST. PANEL.
 CONNECT NEW CIRCUITS TO EXIST. SPARES.

DOOR SCHEDULE					
ID.	SIZE	MATERIAL	JAMB	THRESH.	REMARKS
1	3'0" x 6'0"	1/2" BR. FRAMING	1/2"	AL.	REMOVE FLOOR, REPAIR & REFINISH
2	3'0" x 6'0"	"	"	"	"
3	3'0" x 6'0"	"	"	"	"

WINDOW SCHEDULE					
NO.	SIZE	TYPE	MATERIAL	REMARKS	
A	3'0" x 6'0"	AL. VENT.	REMOVE EXIST. WINDOW	REMOVE EXIST. WINDOW	
B	"	AL. SLP.	"	"	
C	3'0" x 6'0"	AL. SLP.	"	"	


DATE 10-2-76
 DRAWN BY _____
 REVISIONS _____

TERMIN RESIDENCE REMODELING
 424 W. DILIDO DR. MIAMI BEACH FLA.

STANLEY H. GREENE
 ARCHITECT PLANNER
 1480 BRICKELL AVENUE MIAMI FLORIDA 33131
 371-0272

MASTER PLAN
 PHASE ONE
 1 OF 7

89185

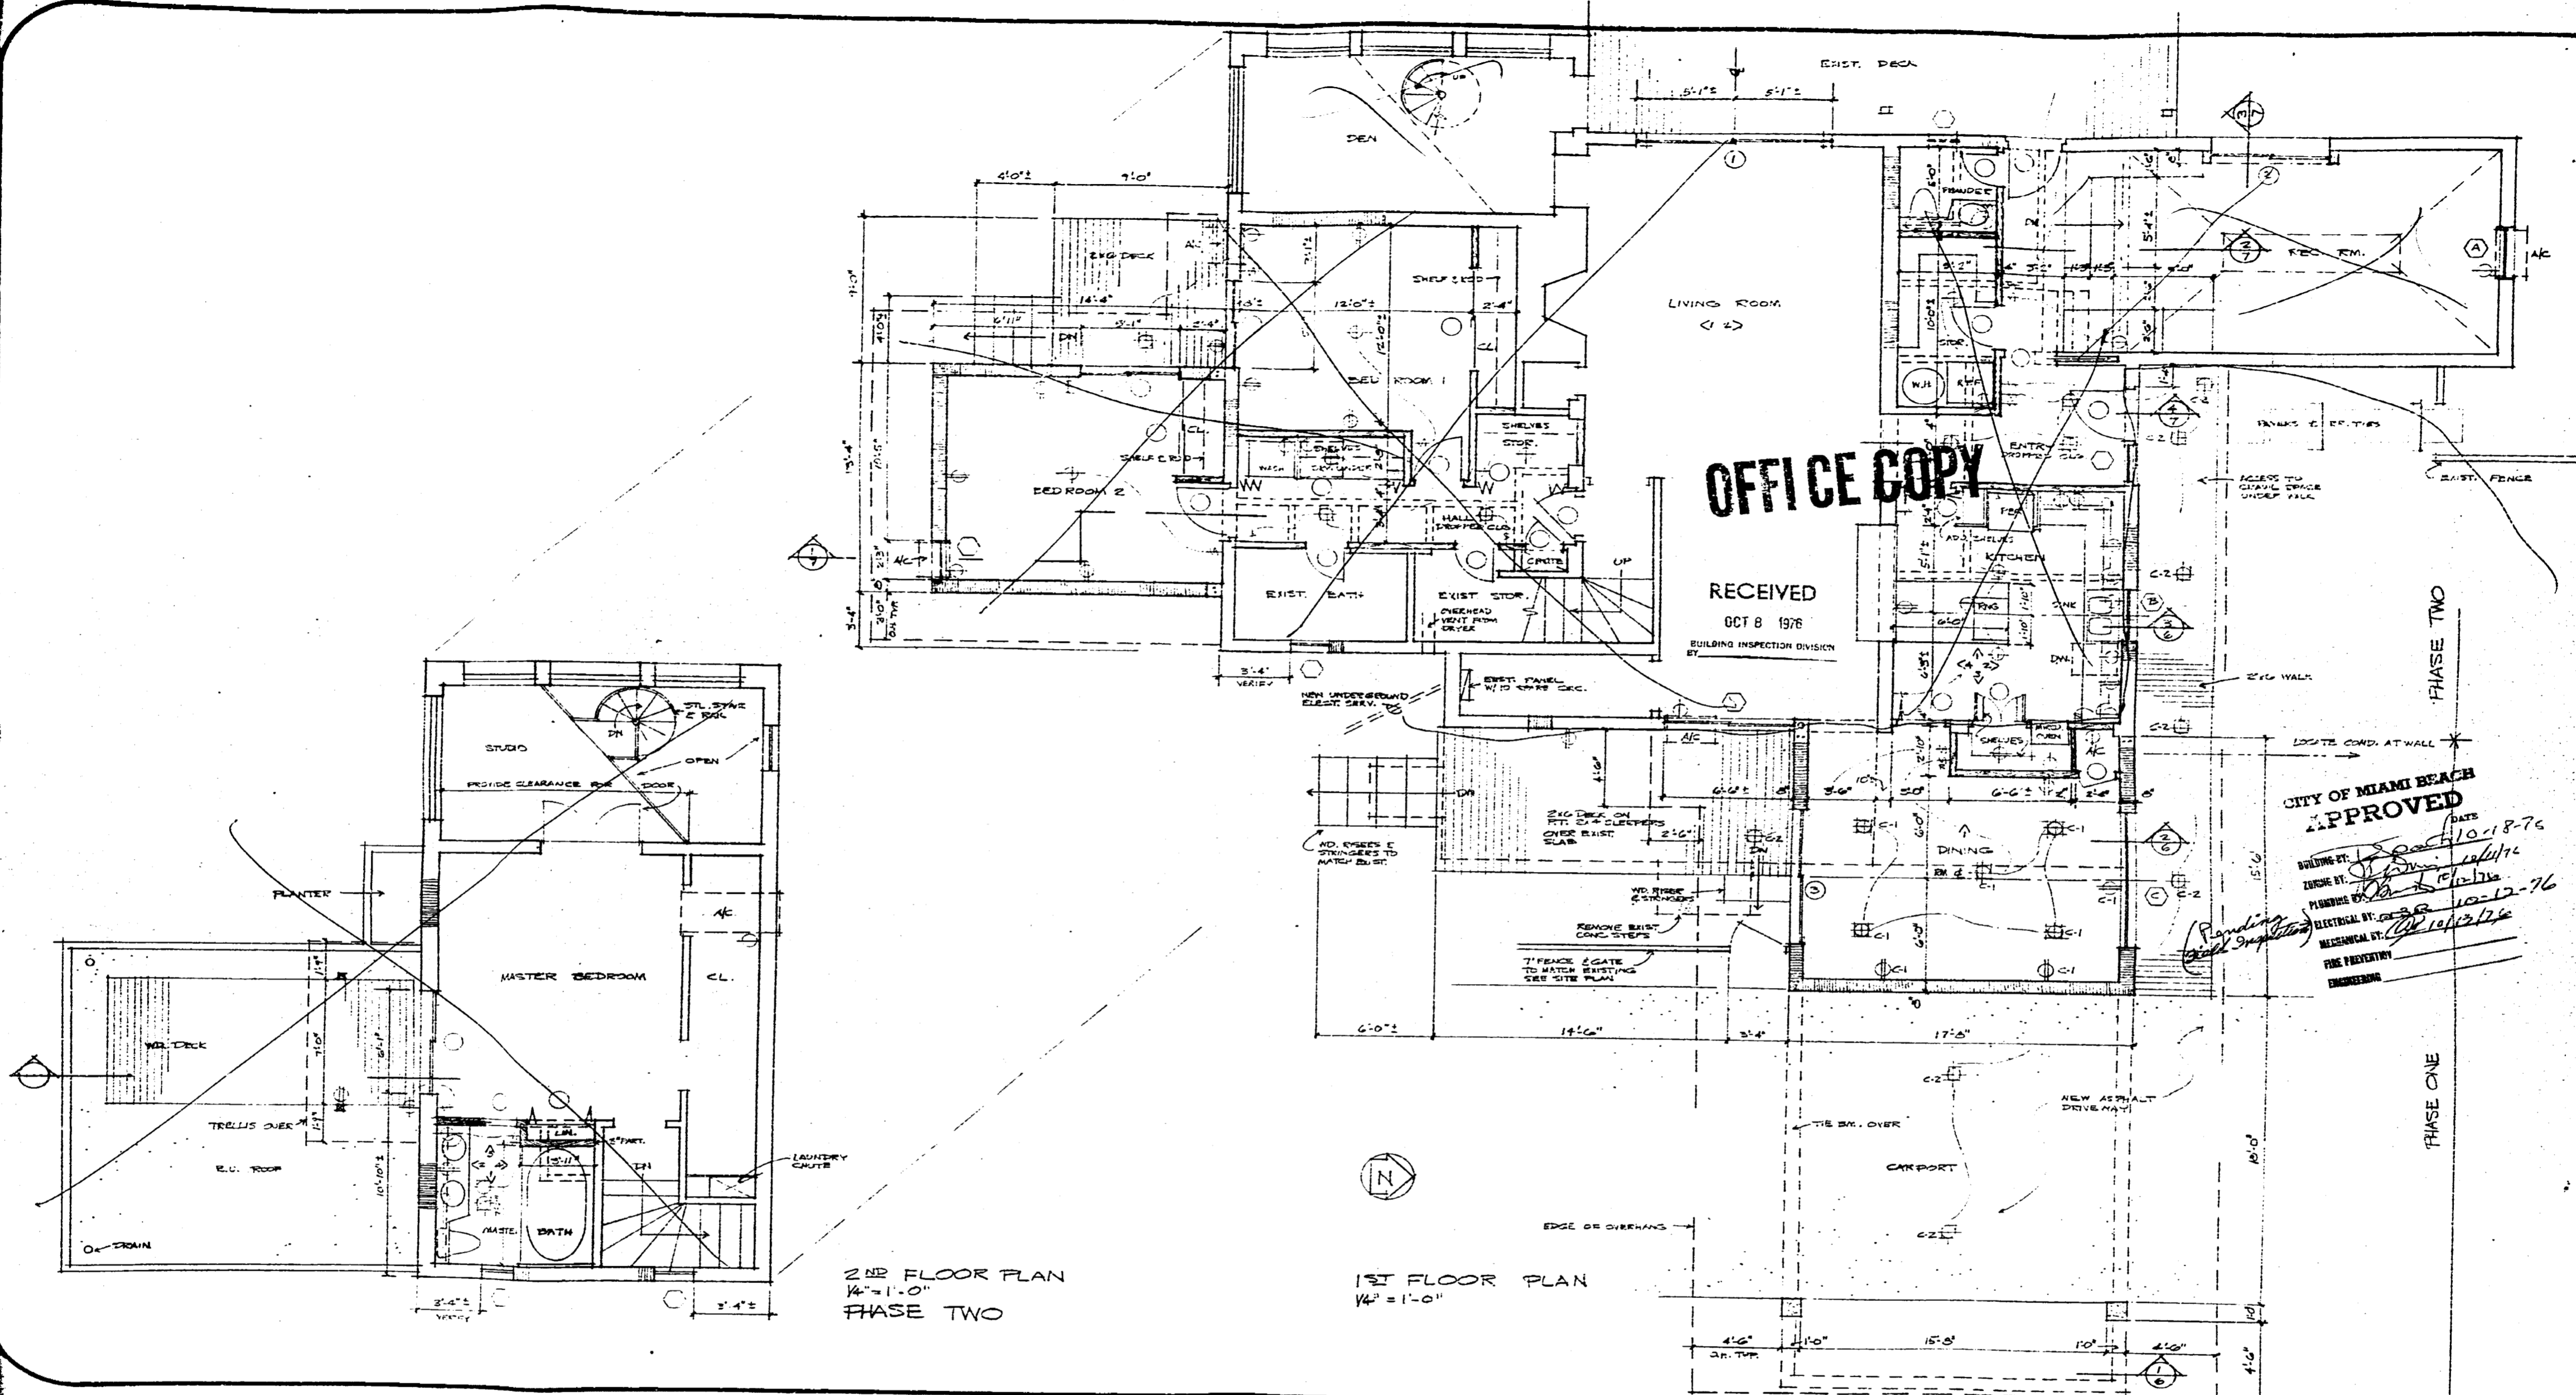

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OCT 8 1976
BUILDING INSPECTION DIVISION

CITY OF MIAMI BEACH
APPROVED
DATE 10-18-76
BUILDING BY: [Signature]
ENGINEER BY: [Signature]
ELECTRICAL BY: [Signature]
MECHANICAL BY: [Signature]
FIRE PROTECTION ENGINEER

2ND FLOOR PLAN
1/4" = 1'-0"
PHASE TWO

1ST FLOOR PLAN
1/4" = 1'-0"

DATE	6-2-76
DRAWN BY	
REVISIONS	


TERMIN RESIDENCE REMODELING
424 W. DILIDO DR. MIAMI BEACH FLA.

STANLEY H. GREENE
ARCHITECT PLANNER
1480 BRICKELL AVENUE MIAMI FLORIDA 33131

[Signature]


MASTER PLAN
PHASE ONE
2 OF 7

89185

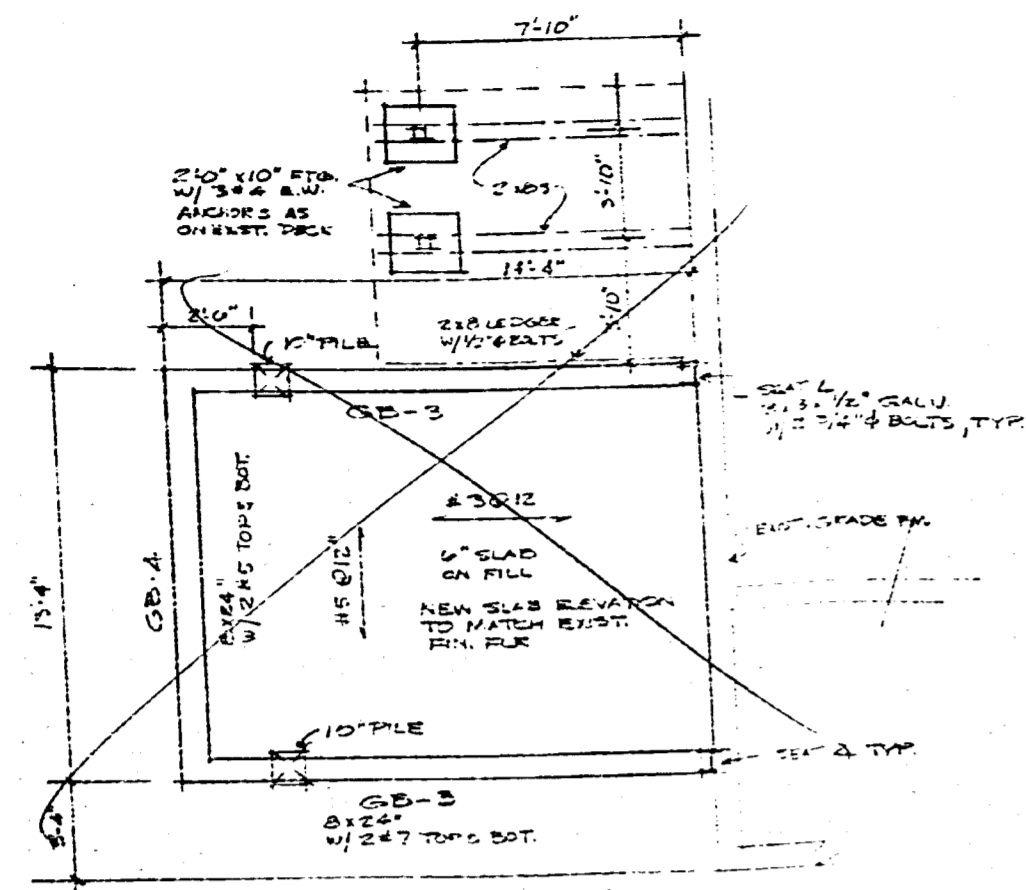


- NOTES**
1. NEW PILING TO BE PRECAST 10"x10" DRIVEN TO A MIN. BEARING CAPACITY OF 17 TONS.
 2. CONCRETE - C-1 = 3,000 P.S.I.
 3. REINFORCING - ASTM A615 GRADE 60
 4. MIN. 2" CLEARANCE BETWEEN GRADE BM. REIN. & BOTTOM

BED ROOM PHASE TWO

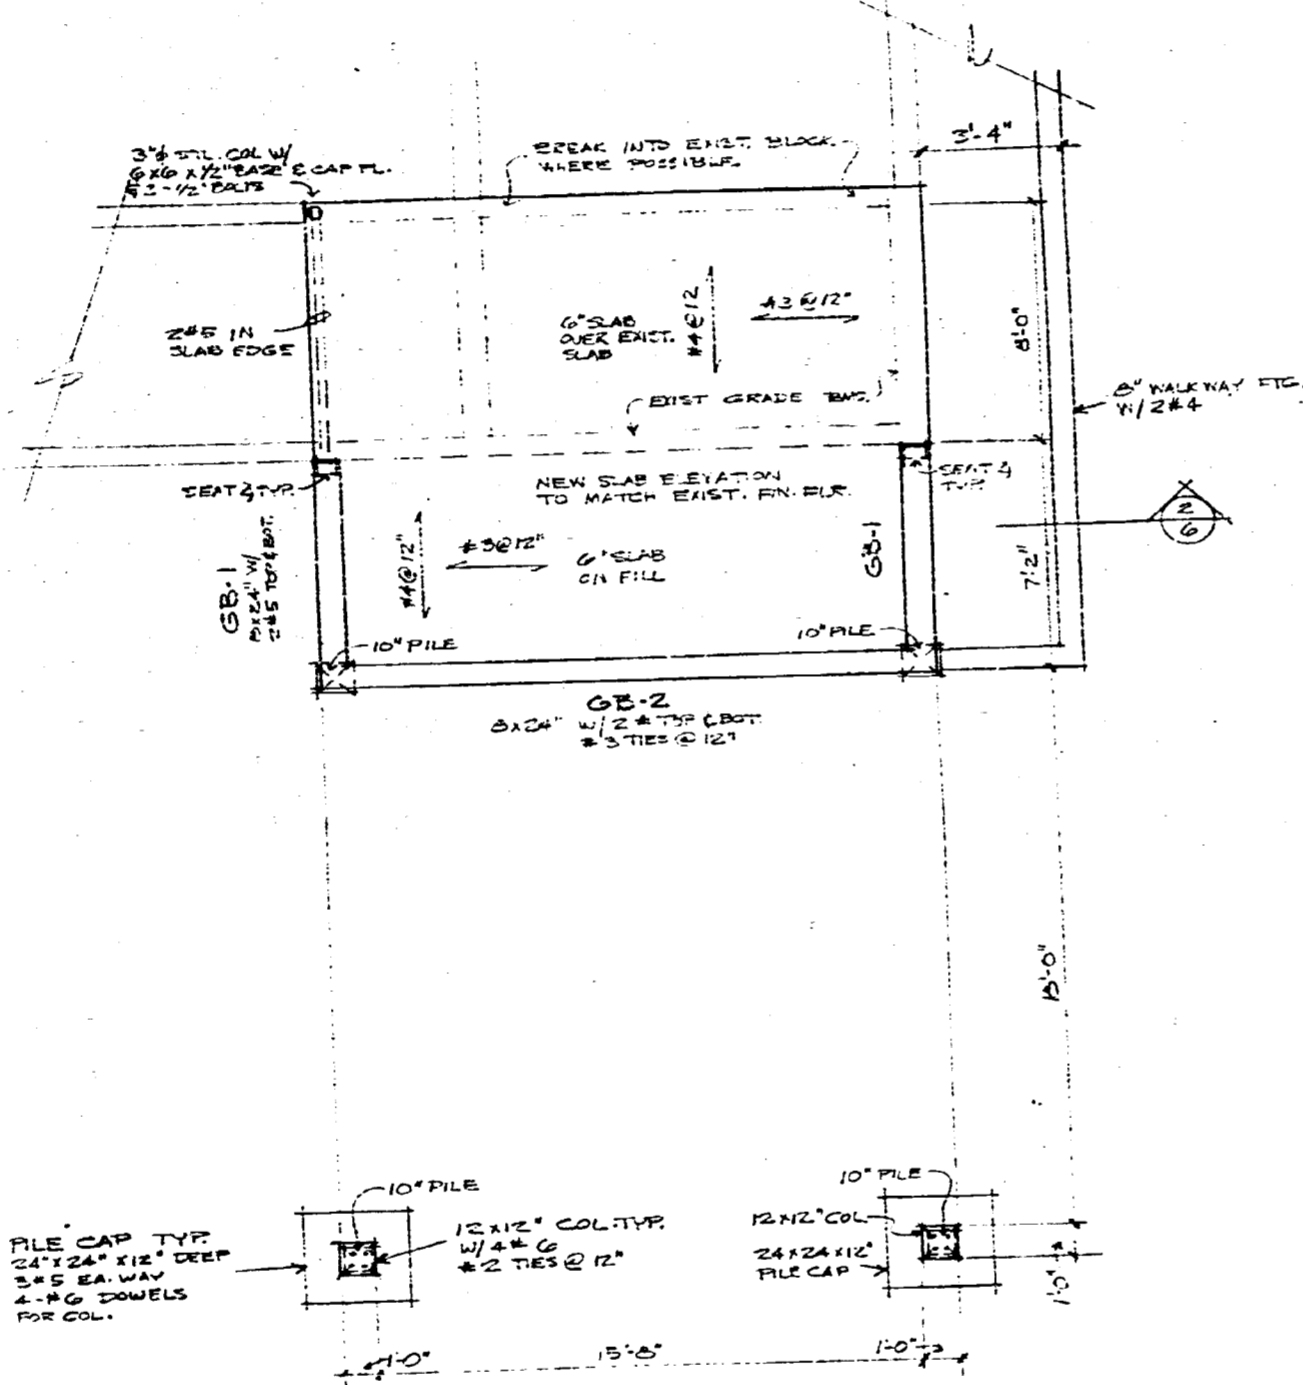

FOUNDATION PLAN 1/4"=1'-0"

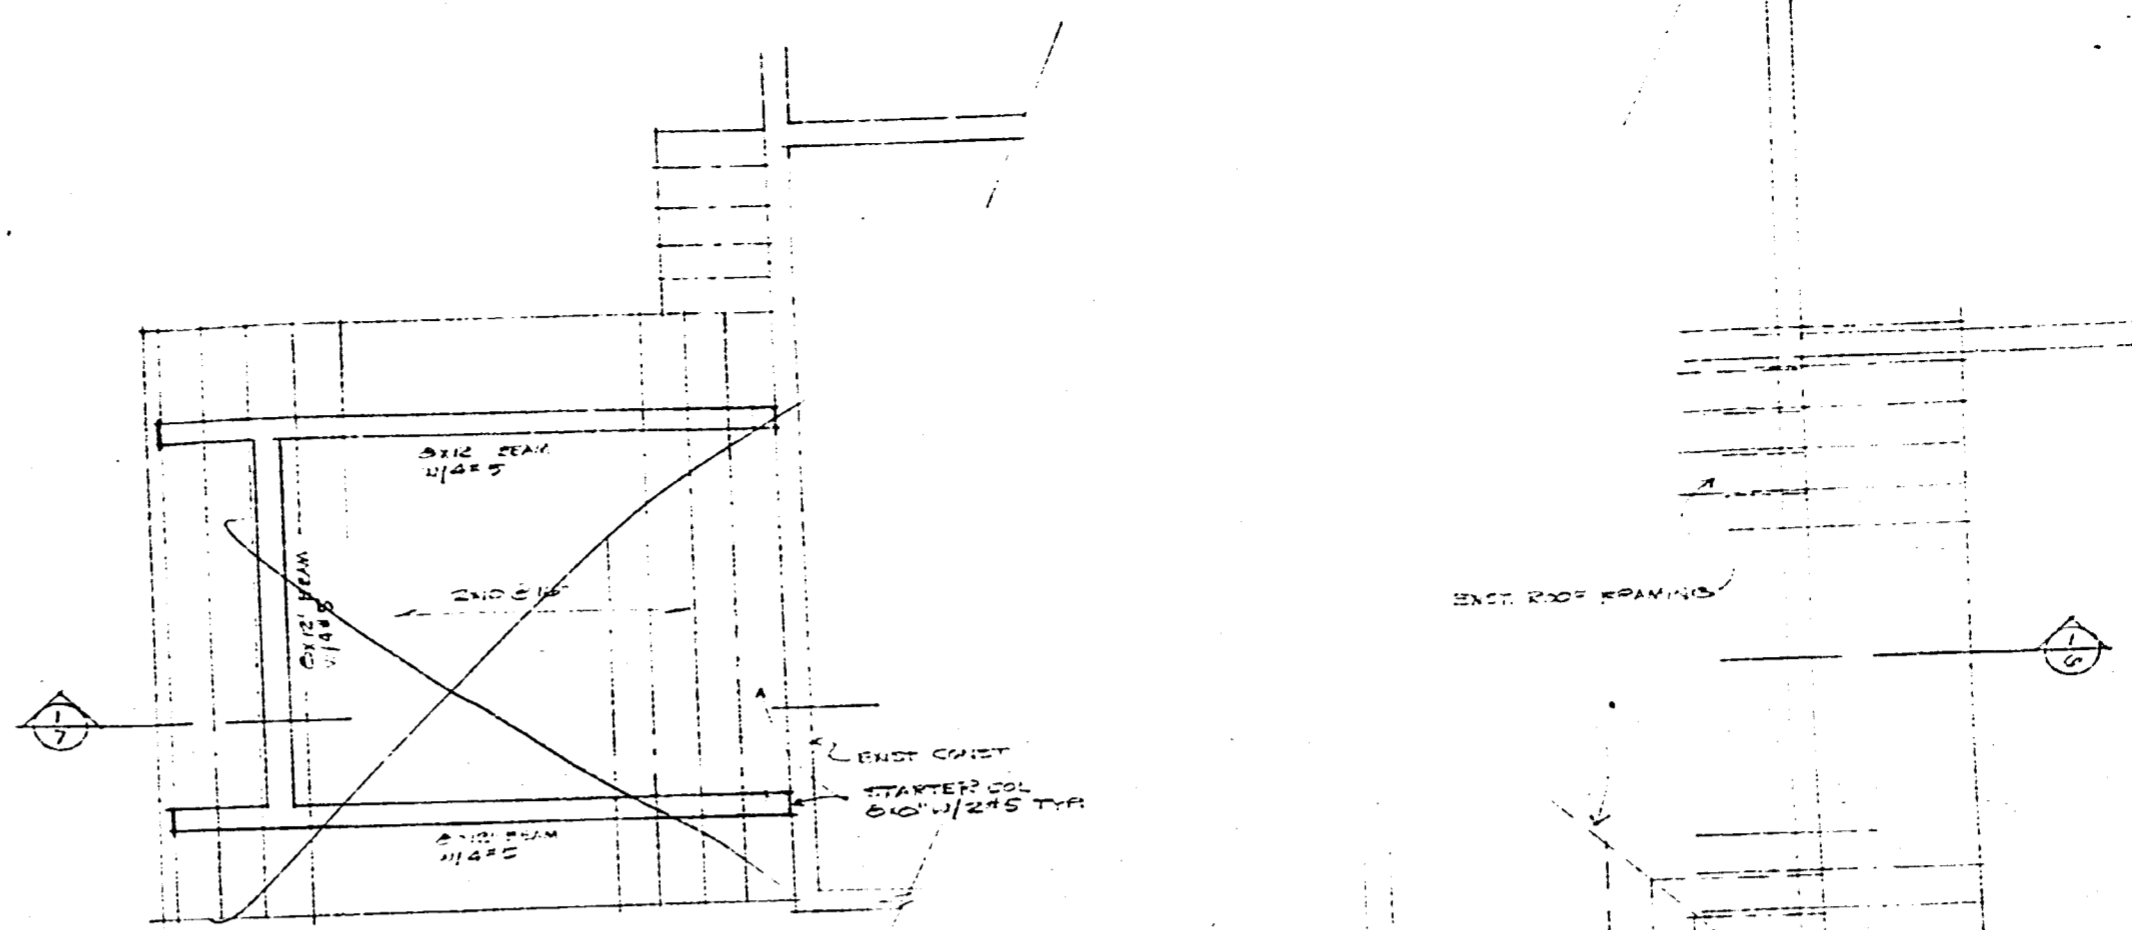

BED ROOM PHASE TWO


DINING-CARPORT PHASE ONE

ROOF FRAMING PLAN 1/8"=1'-0"

RECEIVED
OCT 8 1976
BUILDING INSPECTION DIVISION

CITY OF MIAMI BEACH APPROVED
DATE 10-18-76
DESIGNED BY [Signature] 10-11-76
DRAWING BY [Signature] 10-12-76
ELECTRICAL BY [Signature] 10-12-76
MECHANICAL BY [Signature] 10-12-76
FIRE PREVENTION [Signature]
ENGINEERING

OFFICE COPY

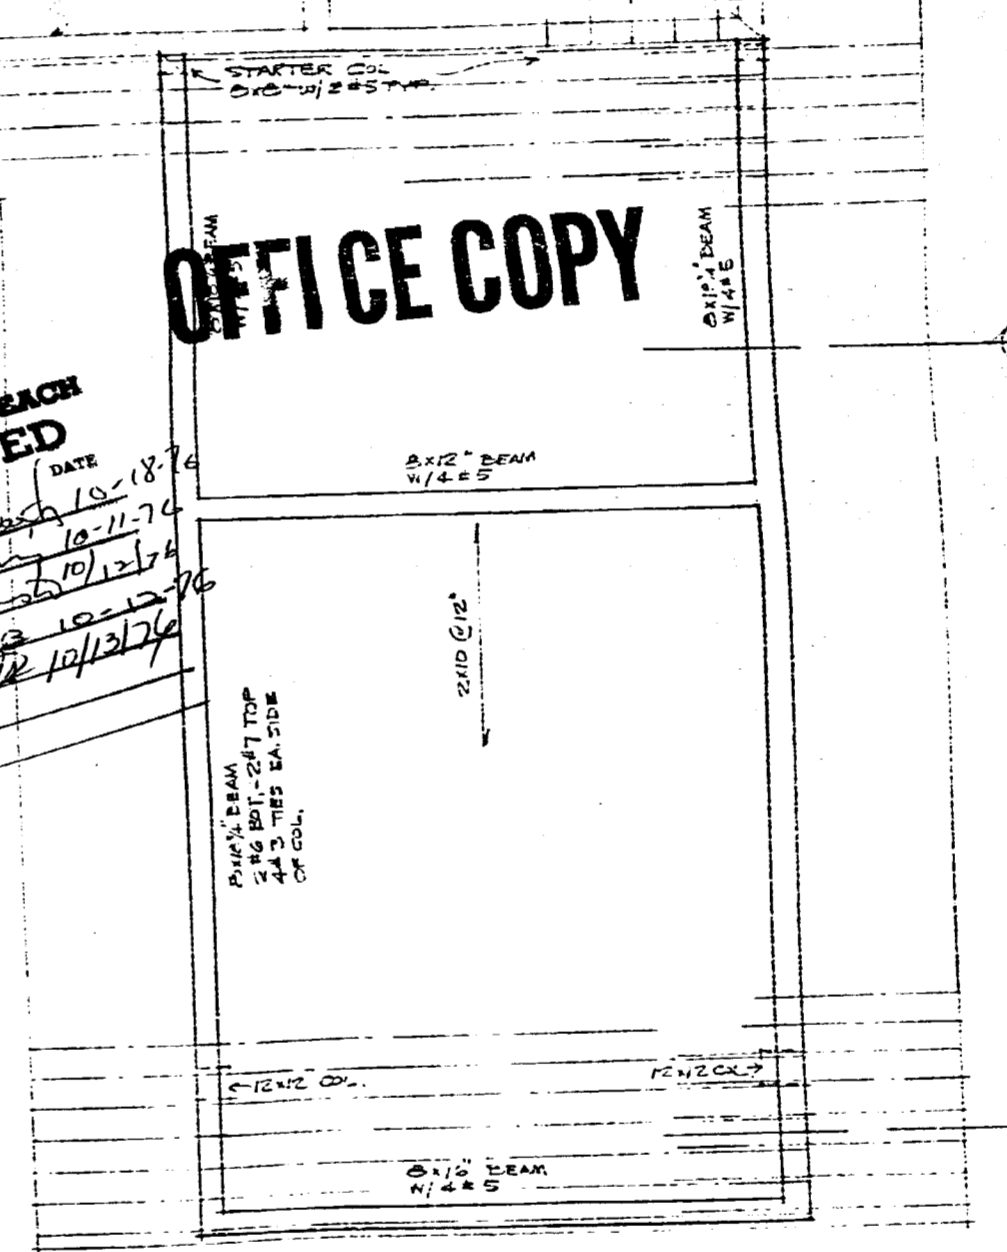

See attached letter from P.E.

DATE 3-2-76
DRAWN BY _____
REVISIONS _____


TERMIN RESIDENCE REMODELING
424 W. DILIDO DR. MIAMI BEACH FLA.

STANLEY H. GREENE
ARCHITECT PLANNER
1480 BRICKELL AVENUE MIAMI FLORIDA 33131

[Signature]

MASTER PLAN PHASE ONE
3 OF 7

89185

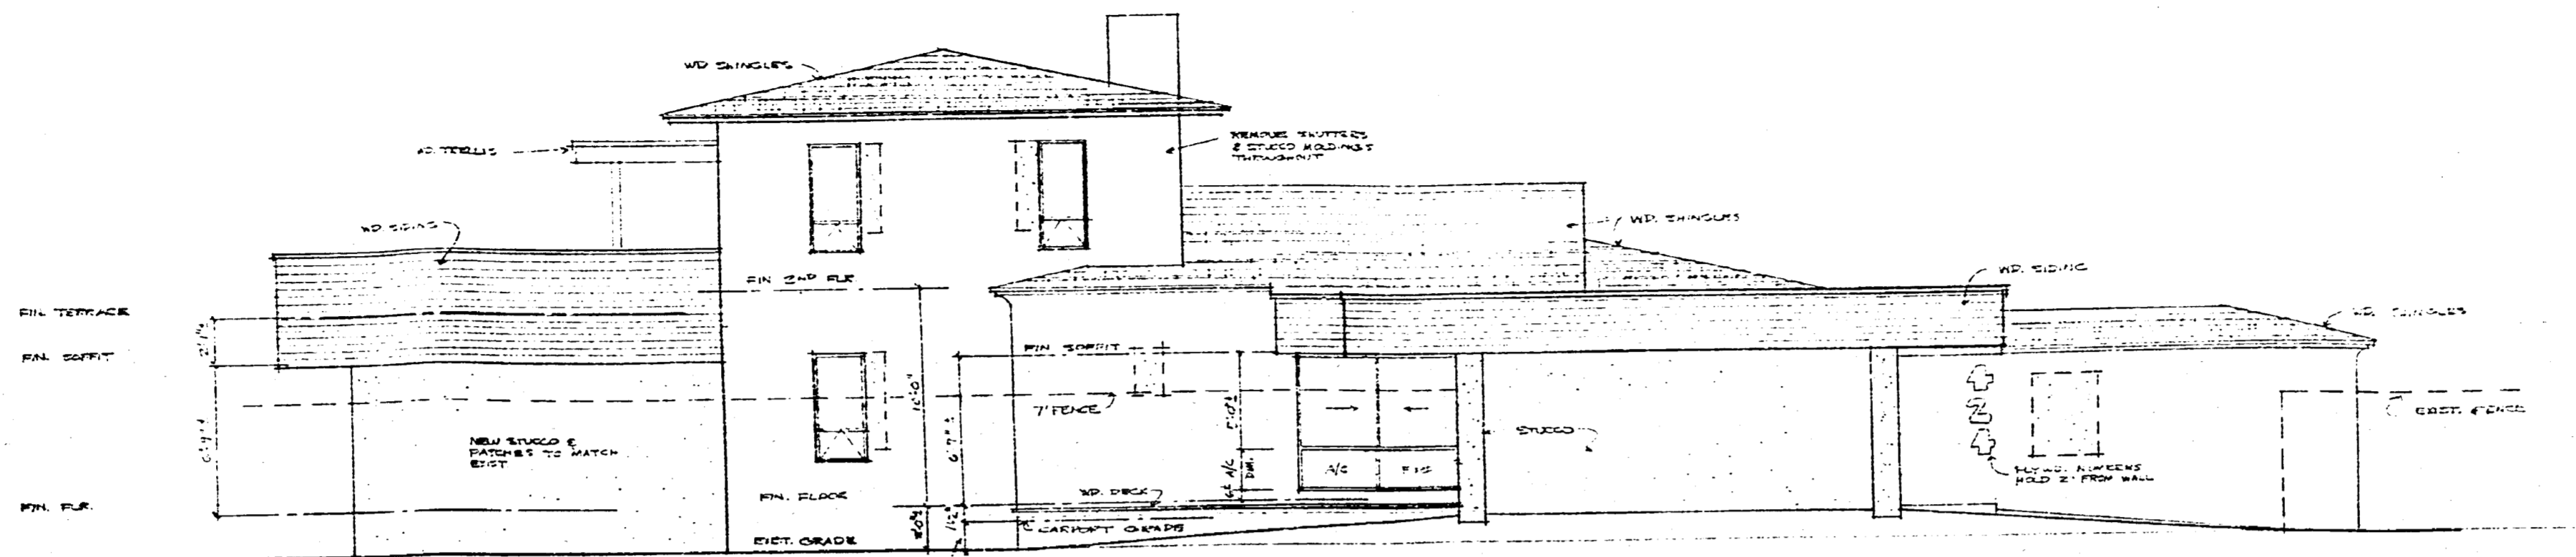


EAST (FRONT) ELEVATION 1/4" = 1'-0"

OFFICE COPY

RECEIVED
OCT 8 1976
BUILDING INSPECTION DIVISION

CITY OF MIAMI BEACH
APPROVED
DATE: 10-18-76
BUILDING BY: Stanley H. Greene
PLUMBING BY: [Signature]
ELECTRICAL BY: [Signature]
MECHANICAL BY: [Signature]
FIRE PREVENTION
ENGINEERING

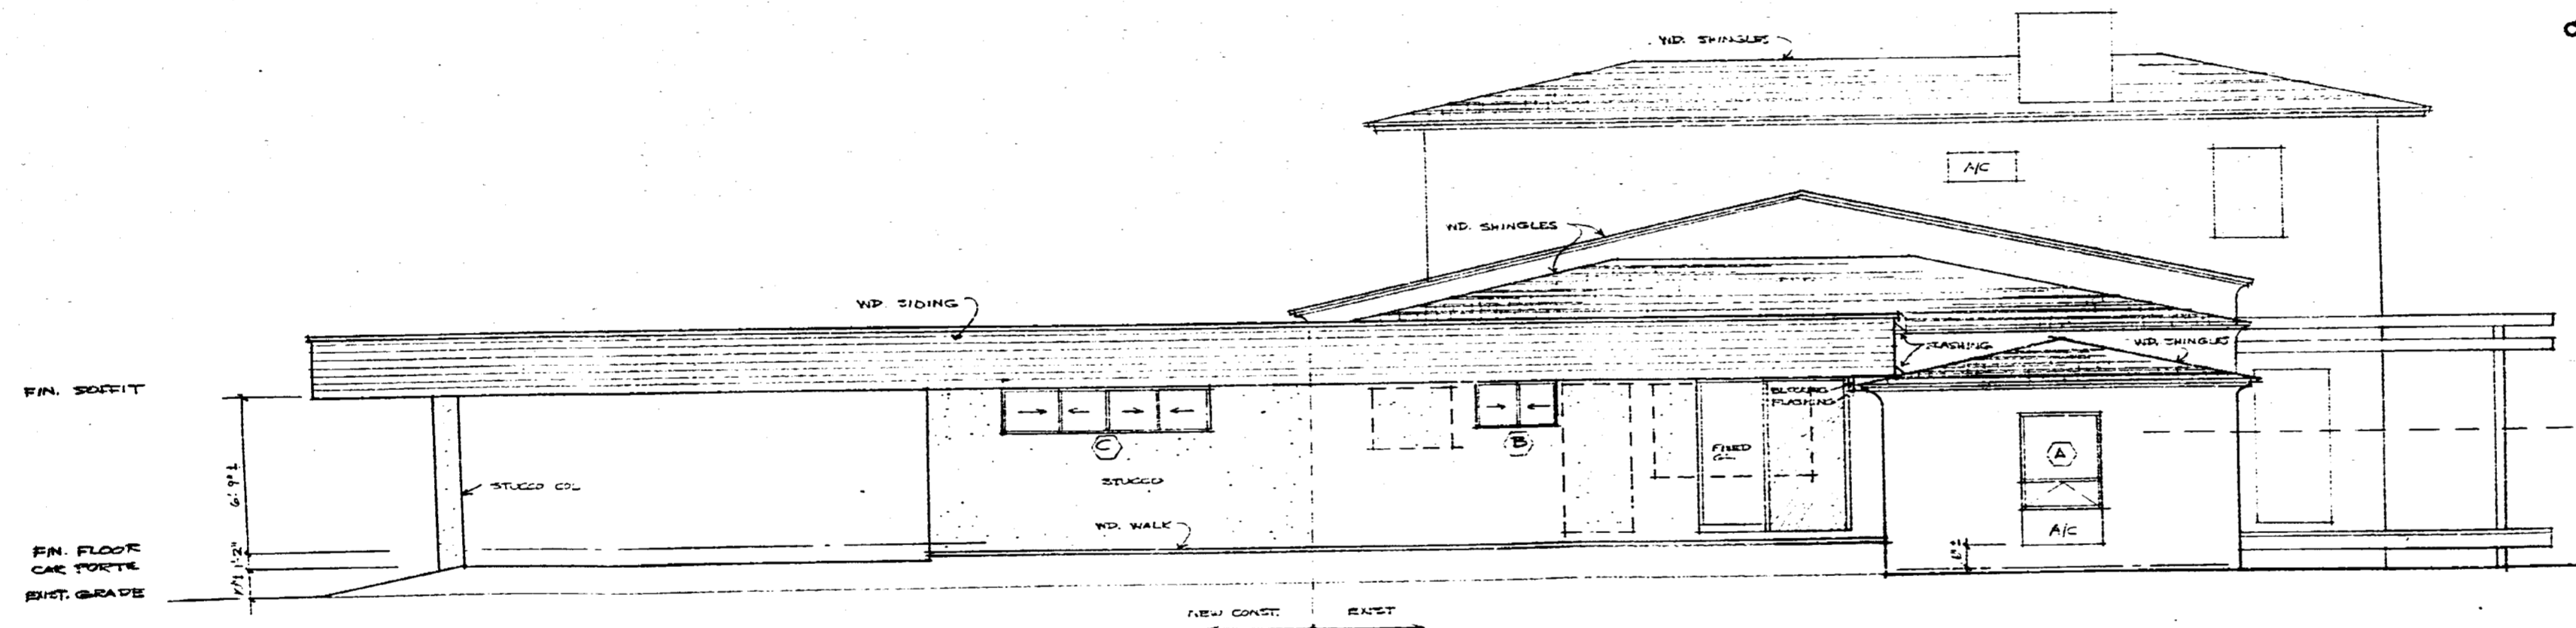

NORTH ELEVATION 1/4" = 1'-0"

DATE: 8-2-76
DRAWN BY: _____
REVISIONS: _____


TERMIN RESIDENCE REMODELING
424 W. DILIDO DR. MIAMI BEACH FLA.

STANLEY H. GREENE
ARCHITECT **PLANNER**
1460 BRICKELL AVENUE MIAMI FLORIDA 33131

[Handwritten signature]

MASTER PLAN
PHASE ONE
4 of 7

89185

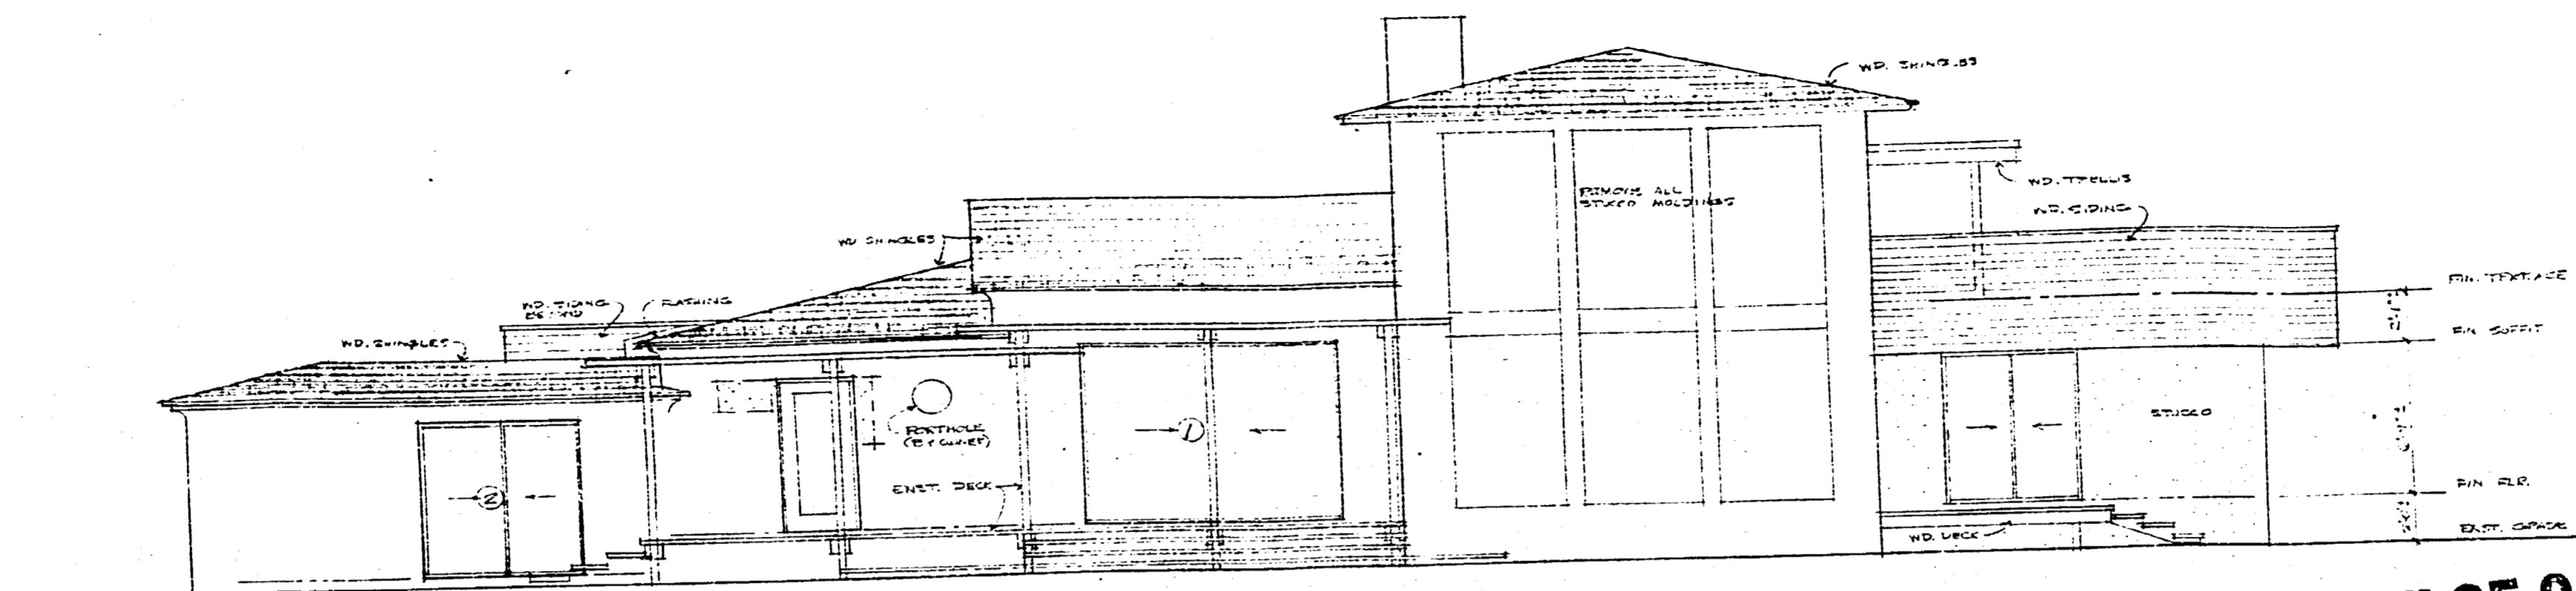


WEST ELEVATION 1/4" = 1'-0"

OFFICE COPY

RECEIVED
OCT 9 1978
BUILDING INSPECTION DIVISION

CITY OF MIAMI BEACH
APPROVED
DATE: 10/11/78
NAME: [Signature]
PLUMBING BY: [Signature]
ELECTRICAL BY: [Signature]
MECHANICAL BY: [Signature]
FIRE PROTECTION ENGINEER

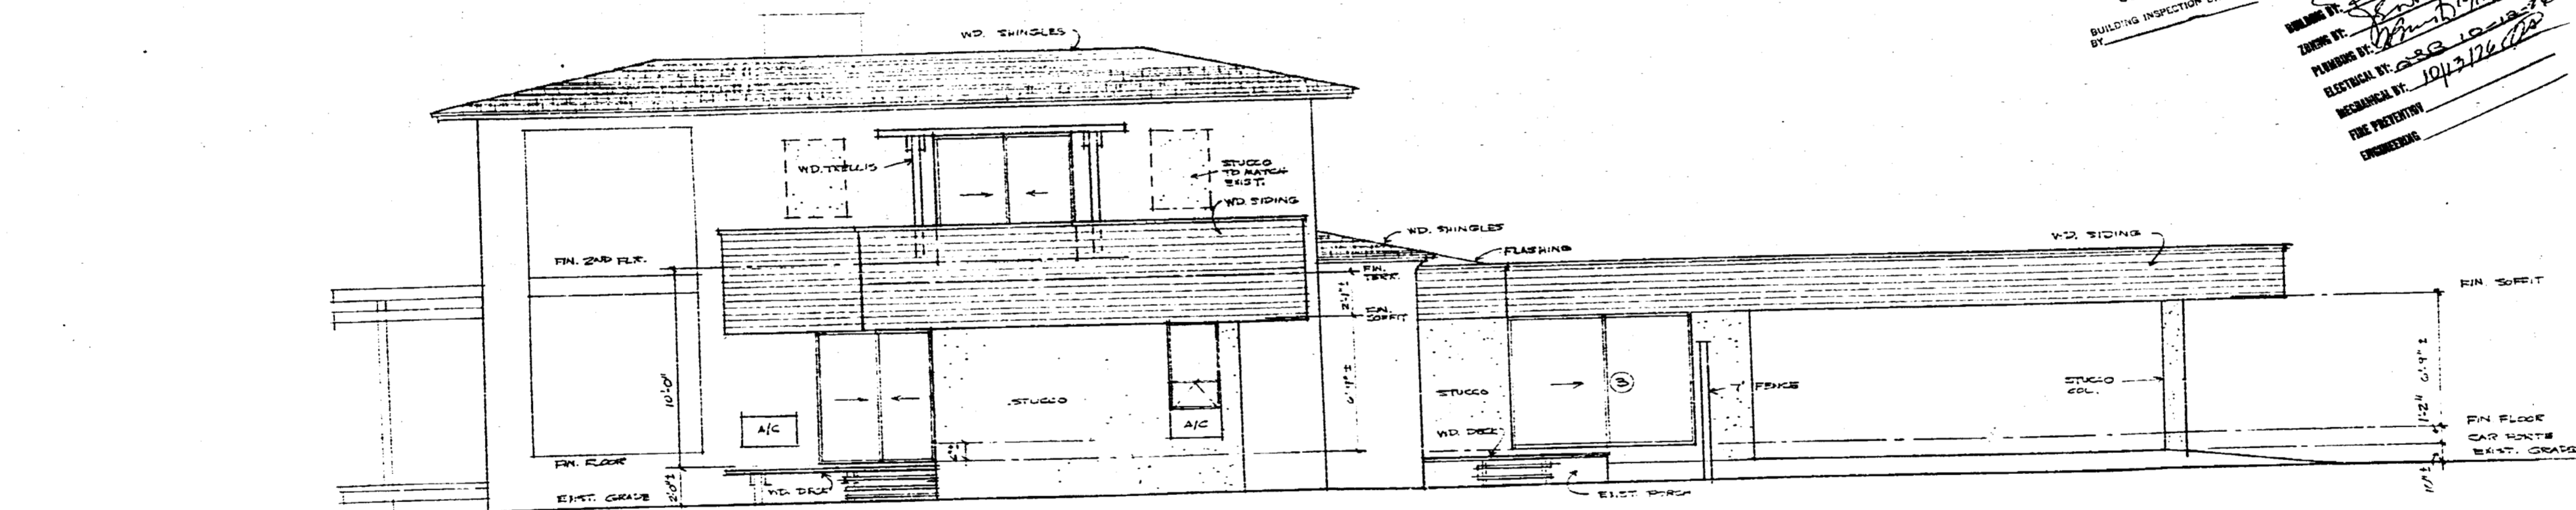

SOUTH ELEVATION 1/4" = 1'-0"

DATE: 8-2-76
DRAWN BY: _____
REVISIONS: _____


TERMIN RESIDENCE REMODELING
424 W. DILIDO DR. MIAMI BEACH FLA.

STANLEY H. GREENE
ARCHITECT PLANNER
1480 BRICKELL AVENUE MIAMI FLORIDA 33131


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MASTER PLAN
PHASE ONE
5 OF 7

89185

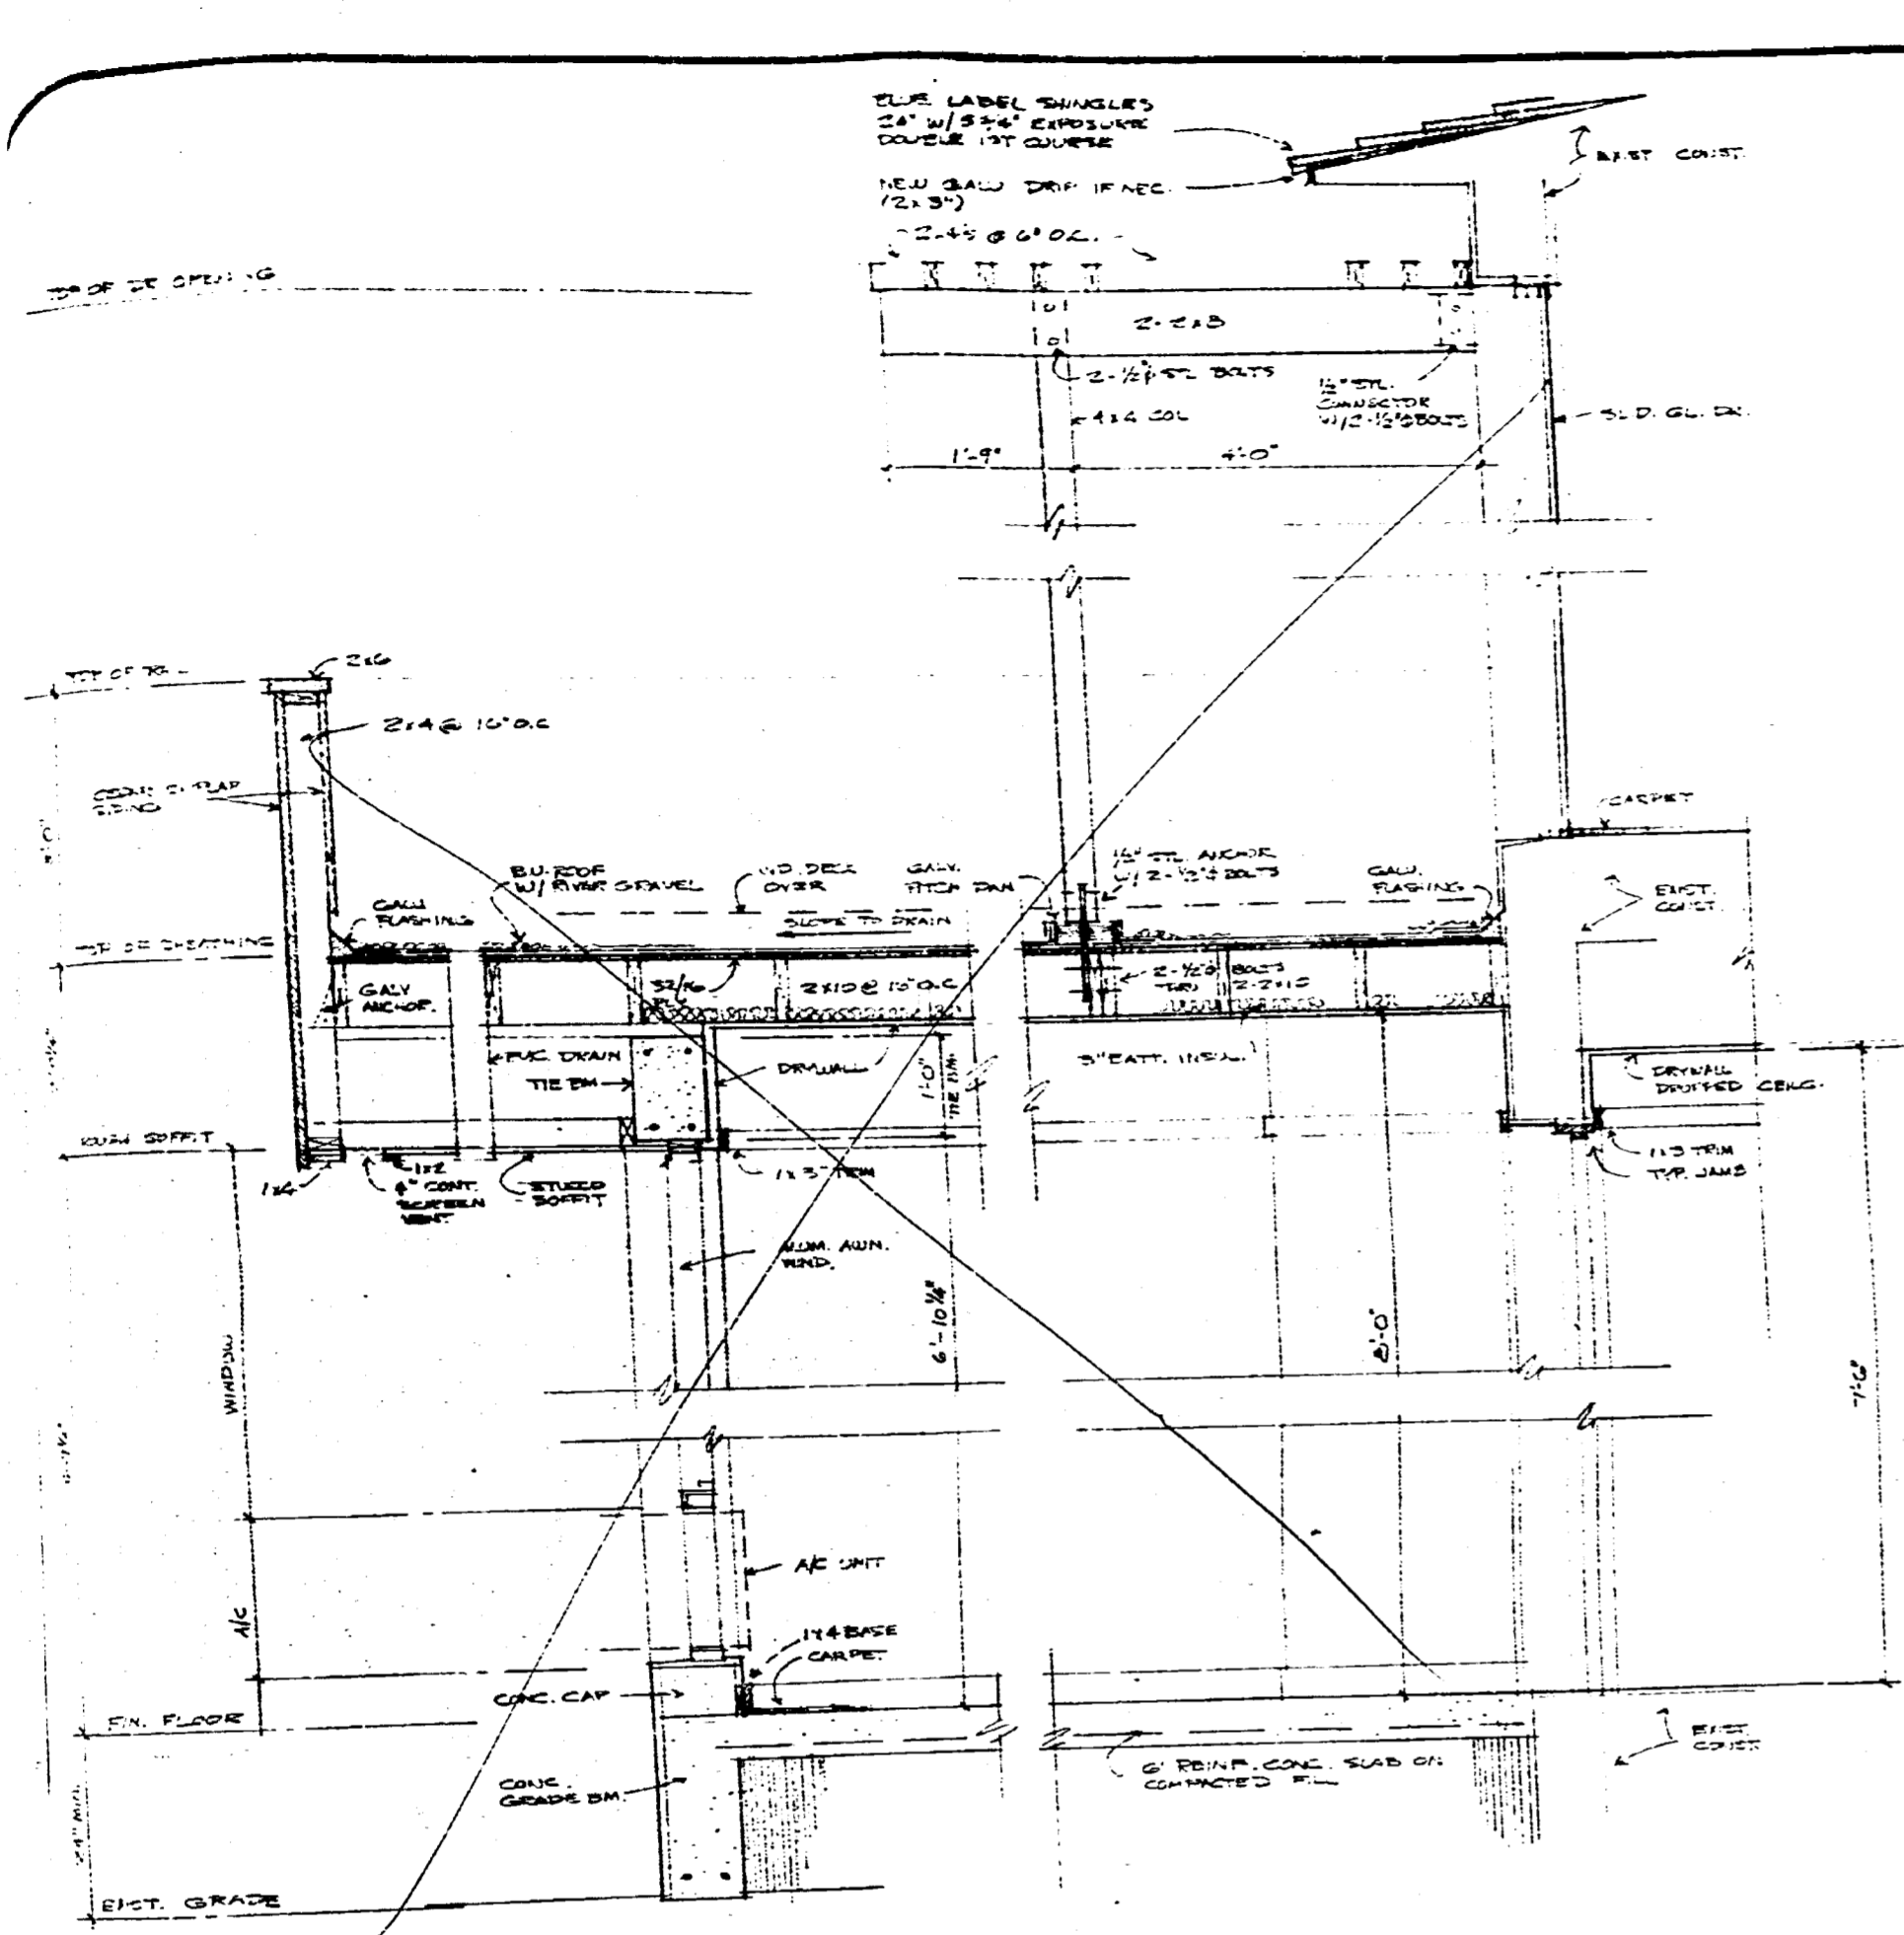


SECTION 1
3/4" = 1'-0"

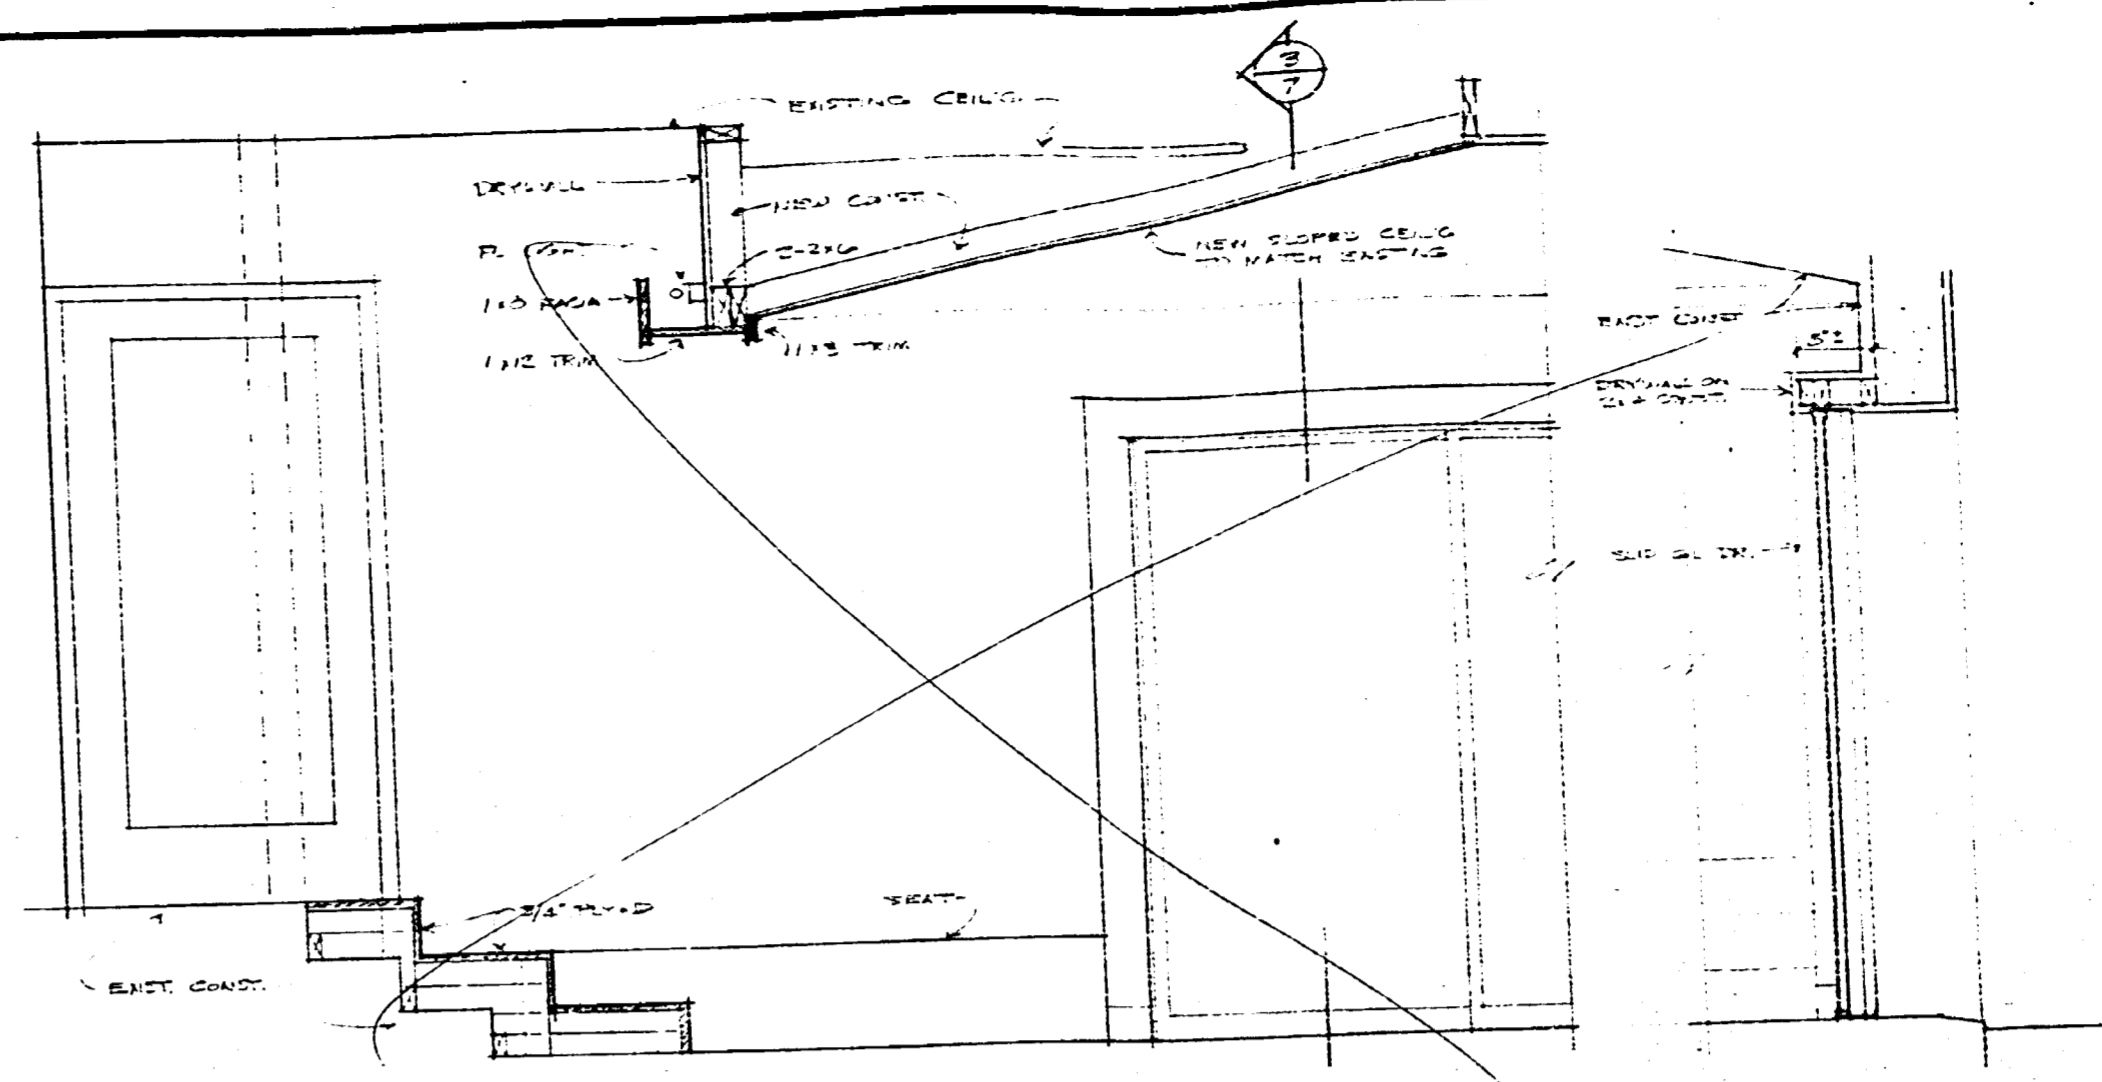

SECTION 2
3/4" = 1'-0"

SECTION 3
3/4" = 1'-0"

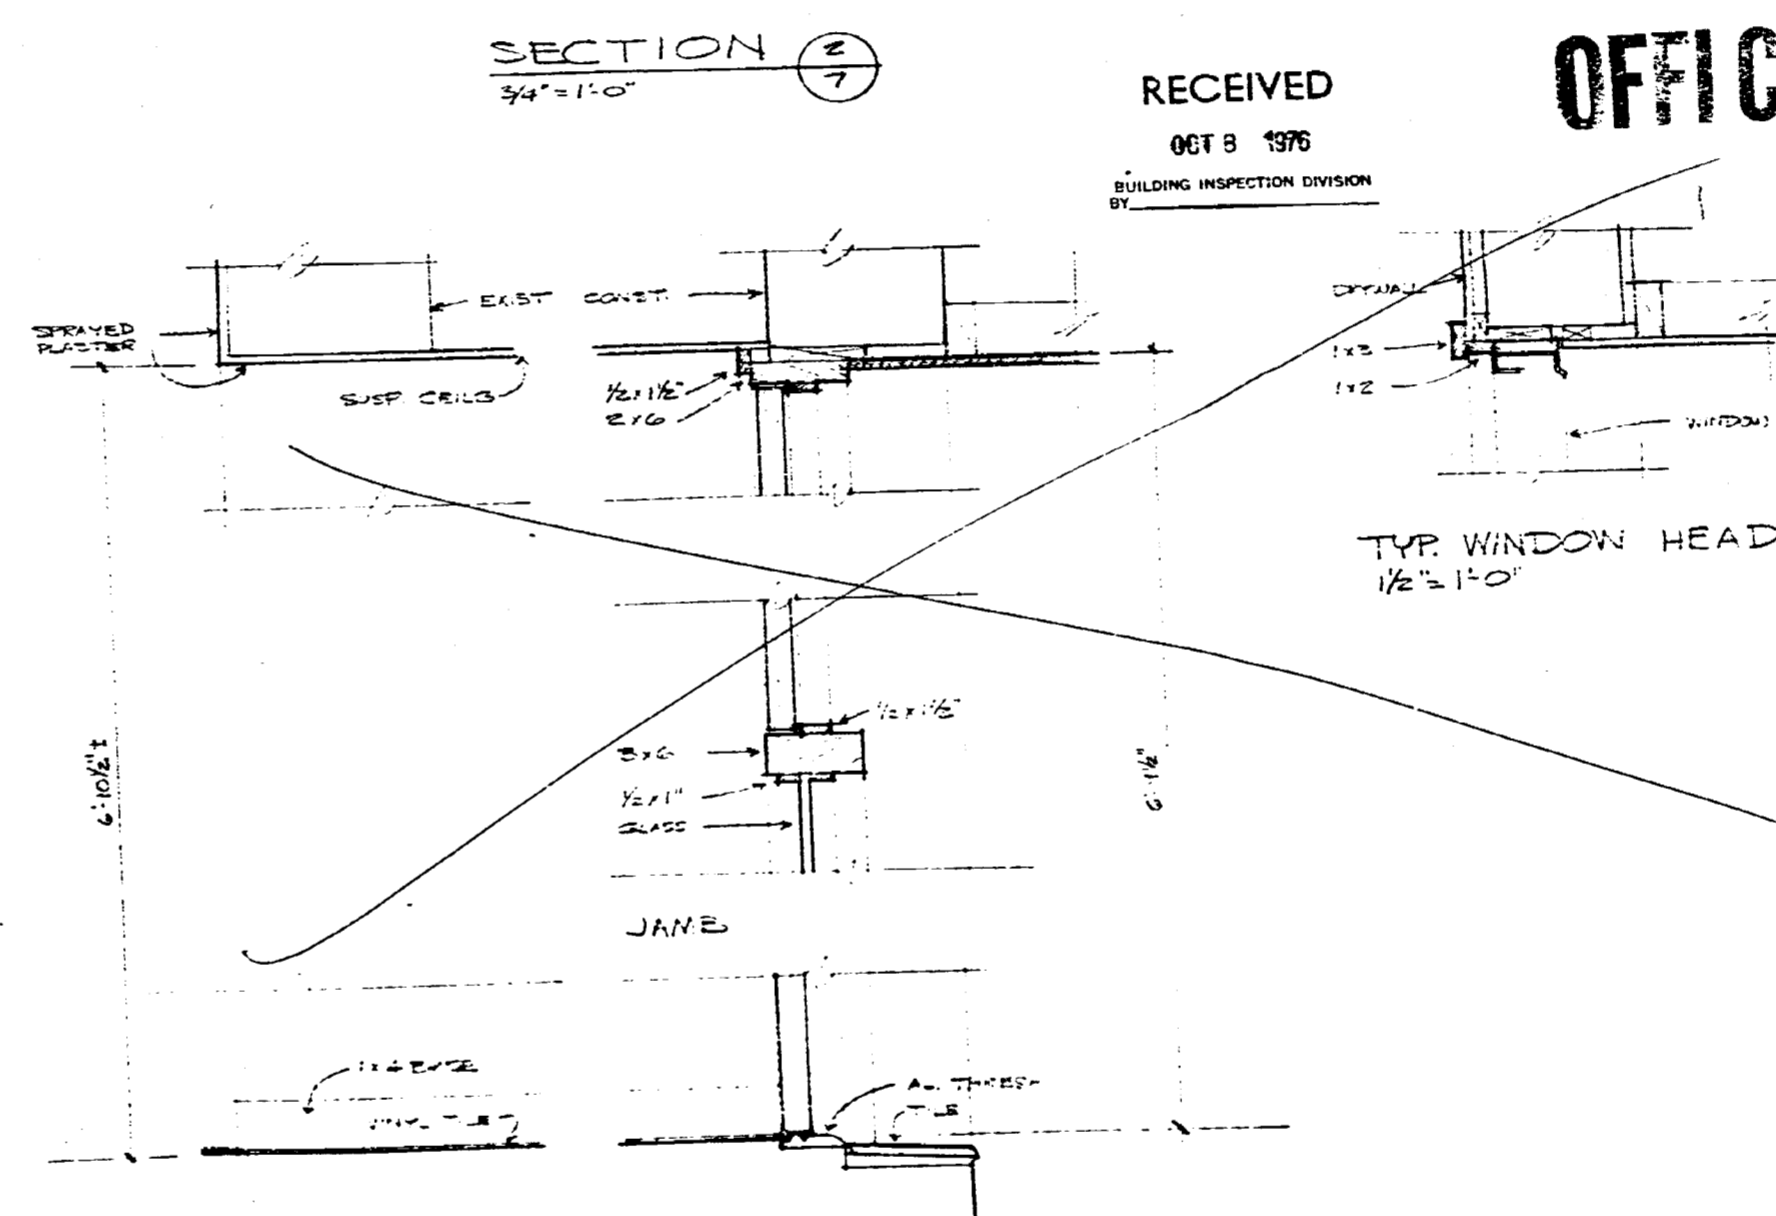

SECTION 4
1/2" = 1'-0"

RECEIVED
OCT 8 1976
BUILDING INSPECTION DIVISION
BY _____

OFFICE COPY

CITY OF MIAMI BEACH
APPROVED
DATE 10/12/76
INSPECTED BY [Signature] 10/12/76
PLUMBING BY [Signature] 10/12/76
ELECTRICAL BY [Signature] 10/12/76
MECHANICAL BY [Signature] 10/12/76
FIRE PREVENTION
ENGINEERING

TYP. WINDOW HEAD
1/2" = 1'-0"


DATE 8-2-76
DRAWN BY _____
REVISIONS _____

TERMIN RESIDENCE REMODELING
424 W. DILIDO DR. MIAMI BEACH FLA.


STANLEY H. GREENE
ARCHITECT PLANNER
1480 BRICKELL AVENUE MIAMI FLORIDA 33131

MASTER PLAN
PHASE ONE
7 OF 7


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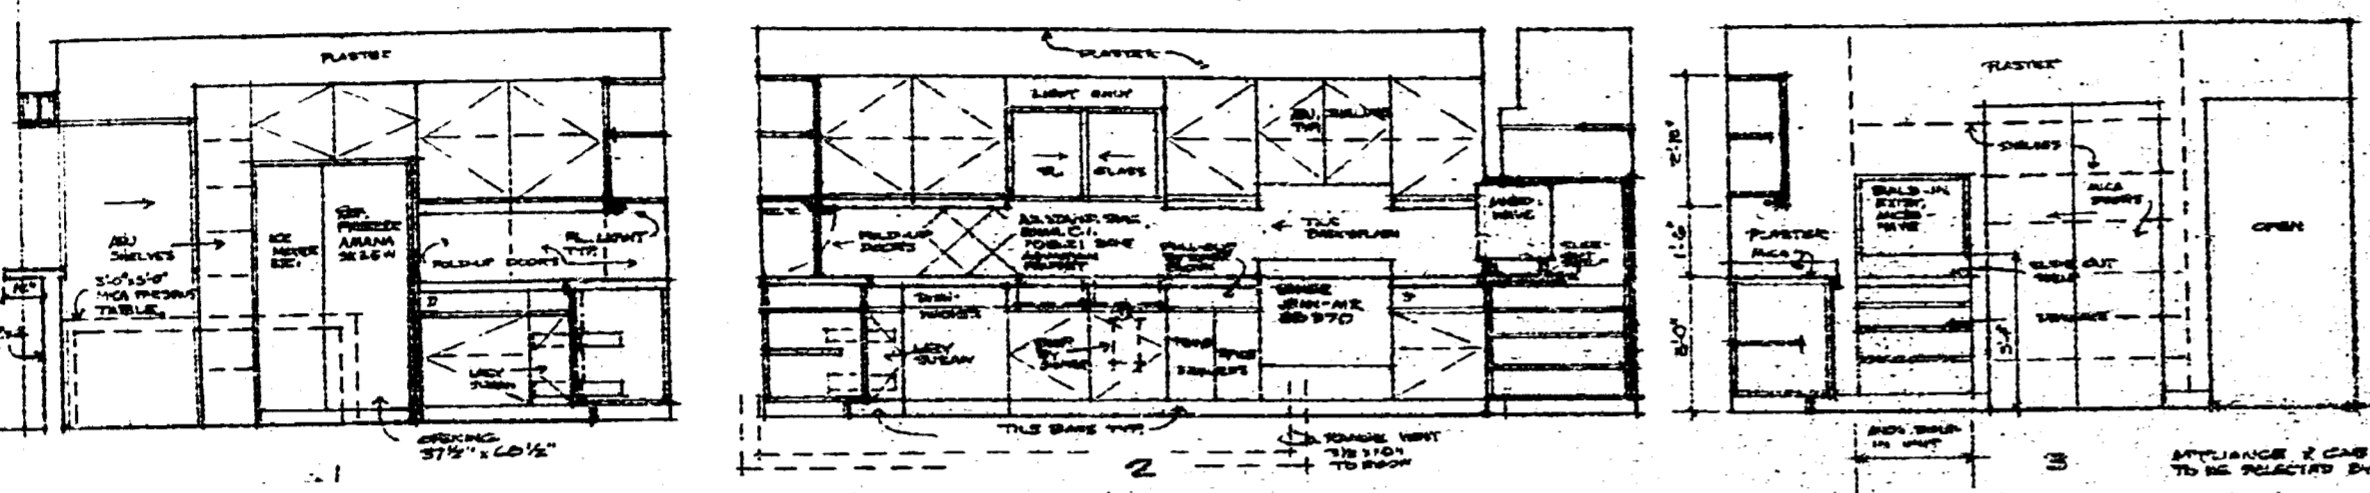
MASTER BATH 3/8" = 1'-0"
FIN. COLOR: PAUN BRIDGE

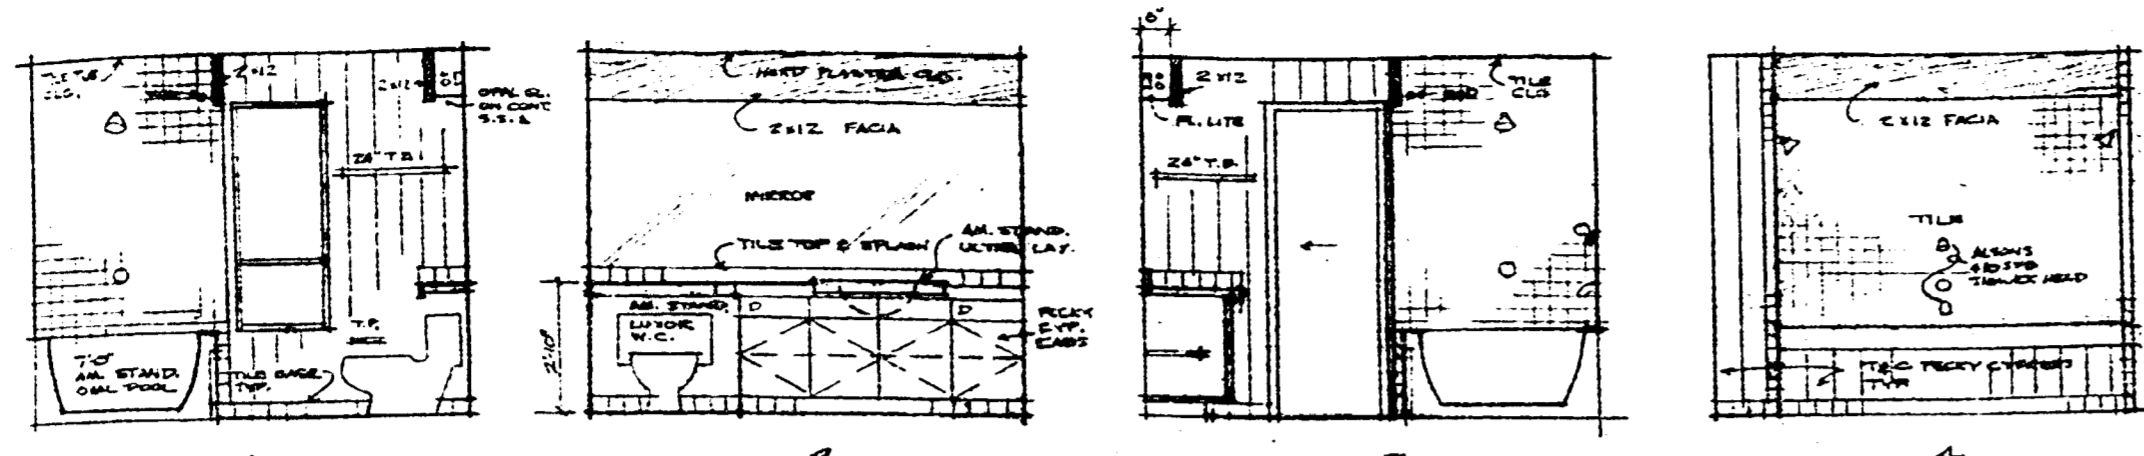


POWDER RM. DET. 3/8" = 1'-0"

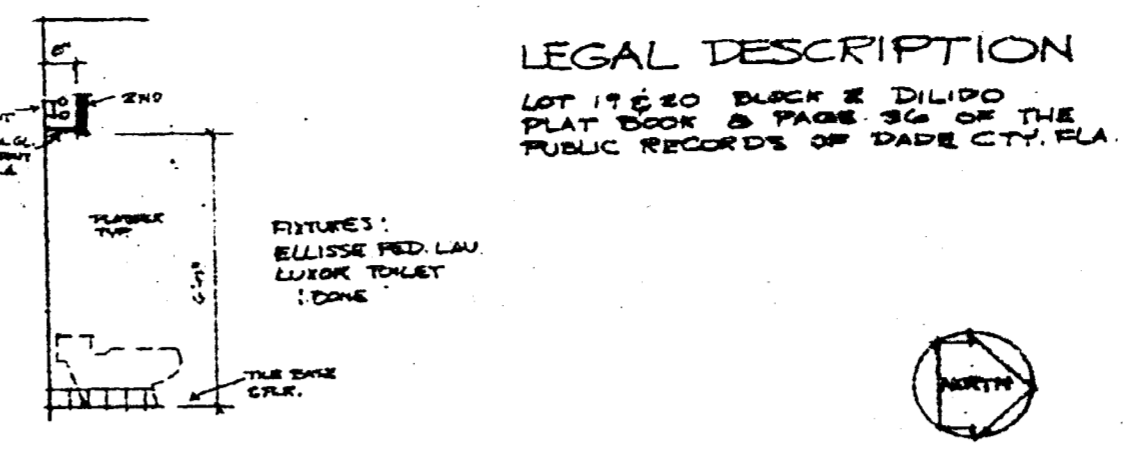


CITY OF MIAMI BEACH
APPROVED
RECEIVED
SEP 5 1978
PLANNING DEPT.
ENGINEERING
STANLEY H. GREENE ARCHITECT
1400 BRICKELL AVENUE MIAMI FLORIDA 33131

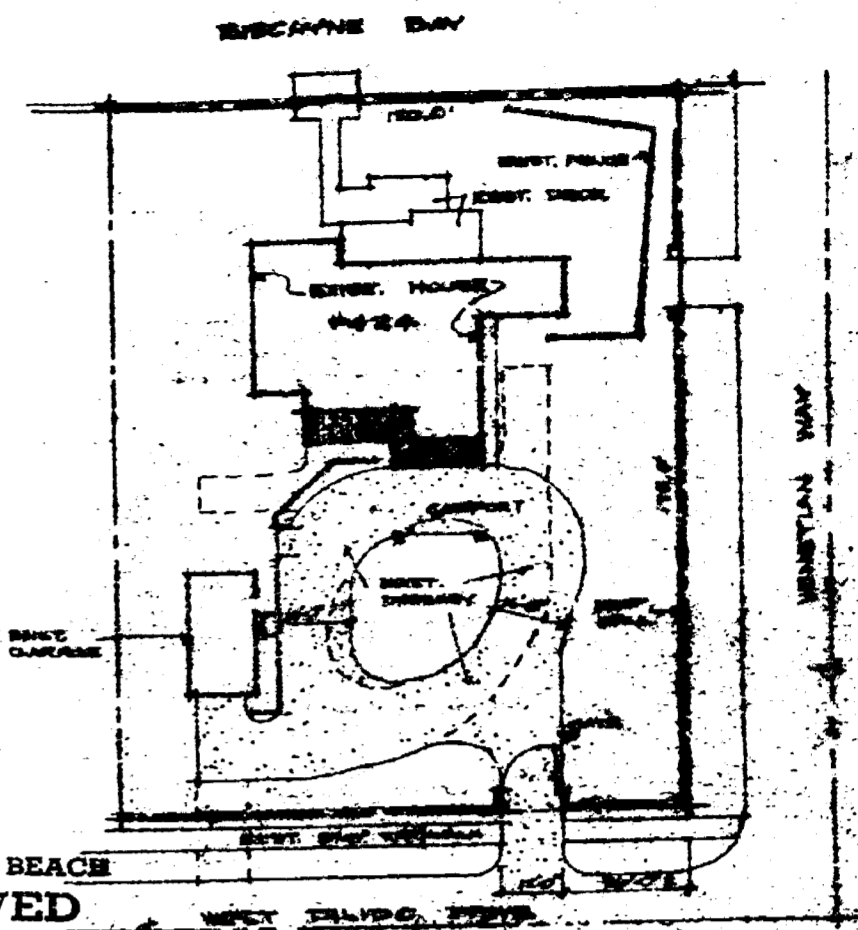


KITCHEN 3/8" = 1'-0"

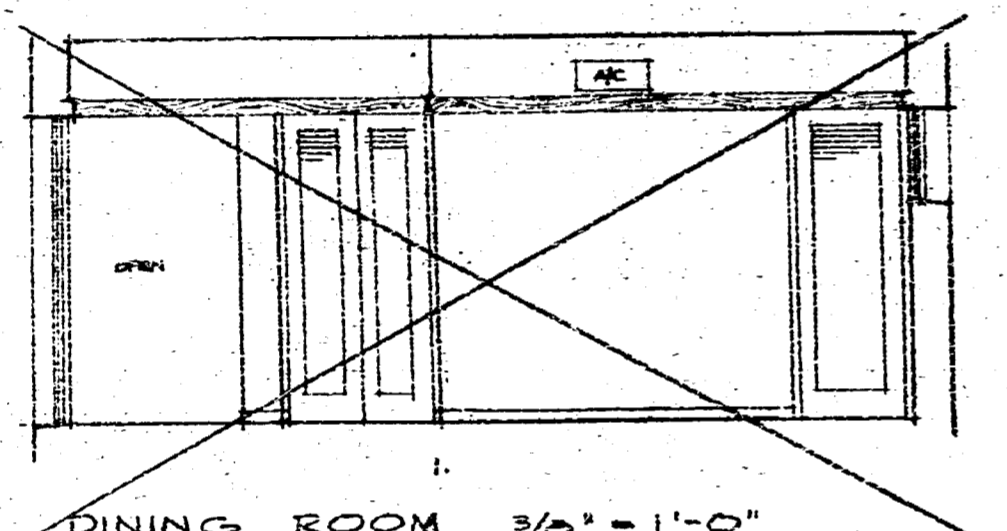

DINING ROOM 3/8" = 1'-0"

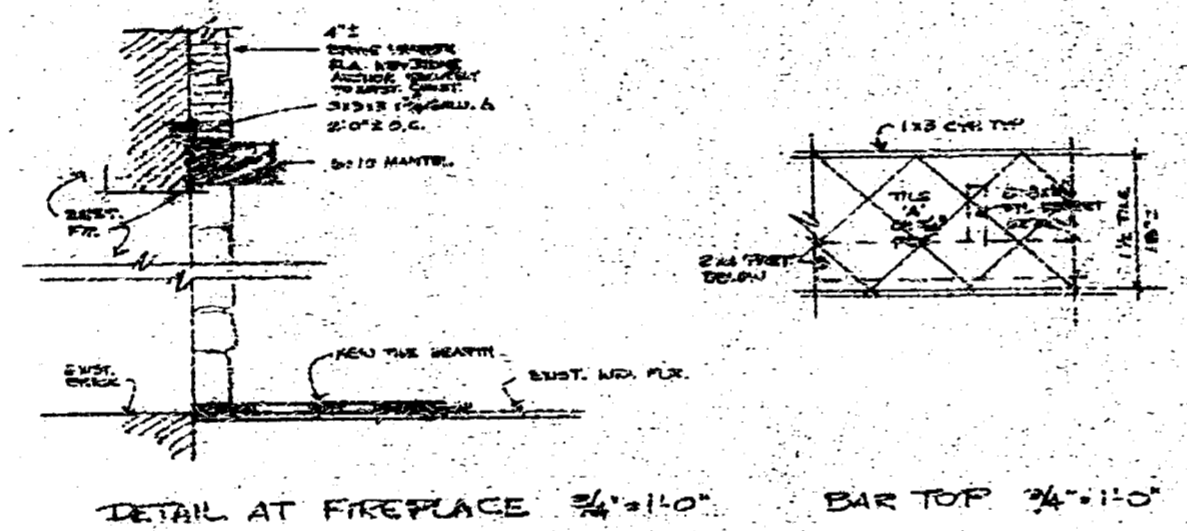

DETAIL AT FIREPLACE 3/4" = 1'-0"
BAR TOP 3/4" = 1'-0"

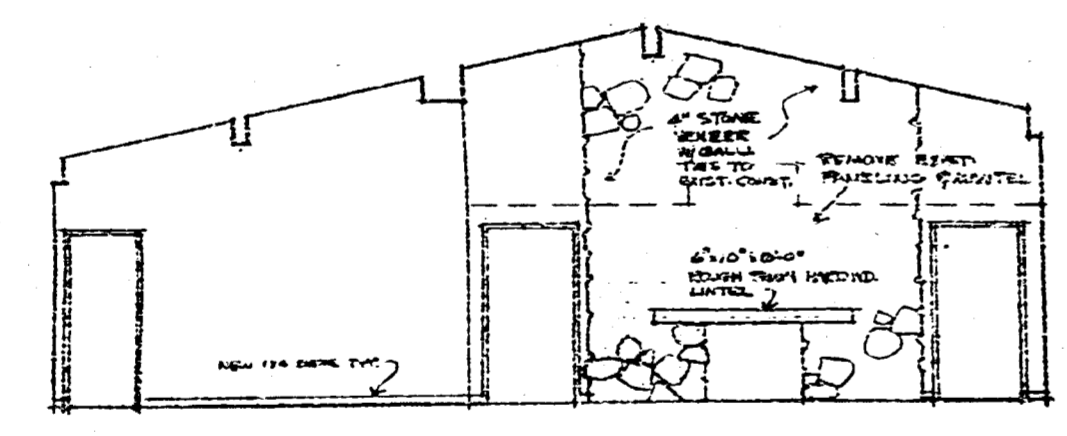

LIVING ROOM 1/2" SCALE

GENERAL NOTES:

CONCRETE SHALL BE OF THE HIGHEST QUALITY...
KITCHEN & BATH CABINETS TO BE PLAIN...
LIGHTING: RECESSED TRACK LIGHTING...
ELECTRICAL: ALL APPLIANCES TO BE INSTALLED...
PLUMBING: ALL FIXTURES TO BE INSTALLED...

OFFICE COPY

THE CONTRACTOR SHALL VERIFY DIMENSIONS AT THE INTERSECTION OF...
USE TO BE LIGHT CLEAN...
ELECTRICAL: ALL APPLIANCES TO BE INSTALLED...
PLUMBING: ALL FIXTURES TO BE INSTALLED...

NO.	TYPE	MATERIAL	FRAME	FINISH	REMARKS
1	6'0" x 7'0"	WOOD	WOOD	WOOD	ENTRY DOOR
2	6'0" x 7'0"	WOOD	WOOD	WOOD	KITCHEN DOOR
3	6'0" x 7'0"	WOOD	WOOD	WOOD	BATH DOOR
4	6'0" x 7'0"	WOOD	WOOD	WOOD	DINING ROOM DOOR
5	6'0" x 7'0"	WOOD	WOOD	WOOD	LIVING ROOM DOOR
6	6'0" x 7'0"	WOOD	WOOD	WOOD	POWDER ROOM DOOR
7	6'0" x 7'0"	WOOD	WOOD	WOOD	BEDROOM DOOR
8	6'0" x 7'0"	WOOD	WOOD	WOOD	HALL DOOR
9	6'0" x 7'0"	WOOD	WOOD	WOOD	CLOSET DOOR
10	6'0" x 7'0"	WOOD	WOOD	WOOD	BATH DOOR
11	6'0" x 7'0"	WOOD	WOOD	WOOD	POWDER ROOM DOOR

NO.	TYPE	MATERIAL	FINISH	REMARKS
A	6'0" x 7'0"	WOOD	WOOD	LIVING ROOM WINDOW
B	6'0" x 7'0"	WOOD	WOOD	DINING ROOM WINDOW
C	6'0" x 7'0"	WOOD	WOOD	KITCHEN WINDOW
D	6'0" x 7'0"	WOOD	WOOD	BATH WINDOW
E	6'0" x 7'0"	WOOD	WOOD	POWDER ROOM WINDOW
F	6'0" x 7'0"	WOOD	WOOD	BEDROOM WINDOW
G	6'0" x 7'0"	WOOD	WOOD	HALL WINDOW
H	6'0" x 7'0"	WOOD	WOOD	CLOSET WINDOW
I	6'0" x 7'0"	WOOD	WOOD	BATH WINDOW
J	6'0" x 7'0"	WOOD	WOOD	POWDER ROOM WINDOW

DATE: 5-2-78
DRAWN BY: 5-22-78
REVISIONS:



TERMIN RESIDENCE REMODELING
424 W. DILIDO DR. MIAMI BEACH FLA.

STANLEY H. GREENE
ARCHITECT PLANNER
1400 BRICKELL AVENUE MIAMI FLORIDA 33131

MASTER PLAN
PHASE TWO
1 OF 6

89 6 90

I am to have receptacles per 210-25 NE code (if not existing) P.S.

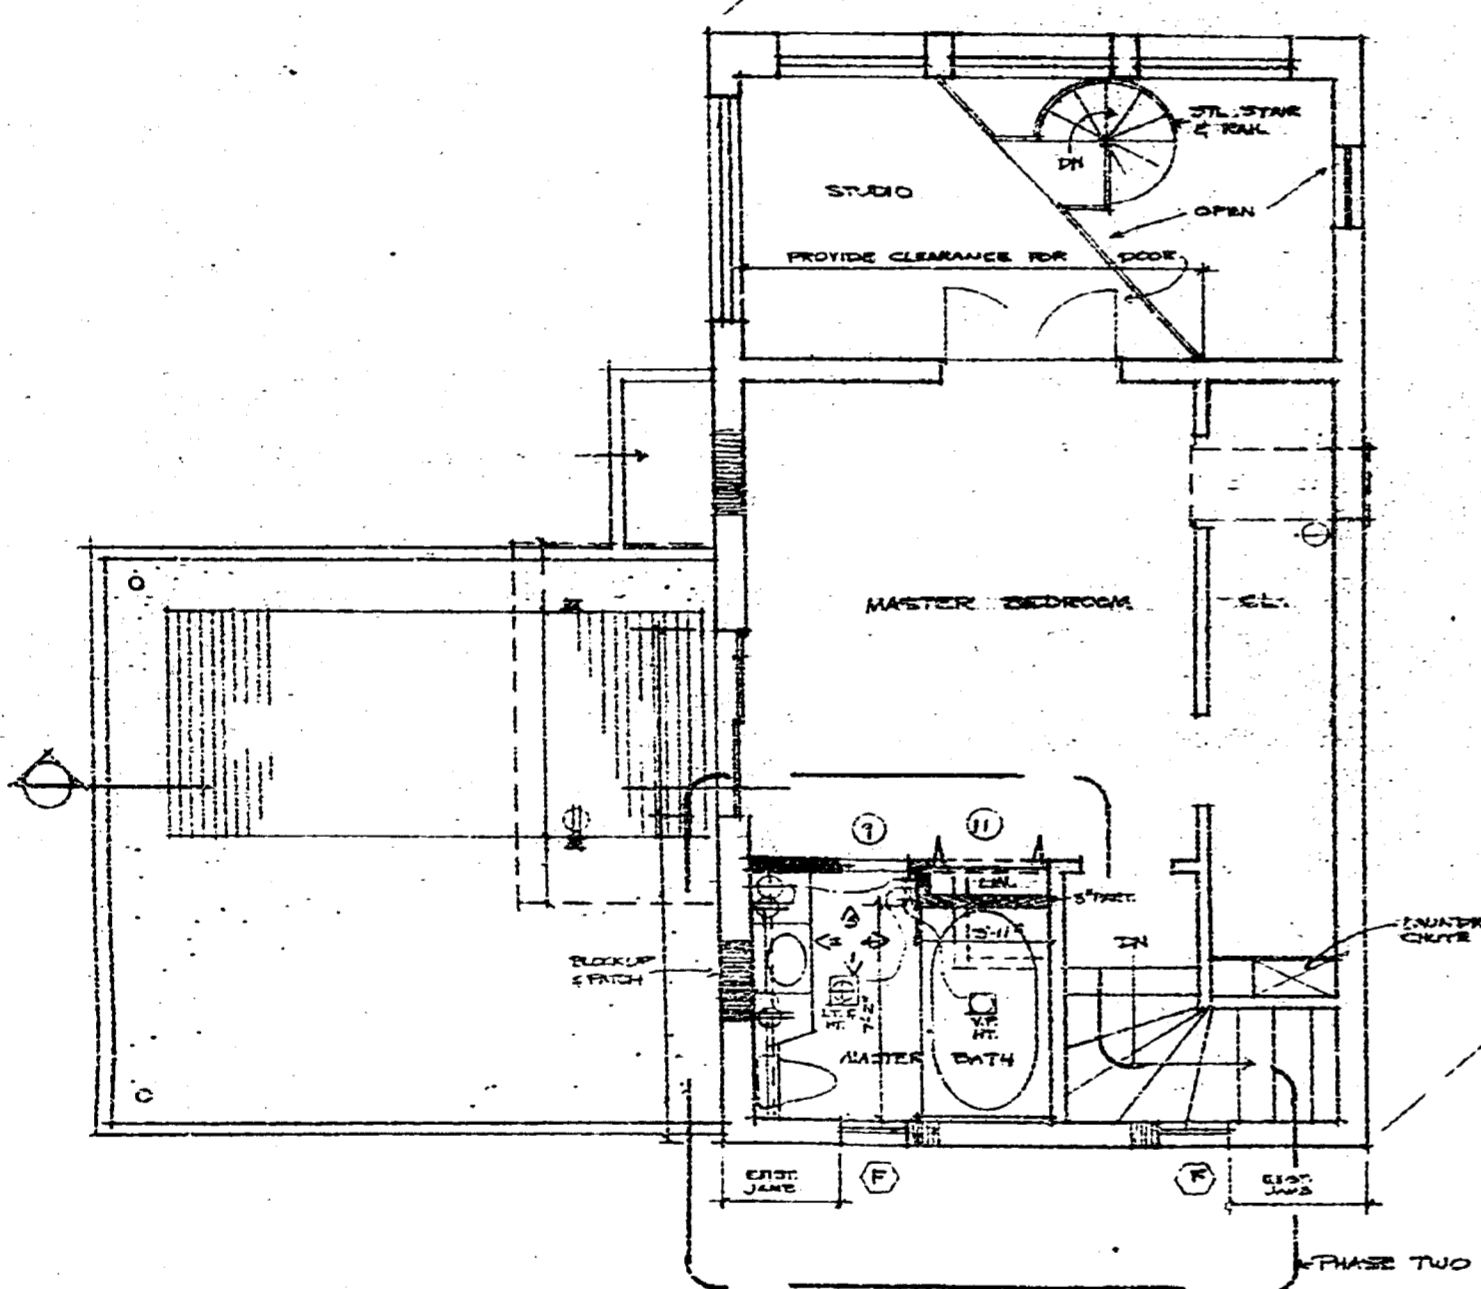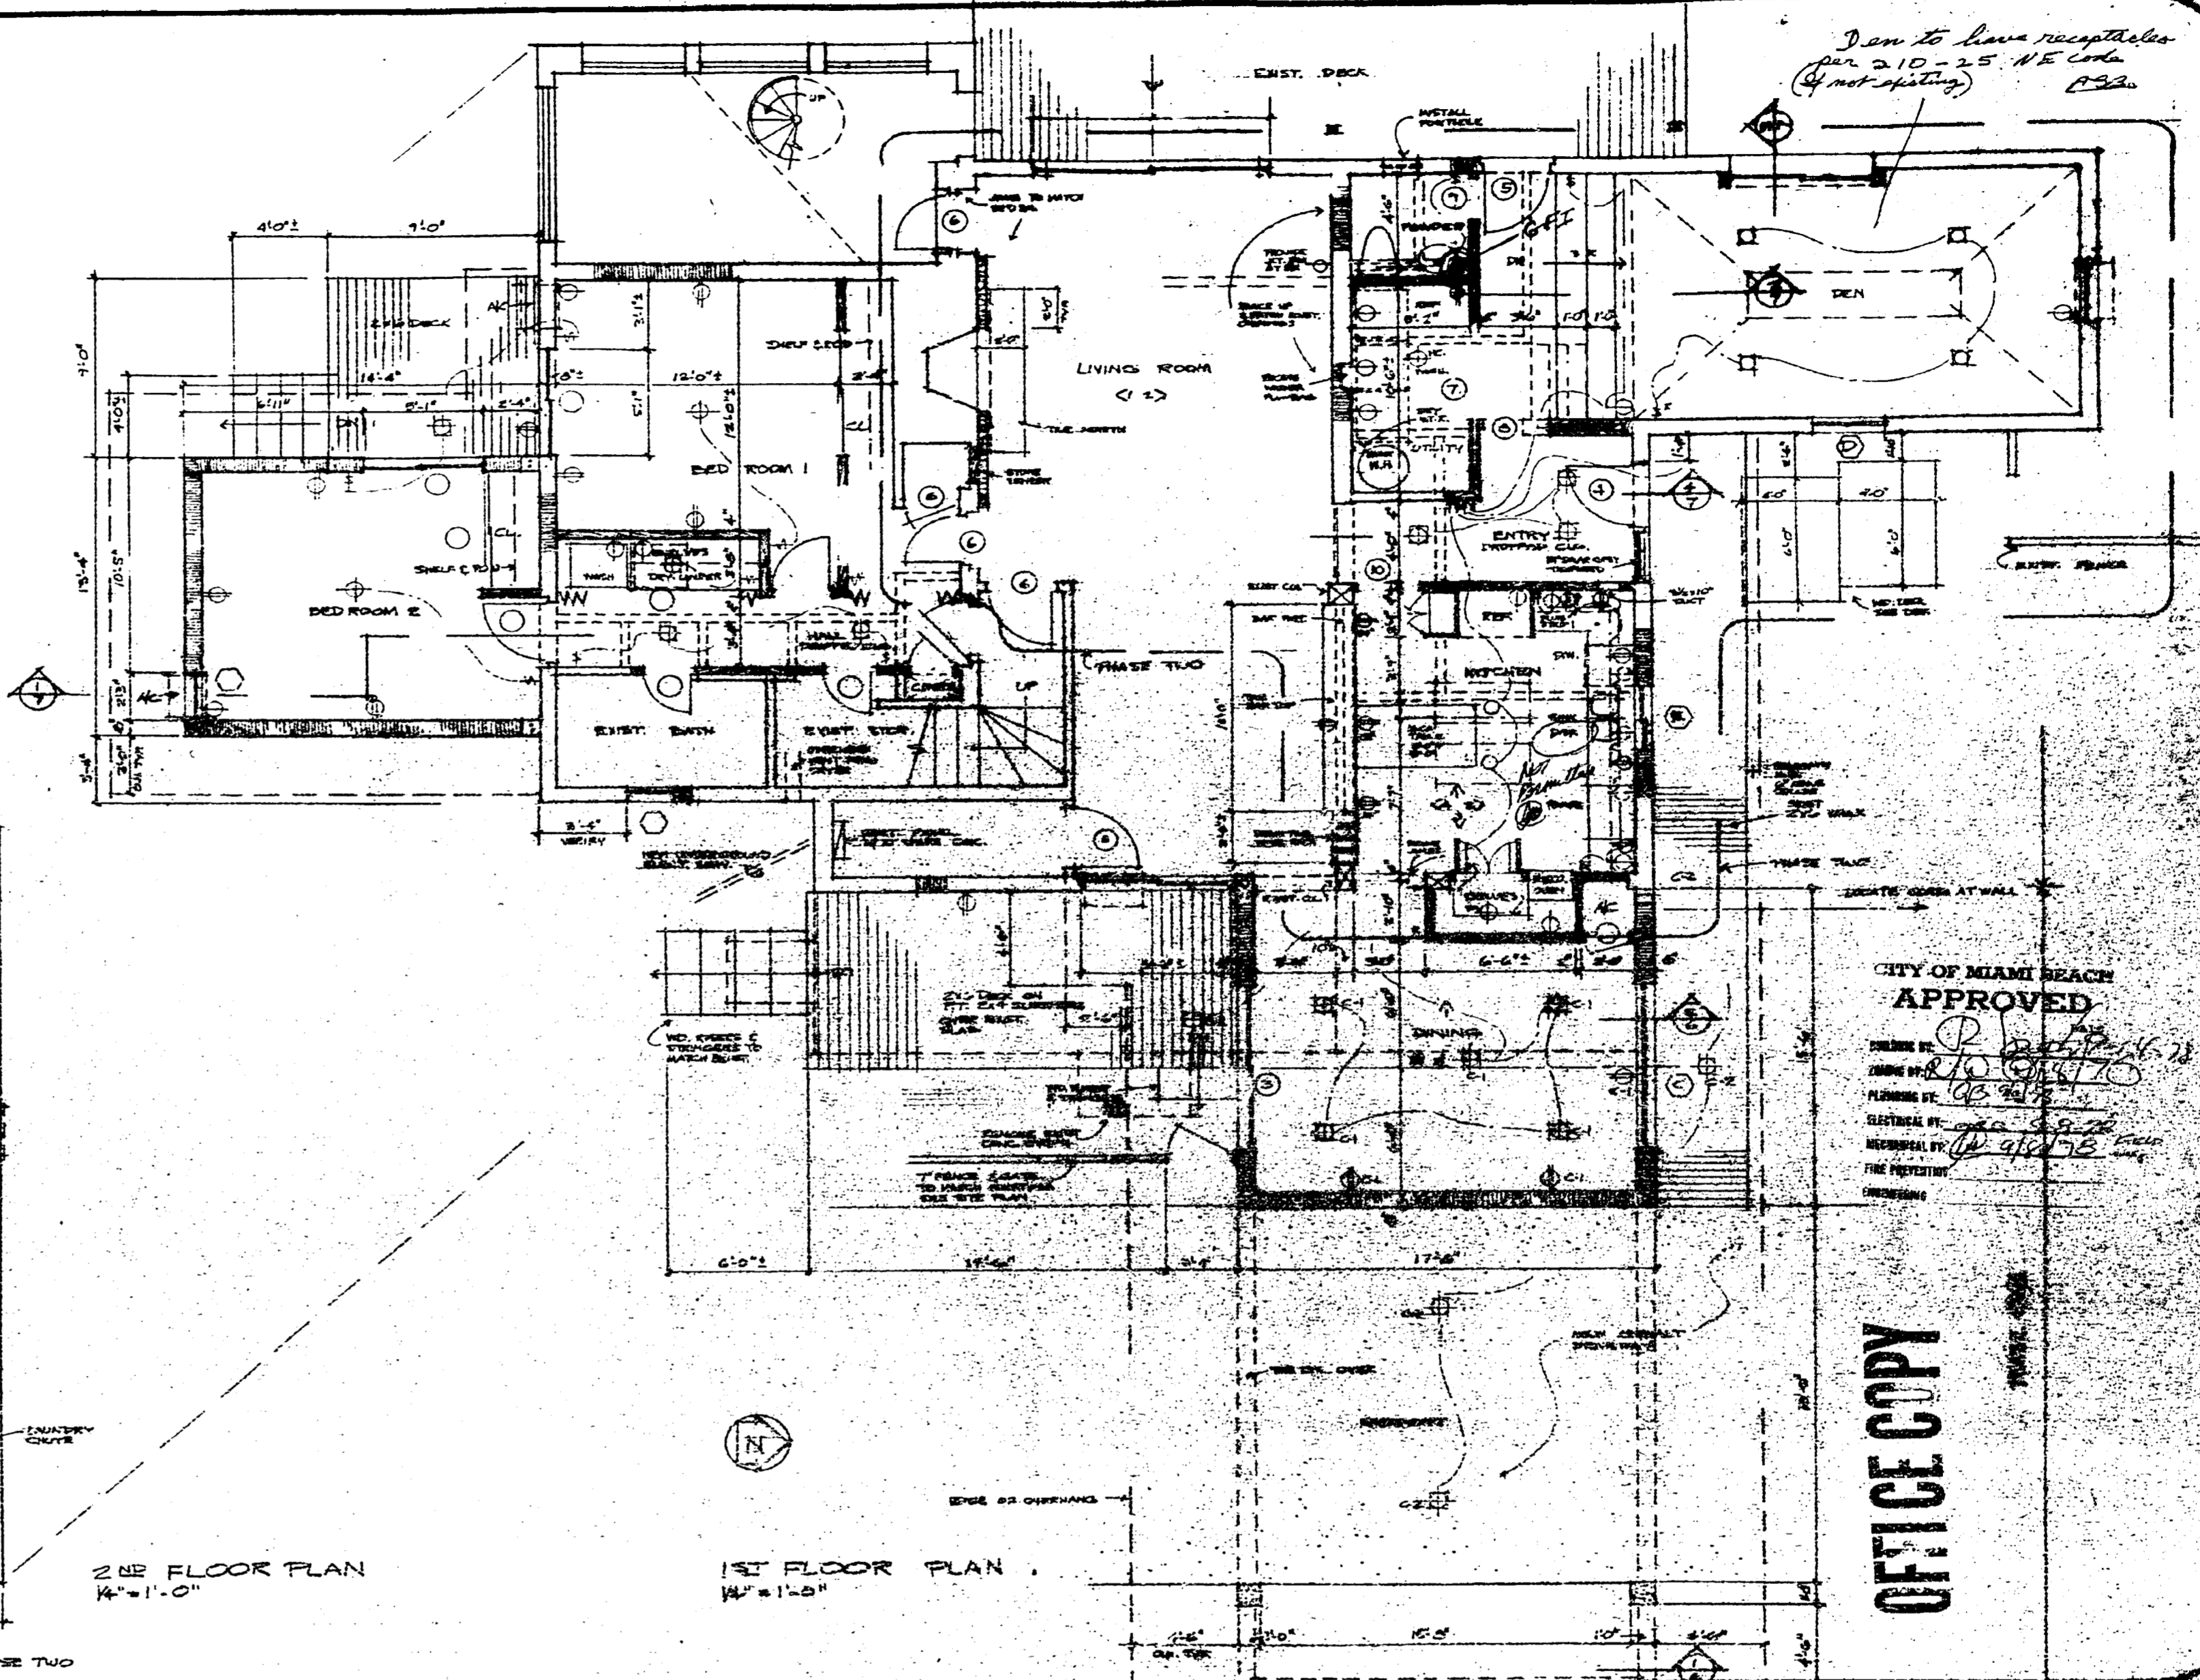

CITY OF MIAMI BEACH
APPROVED
DATE: 8/10/70
PLANNING BY: [Signature]
ELECTRICAL BY: [Signature]
MECHANICAL BY: [Signature]
FIRE PROTECTIVE ENGINEERING

OFFICE COPY


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DRAWN BY: [Signature]
REVISIONS: 5-22-70

TERMIN RESIDENCE REMODELING
424 W. DILIDO DR. MIAMI BEACH FLA.


STANLEY H. GREENE
ARCHITECT PLANNER
1400 SPICKELL AVENUE MIAMI FLORIDA 33131

MASTER PLAN
PHASE TWO
2 OF 6

89 690

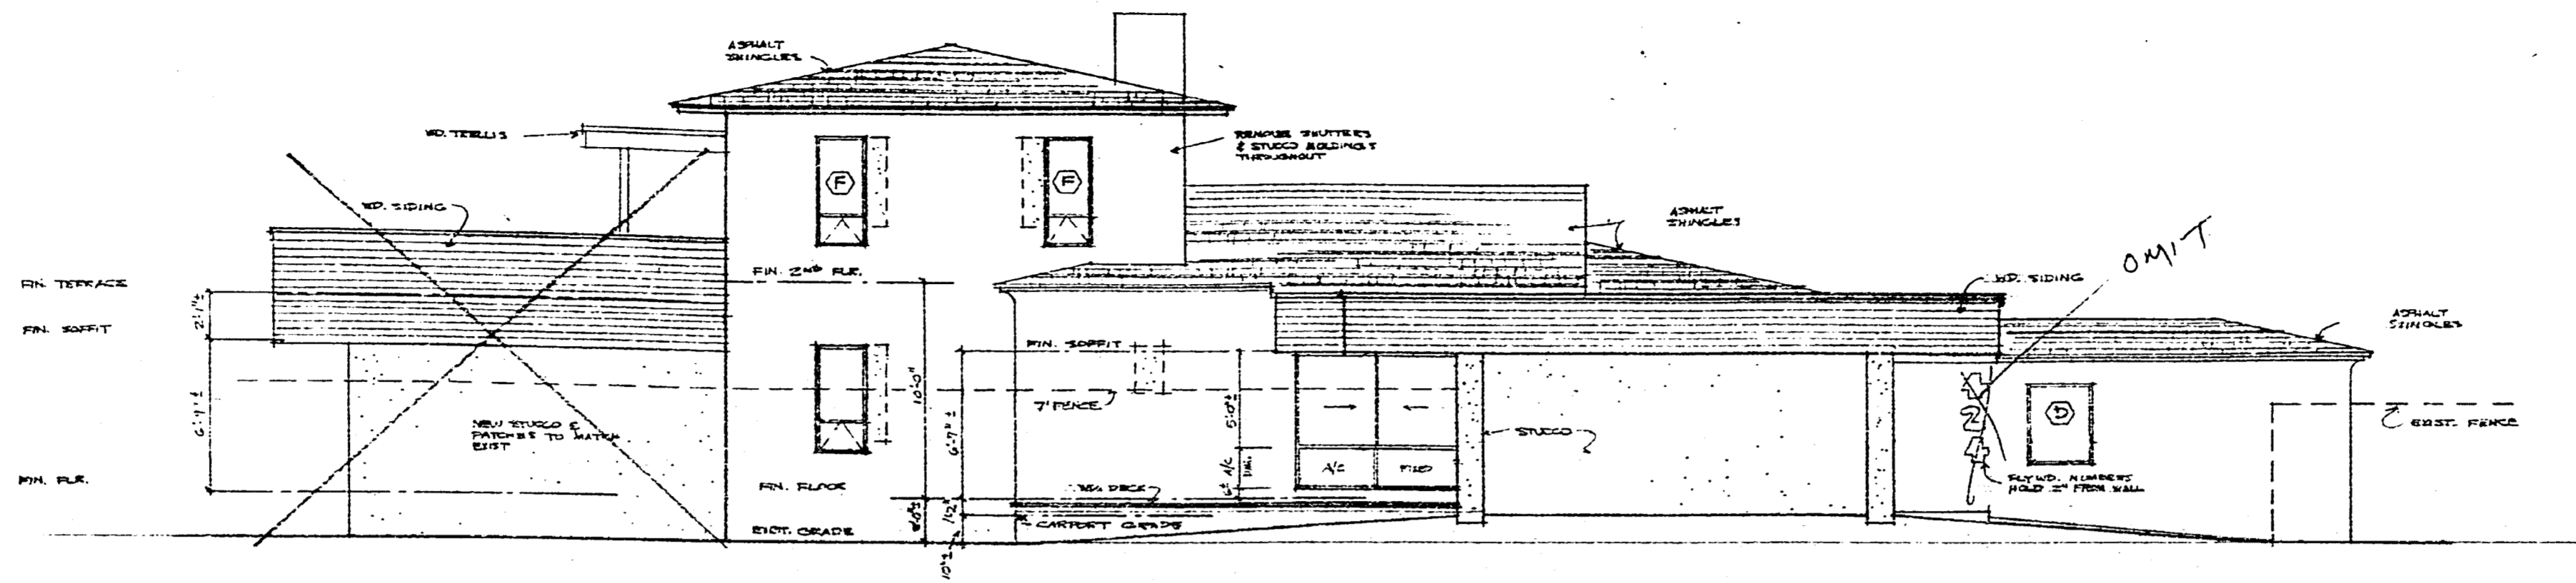

EAST (FRONT) ELEVATION 1/4" = 1'-0"

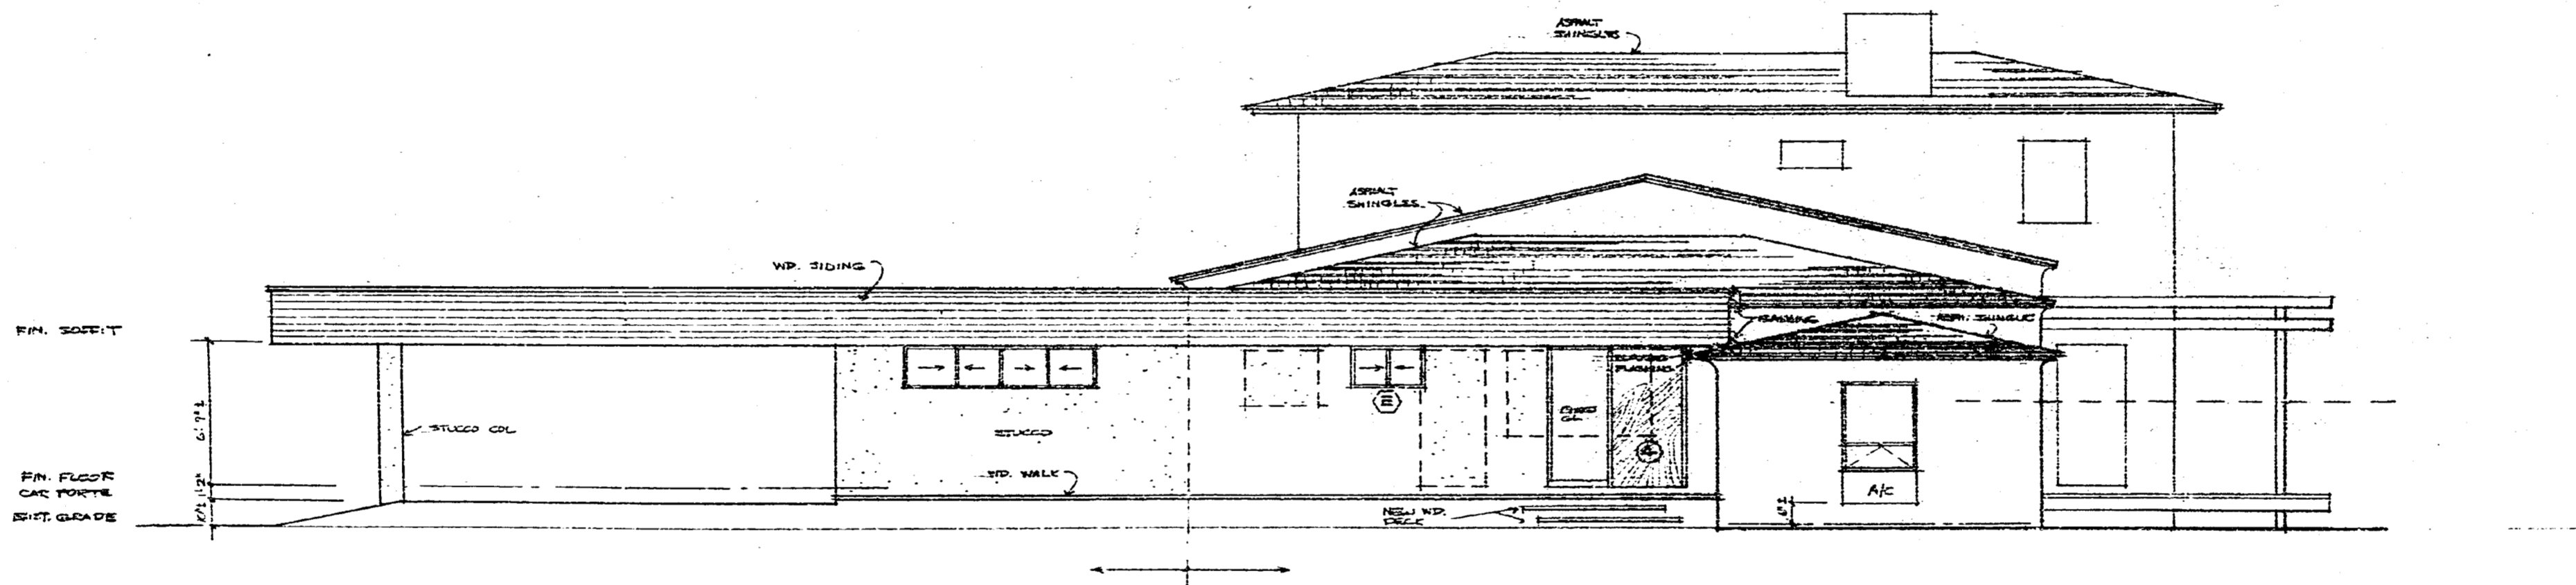

NORTH ELEVATION 1/4" = 1'-0"

CITY OF MIAMI BEACH
APPROVED
 DATE: 5/22/78
 SOLAR BY: [Signature]
 ZONING BY: [Signature]
 PLUMBING BY: AB 7/8/78
 ELECTRICAL BY: ASA 9-8-78
 MECHANICAL BY: W.G. 9-78
 FIRE PREVENTION
 MEMBERSHIP

OFFICE COPY

DATE	5-22-78
DRAWN BY	
REVISIONS	5-22-78


TERMIN RESIDENCE REMODELING
 424 W. DILIDO DR. MIAMI BEACH FLA.

STANLEY H. GREENE
 ARCHITECT PLANNER
 1480 BRICKELL AVENUE MIAMI FLORIDA 33131


[Signature]

MASTER PLAN
 PHASE TWO
 3 OF 6

89 6 90

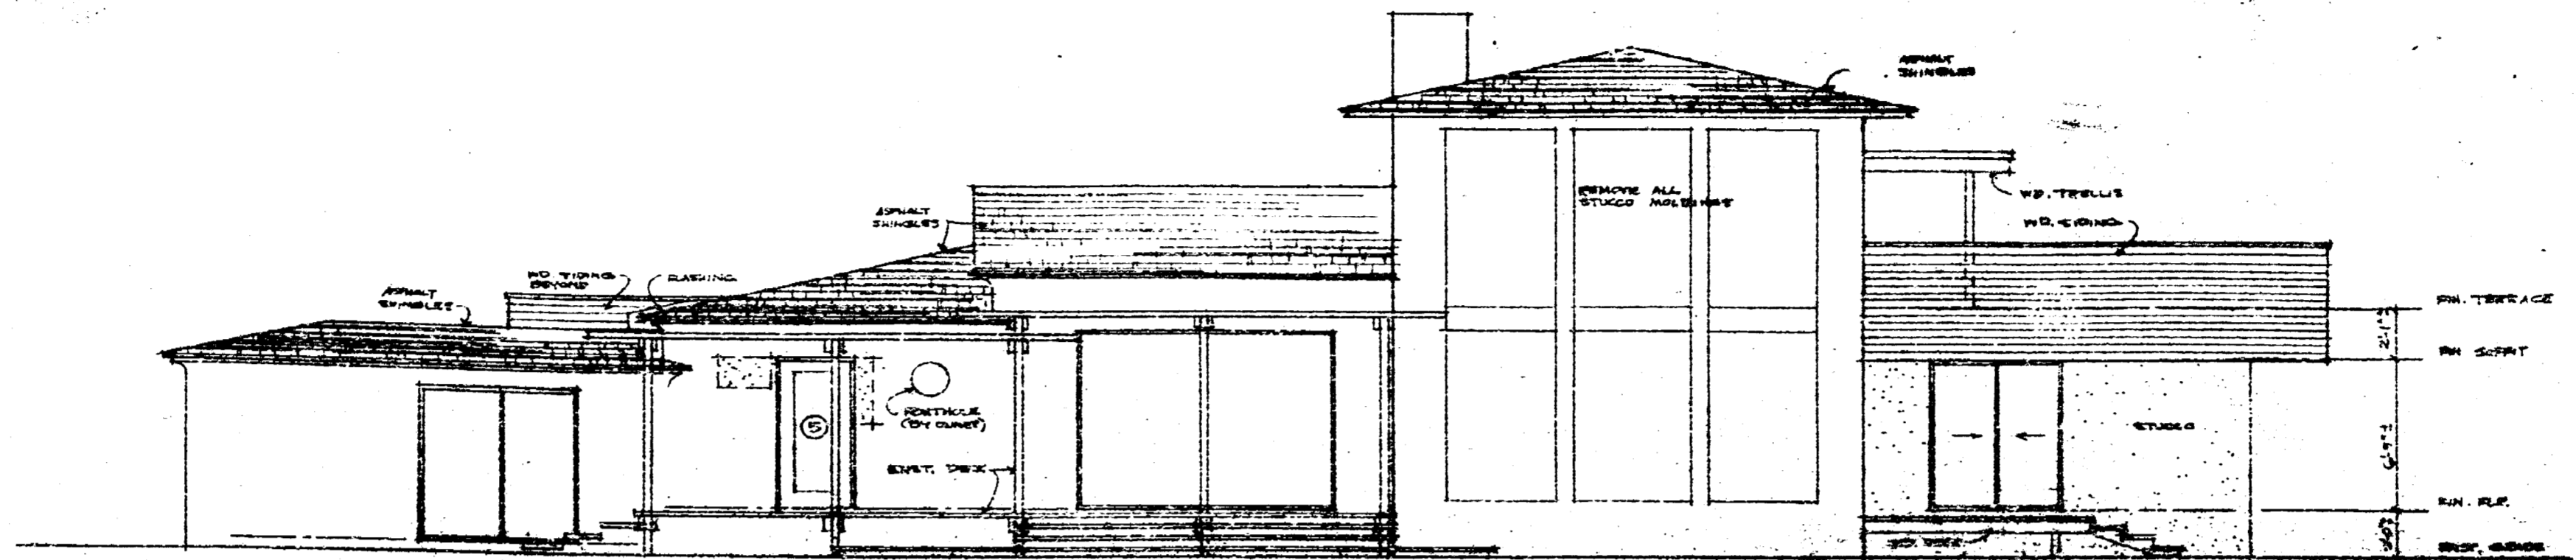

WEST ELEVATION 1/4" = 1'-0"

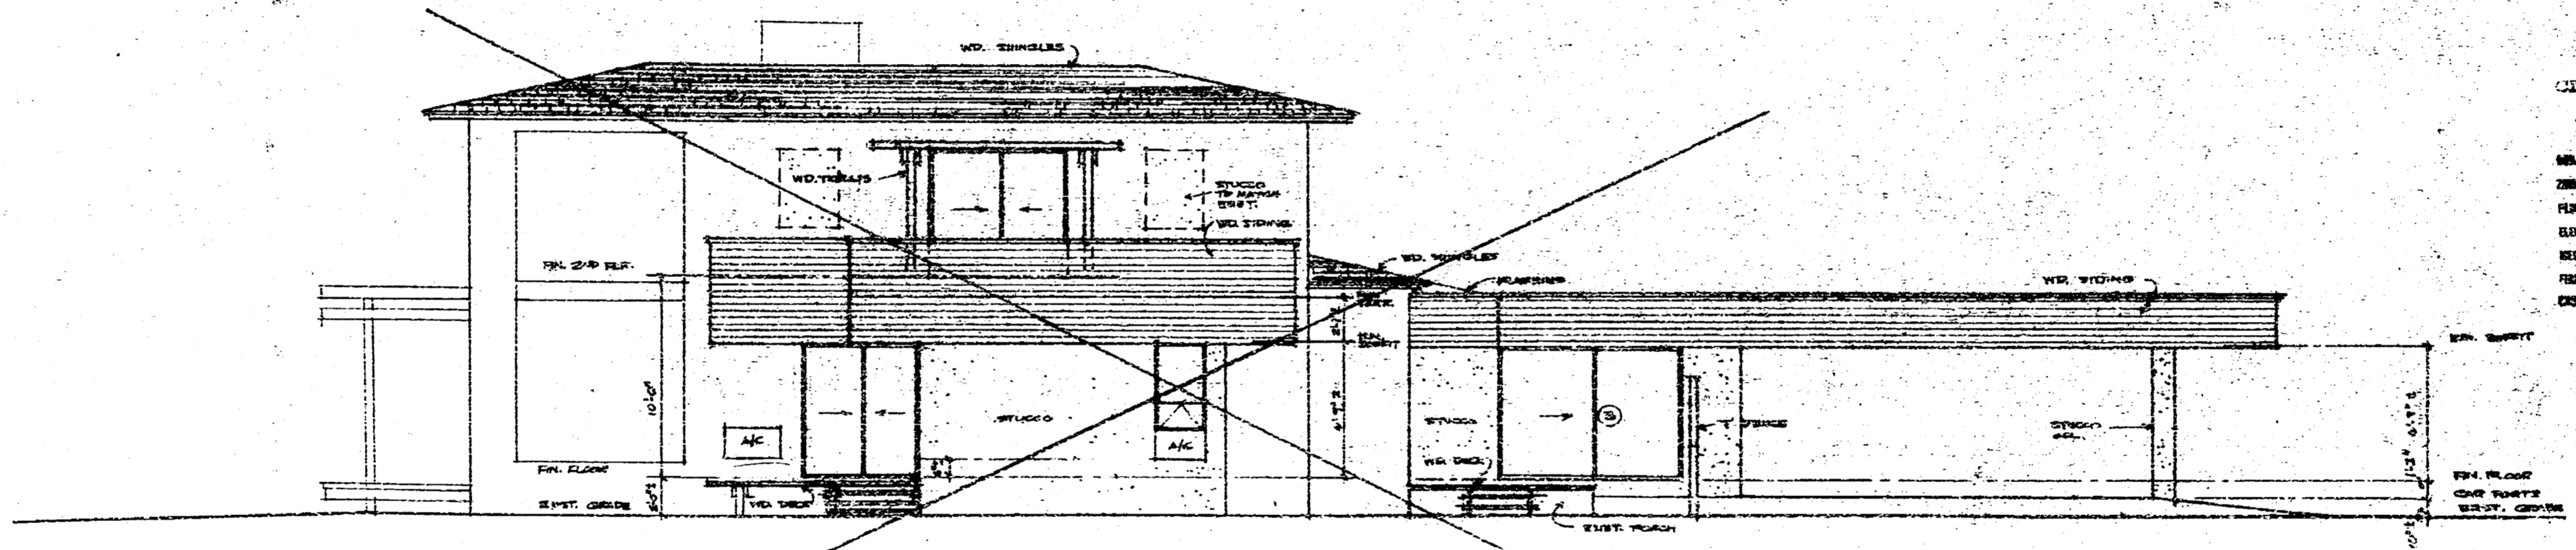

SOUTH ELEVATION 1/4" = 1'-0"

CITY OF MIAMI BEACH
APPROVED
 ORDER NO. P 8-28-78
 ZONING BY 0294178
 ELECTRICAL BY 9-8-78
 MECHANICAL BY 9-8-78
 FIRE PREVENTION
 COMMENTS

OFFICE COPY


DATE _____
 DRAWN BY 5-26-78
 REVISIONS _____

TERMIN RESIDENCE REMODELING
 424 W. DILIDO DR. MIAMI BEACH FLA.

STANLEY H. GREENE
 ARCHITECT PLANNER
 1400 BRISBANE AVENUE MIAMI BEACH FLORIDA 33151

MASTER PLAN
 PLANNED 7/2/78


89 690

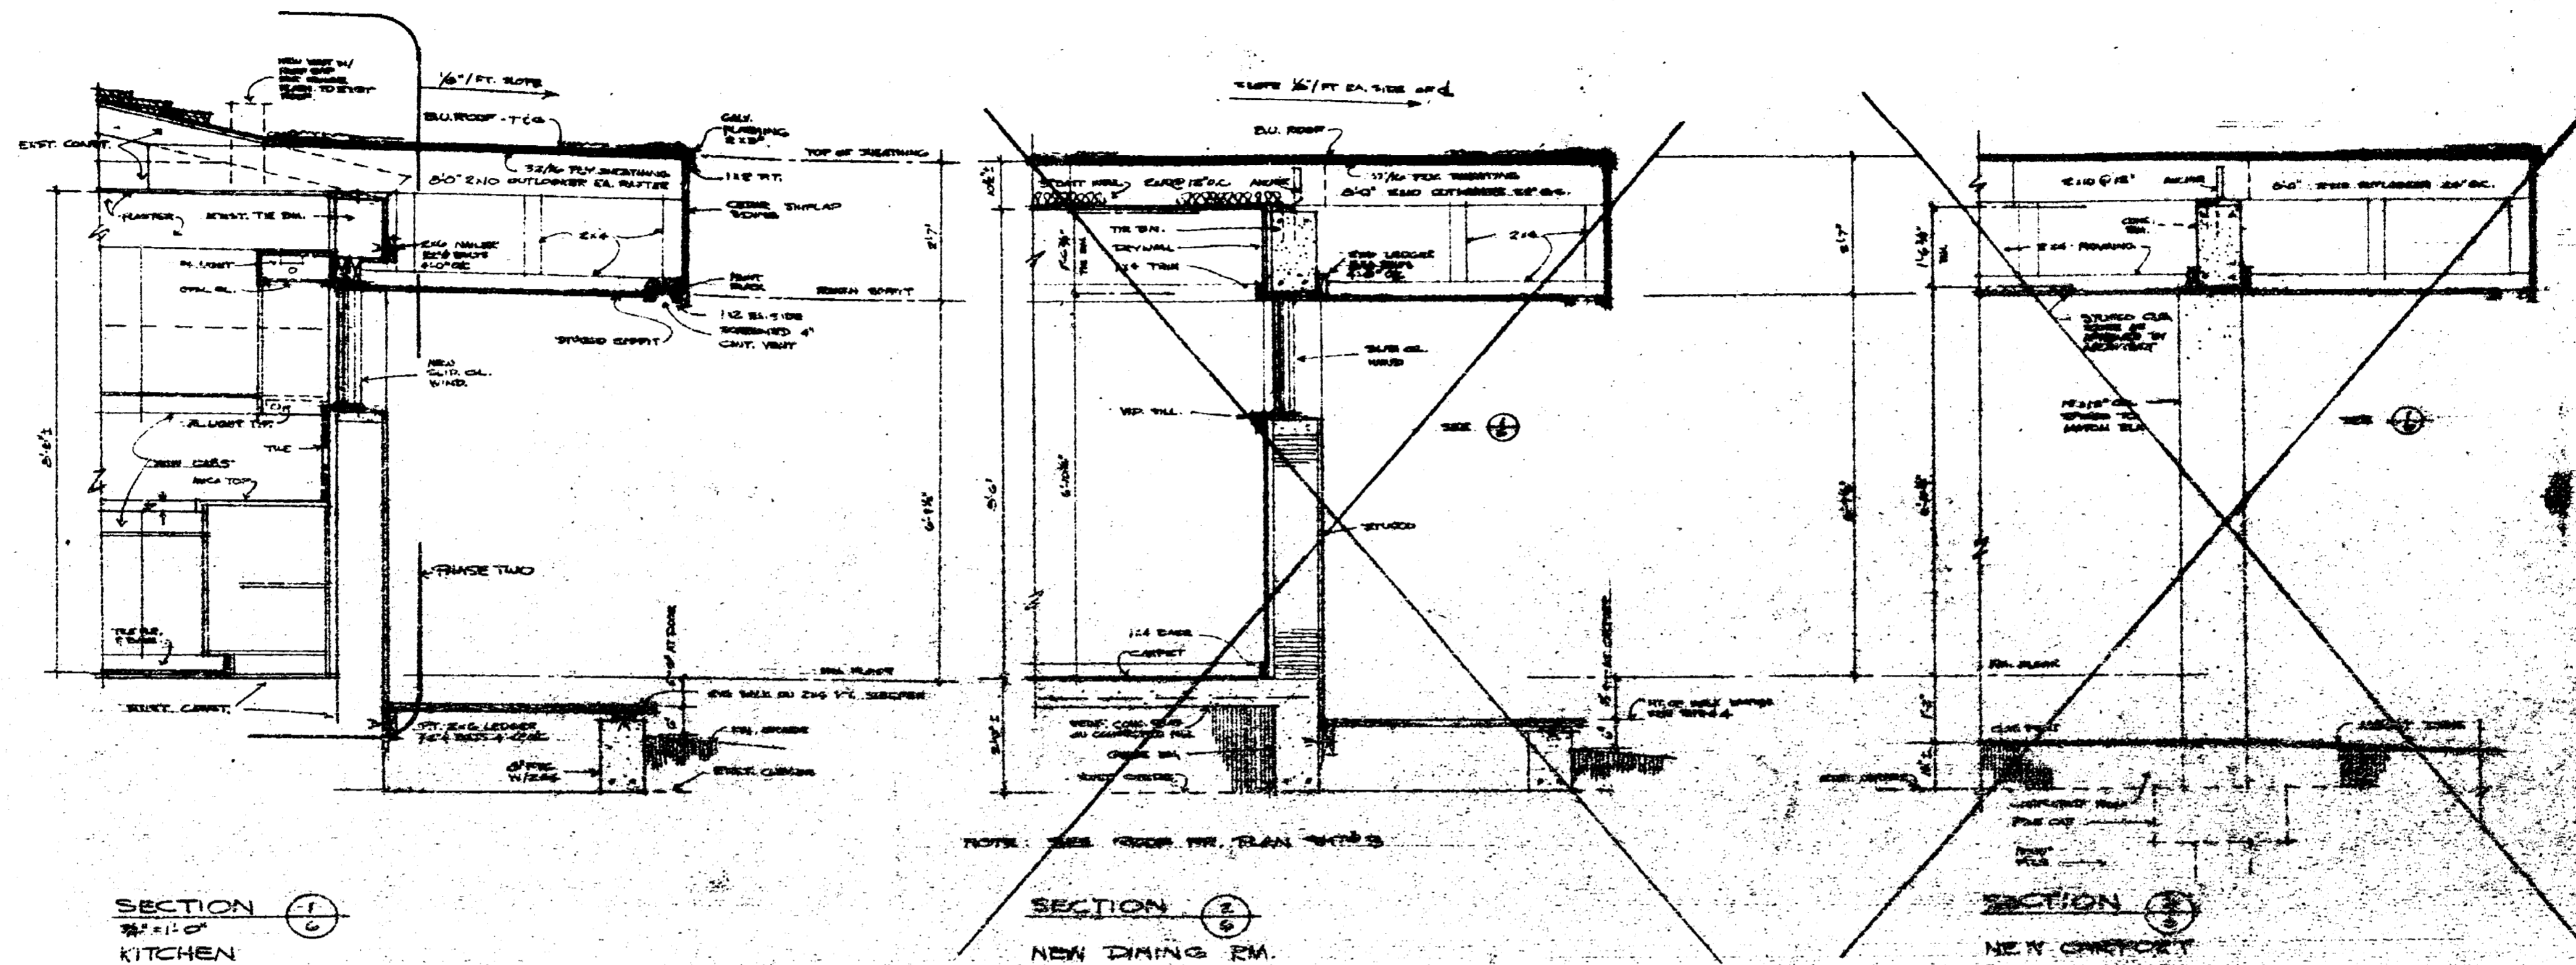

SECTION 1
KITCHEN

SECTION 2
NEW DINING RM.

SECTION 3
NEW CHIMNEY

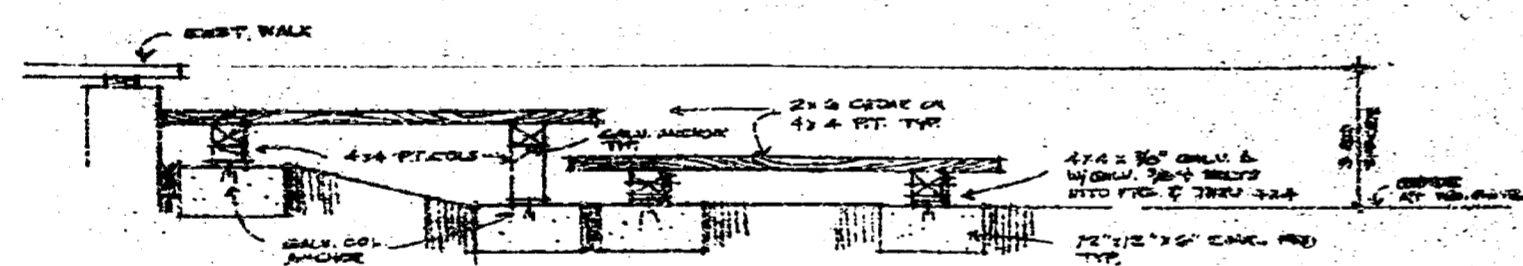

DECK AT ENTRY

FINISH SCHEDULE

ROOM	FLOOR	BASE	WALLS	CEILING	REMARKS
ENTRY	TILE 12\"/>				
HALL	UPPER LAMINATE	1/2\"/>			
BEDROOM	TILE 12\"/>				
UTILITY	1/2\"/>				
KITCHEN	1/2\"/>				
LIVING	CARPET	1/2\"/>			
BATH	TILE 12\"/>				
DINING	TILE 12\"/>				

TILE A
PERMANENT TERRA COTTA
TILE B
PERMANENT TERRA COTTA
TILE C
PERMANENT TERRA FLAME TEXAS

CITY OF MIAMI BEACH
APPROVED
[Signature]
[Signature]
[Signature]



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DATE 5-22-76
DRAWN BY
REVISIONS

TERMIN RESIDENCE REMODELING
424 W. DILIDO DR. MIAMI BEACH FLA.

STANLEY H. GREENE
ARCHITECT
PLANNING


89 690

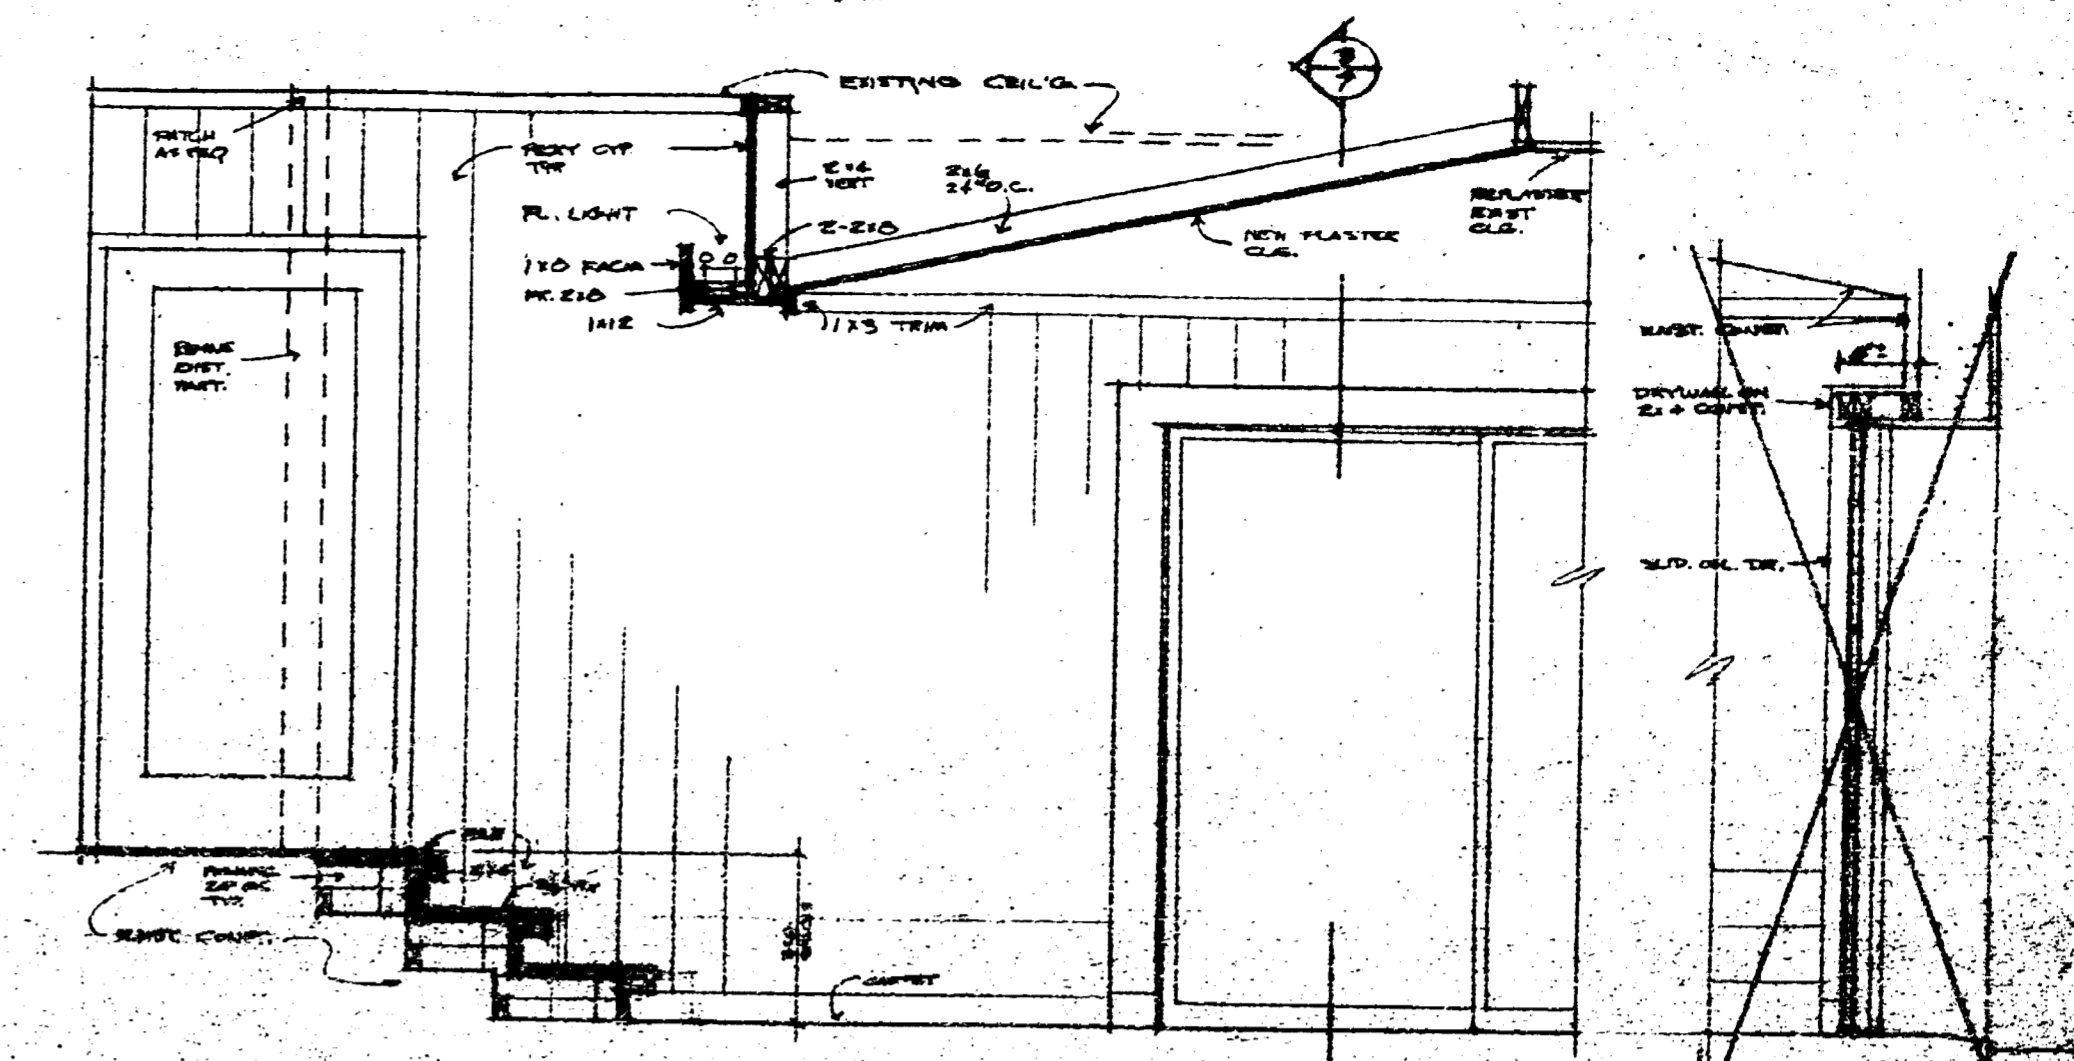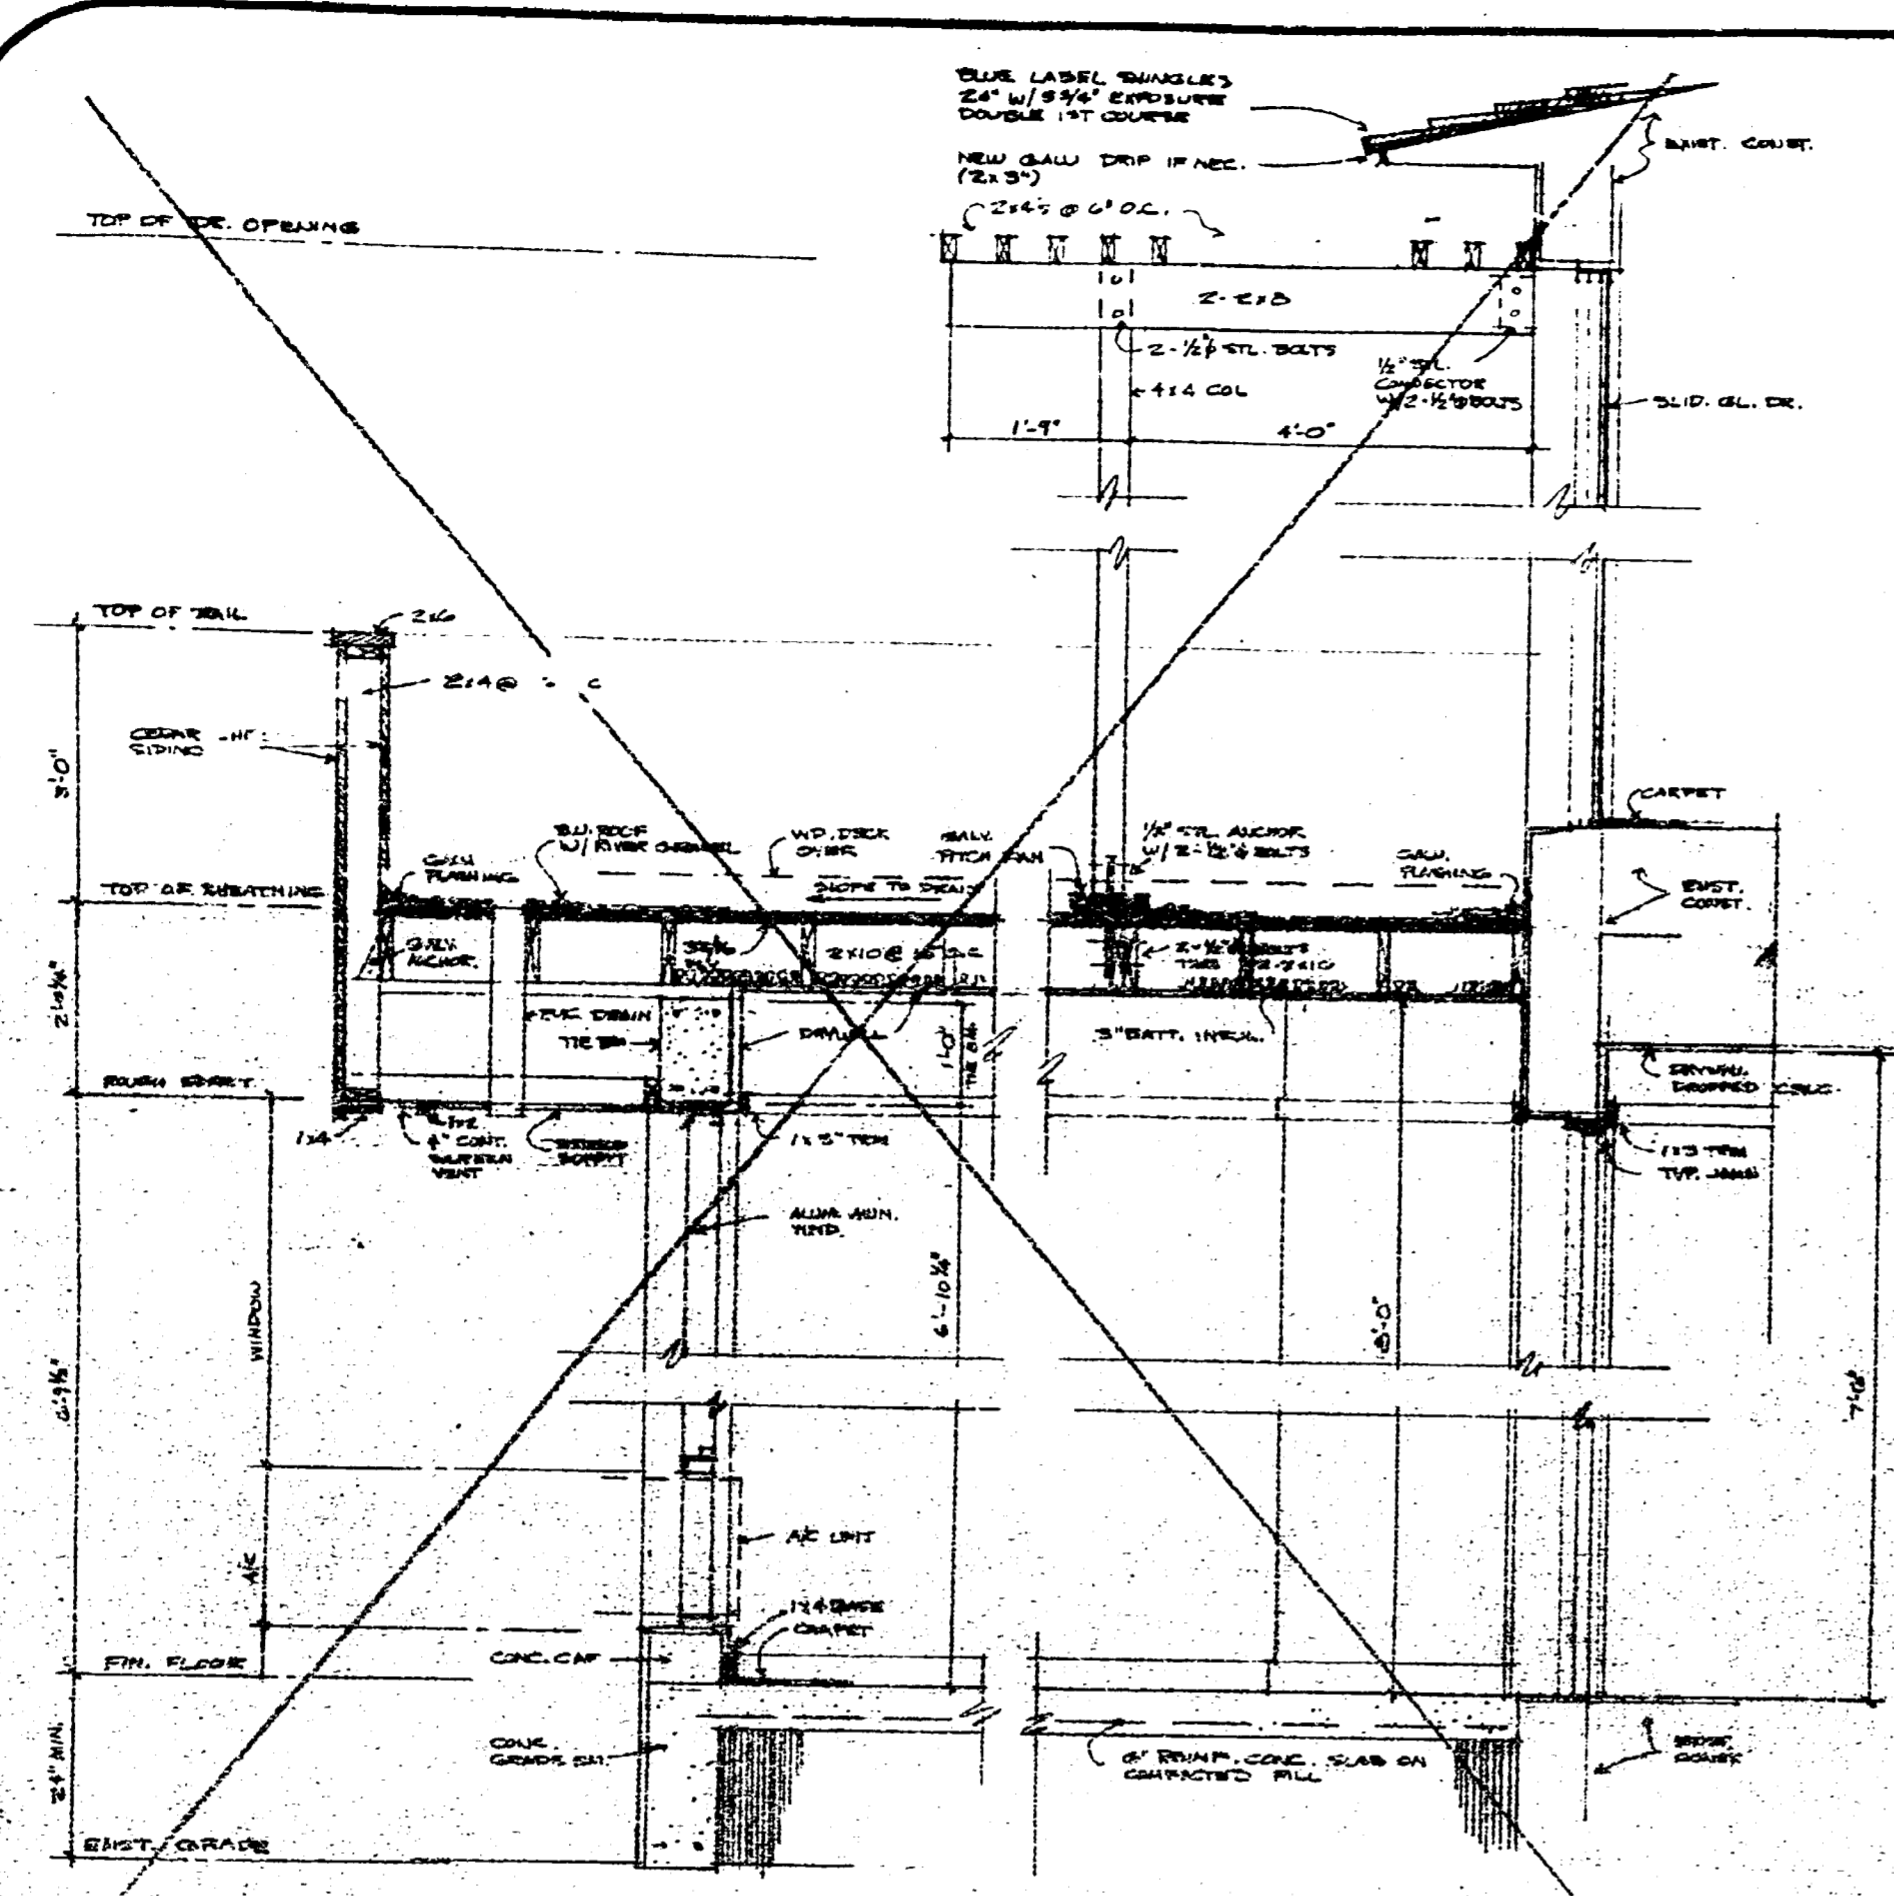

SECTION 1
3/4" = 1'-0"

SECTION 6
3/4" = 1'-0"

SECTION 7
3/4" = 1'-0"

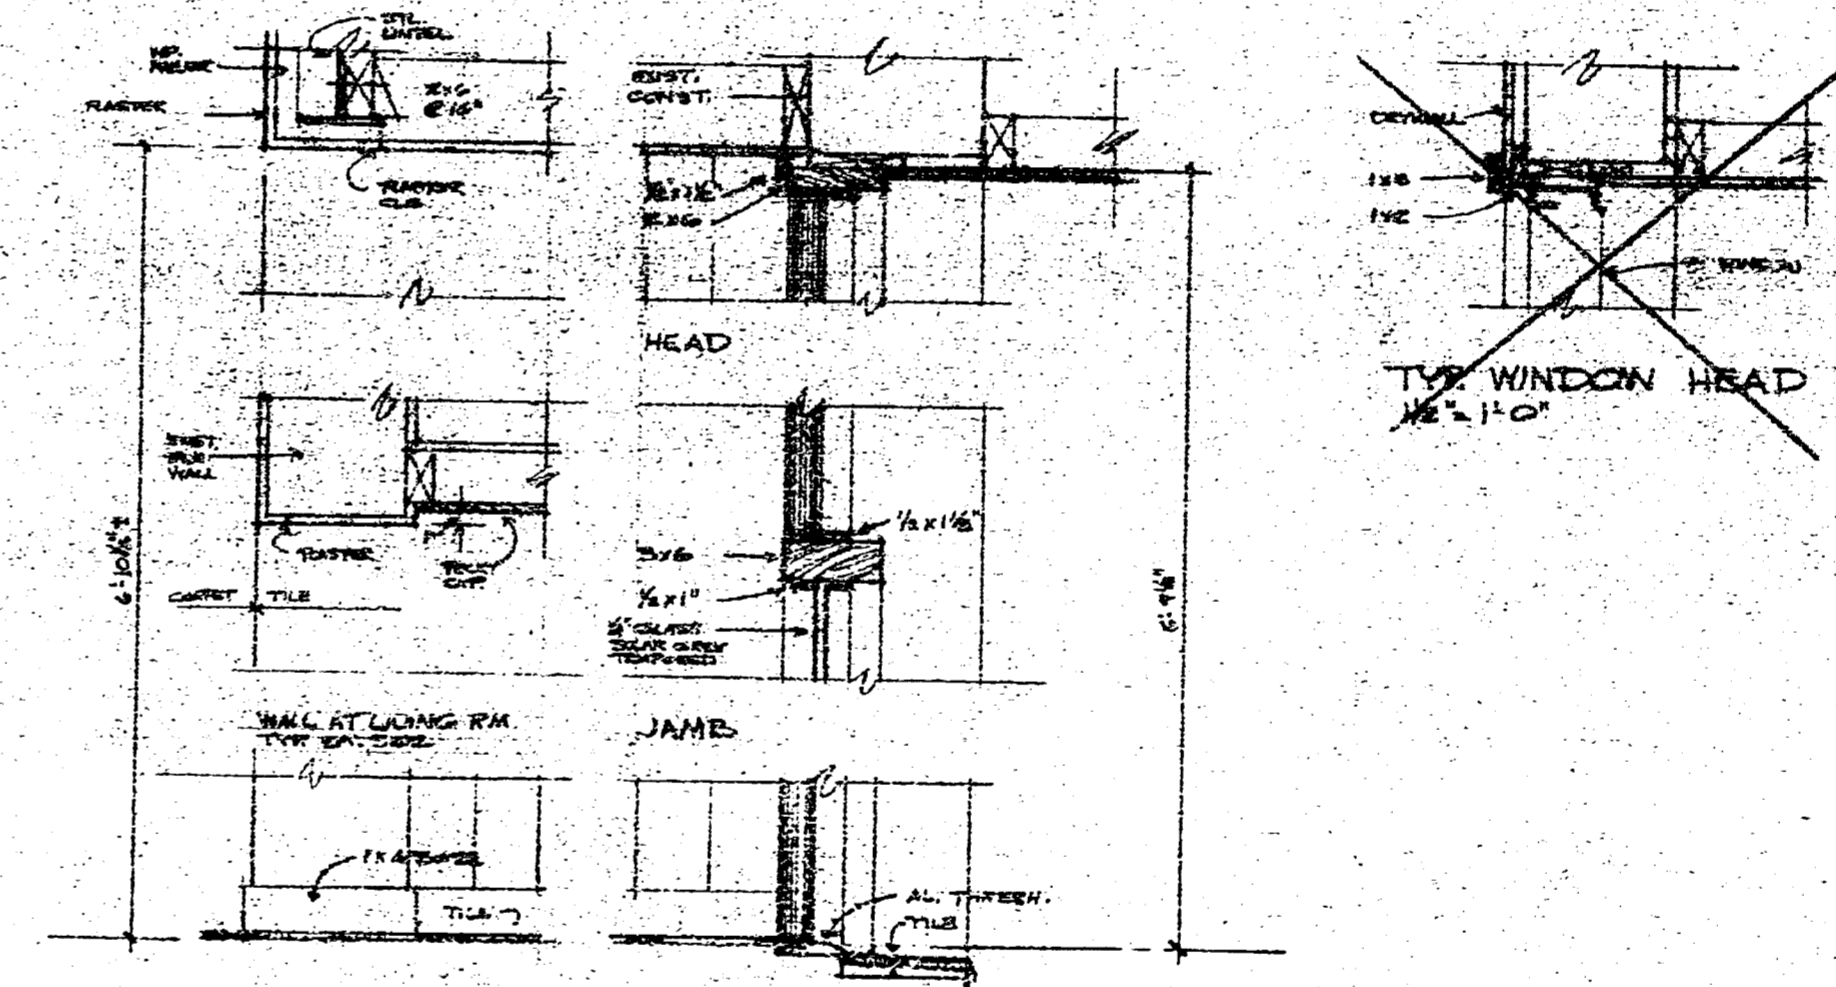

SECTION 8
3/4" = 1'-0"

CITY OF MIAMI BEACH
APPROVED
ENGINEER
PLUMBER
ELECTRICIAN
MECHANICAL
FIRE PREVENTION
ENGINEERING

OFFICE COPY

DATE 2-2-76
DRAWN BY S-22-75
REVISIONS

TERMIN RESIDENCE REMODELING
424 W. DILIDO DR. MIAMI BEACH FLA.

STANLEY H. GREENE
ARCHITECT PLANNER
1400 BRIGGELL AVENUE S.W. MIAMI, FLORIDA 33136

MASTER PLAN
PHASE TWO
6 OF 6

89 6 90

PUBLIC UTILITIES DEPARTMENT - - - CONSTRUCTION PERMITS

TO: PUBLIC UTILITIES DEPARTMENT - ENGINEERING DIVISION

LEGAL DESCRIPTION: Lots 19-20, block 2, Dillido Island

LEGAL ADDRESS: 424 West Dillido Drive

TYPE OF BUILDING: Interior remodeling to residence

A plan for this building has been submitted to this Division. Please list any corrections below and return to Construction Services.

GARBAGE FACILITIES: to use existing facilities

SANITARY SEWER: to use existing facilities - see Note #1

WATER: to use existing facilities

DRAINAGE: as shown

GRADES: as shown

ENCROACHMENTS: Lot size incorrectly shown - Lot has rounded N.E. Corner

EASEMENTS:

Public Utilities Department Permits required for work done on City Property

COMMENTS: Complete sections of sidewalk to be removed and replaced where necessary.

NOTE #1 : Garbage disposal unit not permitted.
 Skip Sault & Son Inc.
 Aug 26/64

OK for permit subject to above corrections
 Sent to Construction Services 9/14/64 F.R. Ayman
 (date) Frank Ayman /ENGINEERING DIVISION

RECEIVED
 DATE: 9-14-64 10:58 SEP 10 PM 12:14
 CITY OF MIAMI BEACH CODE ENFORCEMENT DEPARTMENT BUILDING INSPECTION DIV.
 CONSTRUCTION SERVICES DIVISION
 1700 CONVENTION CENTER DRIVE
 ATT: BUILDING OFFICIAL

OWNERS AFFIDAVIT

I, LEON TERMINO, INC. certify that I am the owner of the property described as:

Address: 424 WEST DILLIDO DRIVE
 Legal Description: lots 19 & 20 block 2
 subdivision

I authorize Skip Sault & Son Inc. as my agent to obtain a building permit for the following work:

Interior Remodeling

OWNER: Leon Termino, Inc.
(Julius Leon Termino)


STATE OF FLORIDA
 COUNTY OF DADE

Before me personally appeared LEON TERMINO, INC. who by me being duly sworn upon oath says that the statements set forth above are true and correct. Subscribed and sworn to before me this 14th day of September 1964

James G. Galt Notary Public For Dade County, State of FLORIDA

NOTARY PUBLIC STATE OF FLORIDA AT LARGE
 AN EXPIRES ON SEPTEMBER 20, 1965
 EXPIRES ON SEPTEMBER 20, 1965

89 690


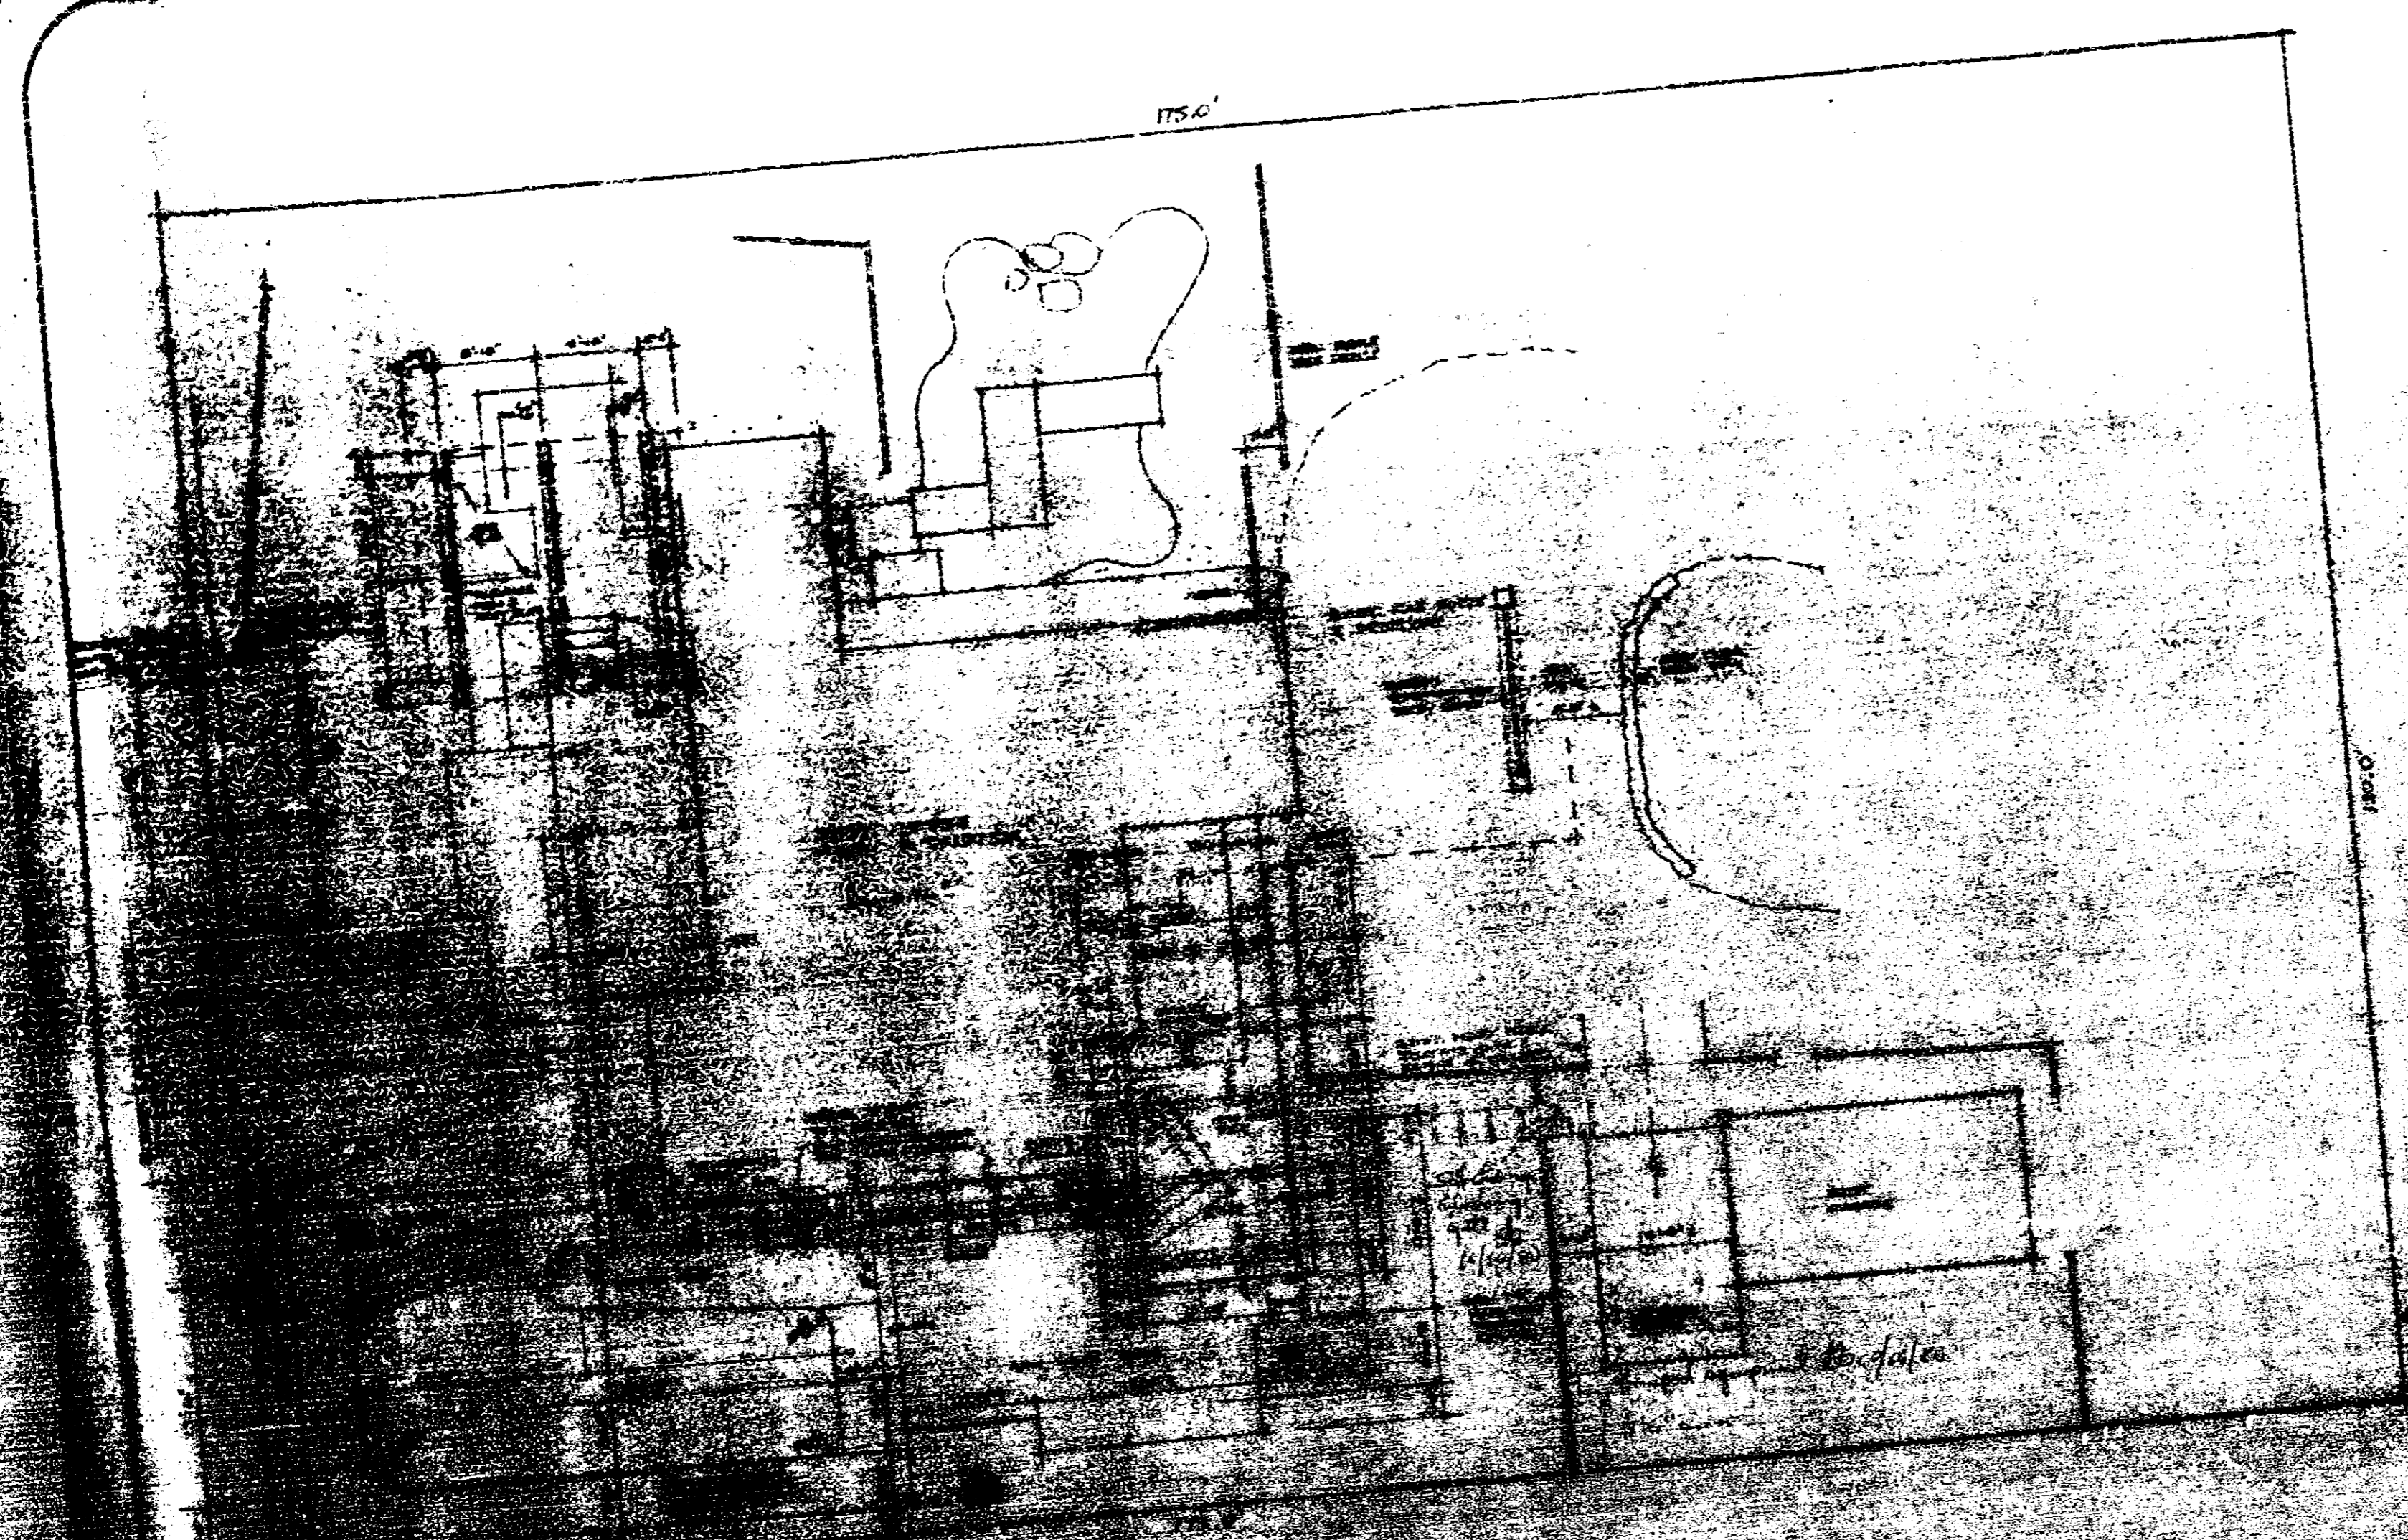


1750

GENERAL NOTES:
 CONTRACTOR SHALL VERIFY DIMENSIONS, DETAILS & ELEVATIONS
 ON SITE BEFORE PROCEEDING W/ CONSTRUCTION.
 CONC. - 3,000 PSI @ 28 DAYS
 LUMBER - 4x4'S USED AS BRG. & ALL WD. IN CONTACT W/ GROUND
 SHALL BE TREATED W/ PRESERVATIVE.
 TREATMENT: SOAK IN WOOD LIFE, RETEN'S GUT BRONZE
 FINISH W/ 2 COATS CABOTE'S WEATHERWOOD
 FASTENERS: USE ONLY GALV. NUTS
 POOL & POOL DECK: SEE STRUCT. DRAW.



















OFFICE COPY

90261

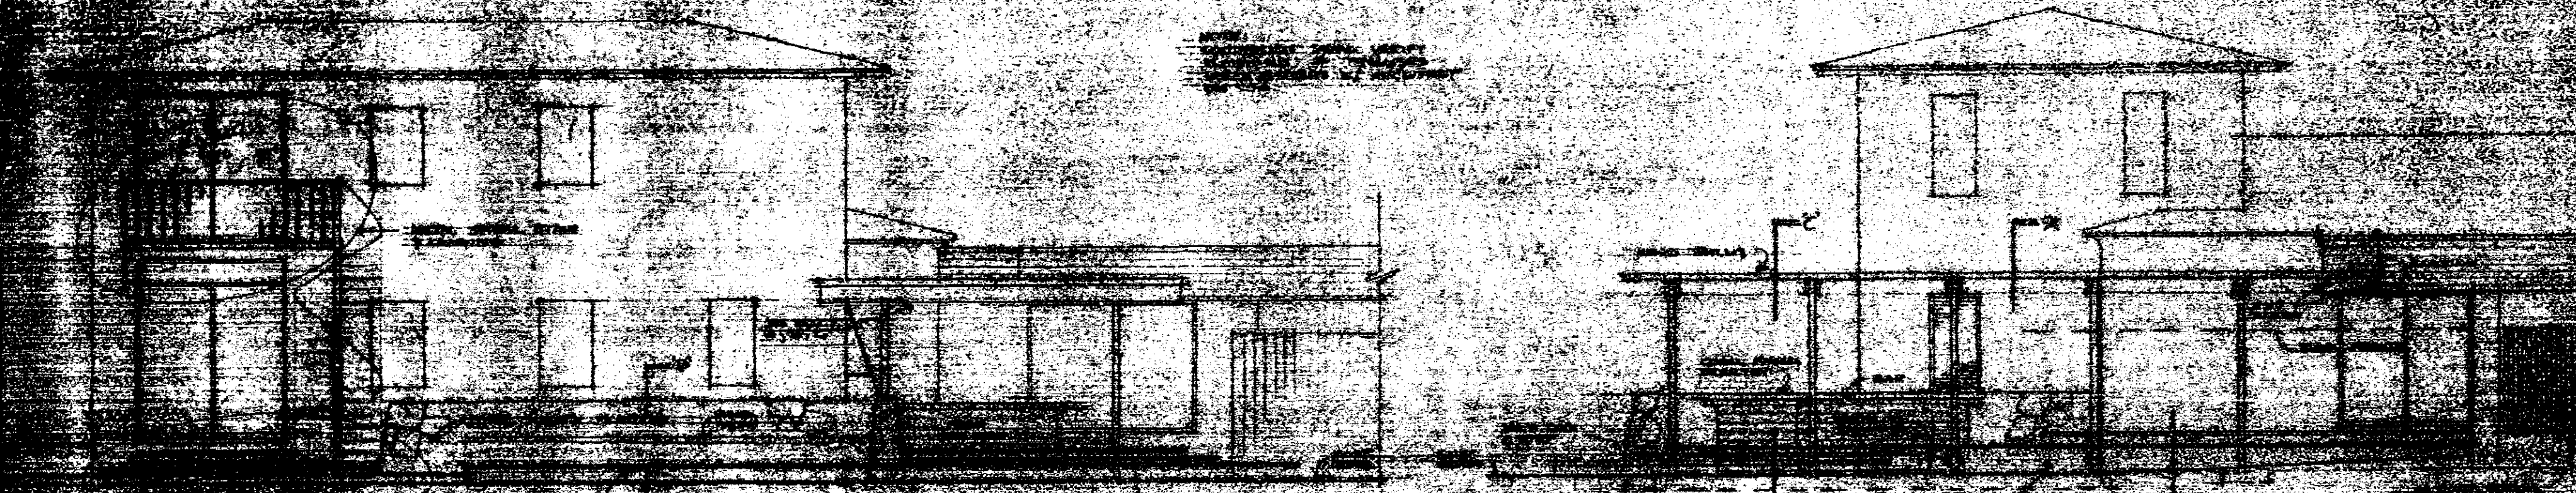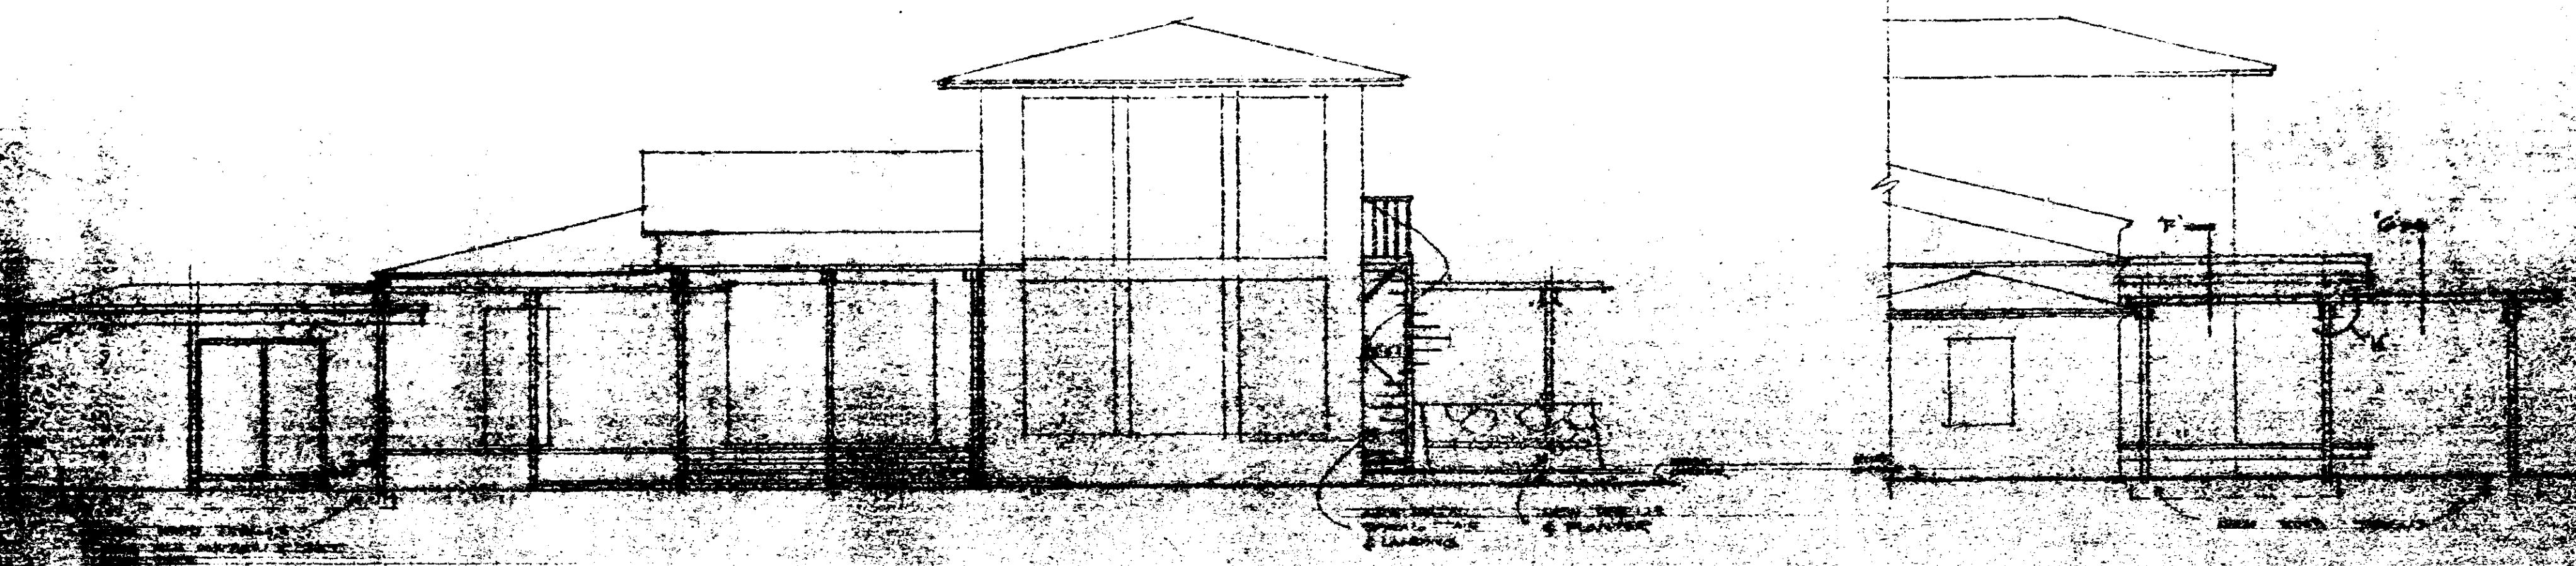

Architectural text and notes, including a stamp that reads "CITY OF MIAMI APPROVED".

90261

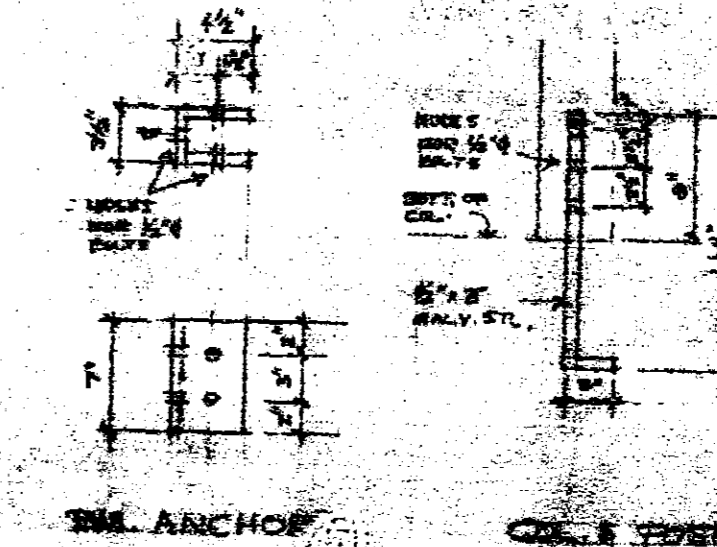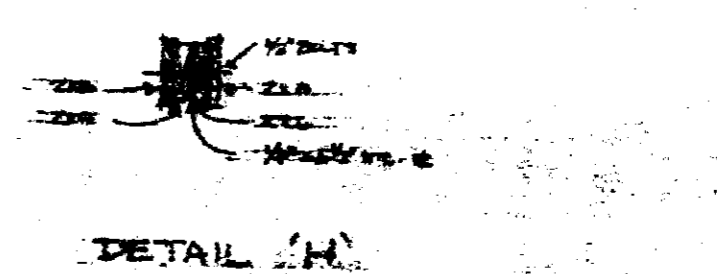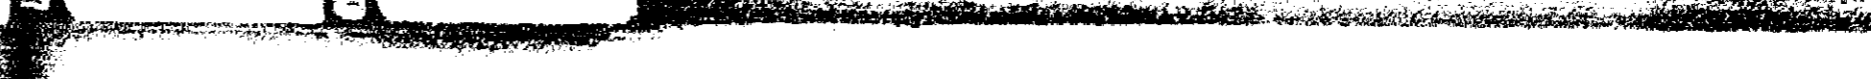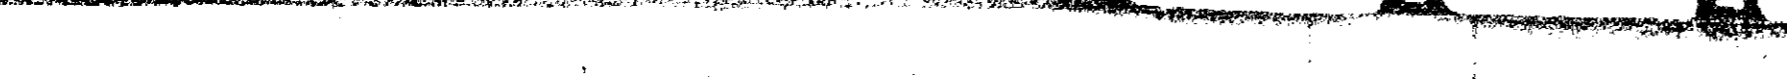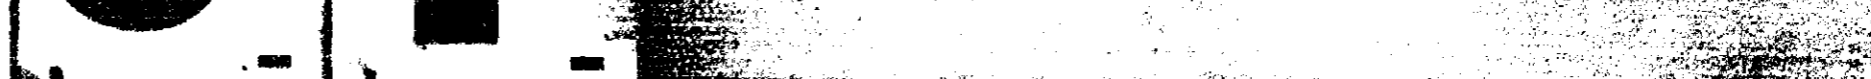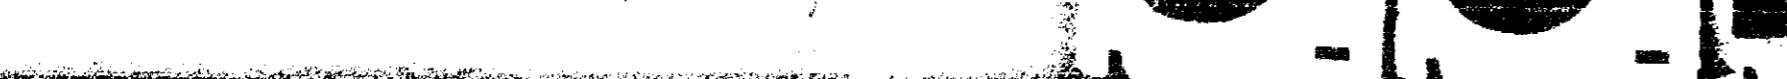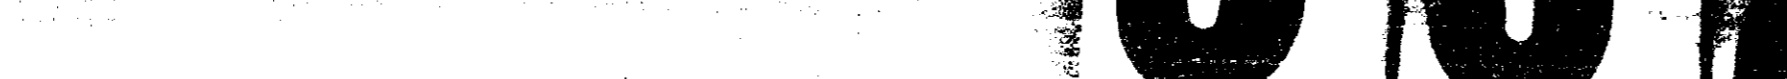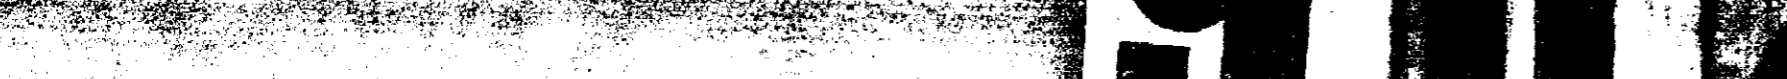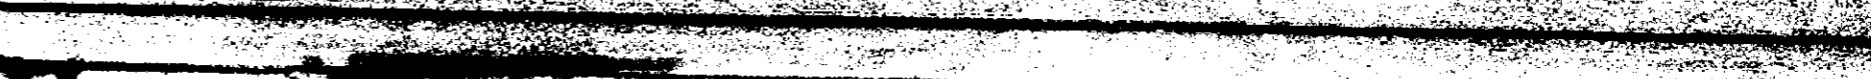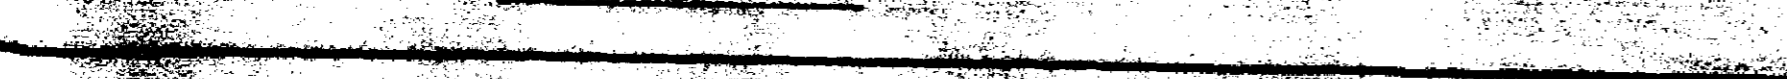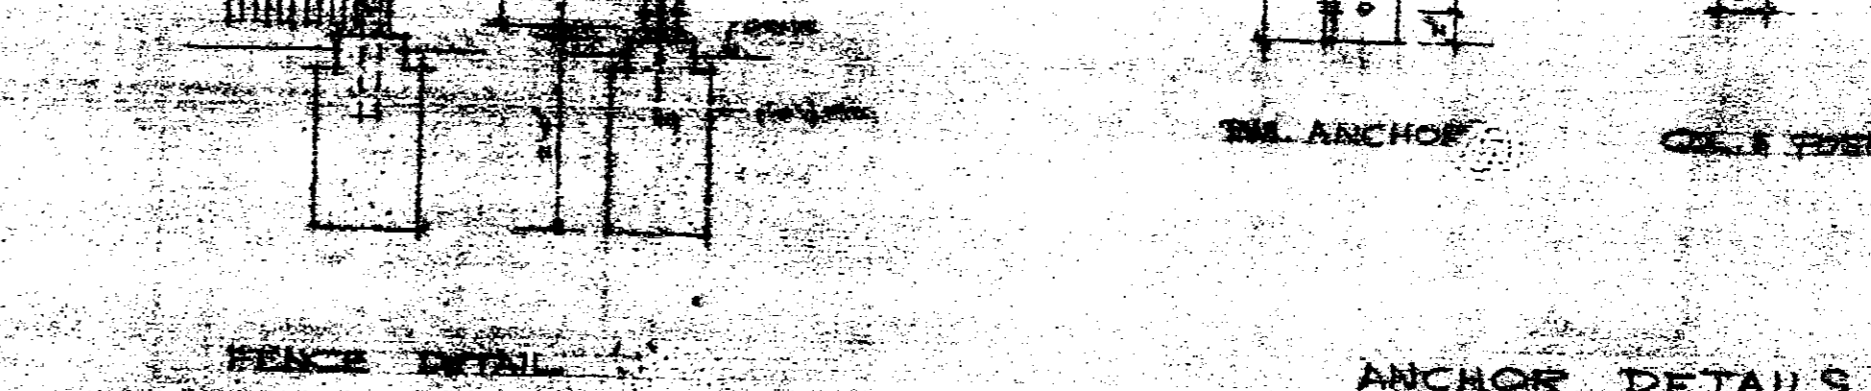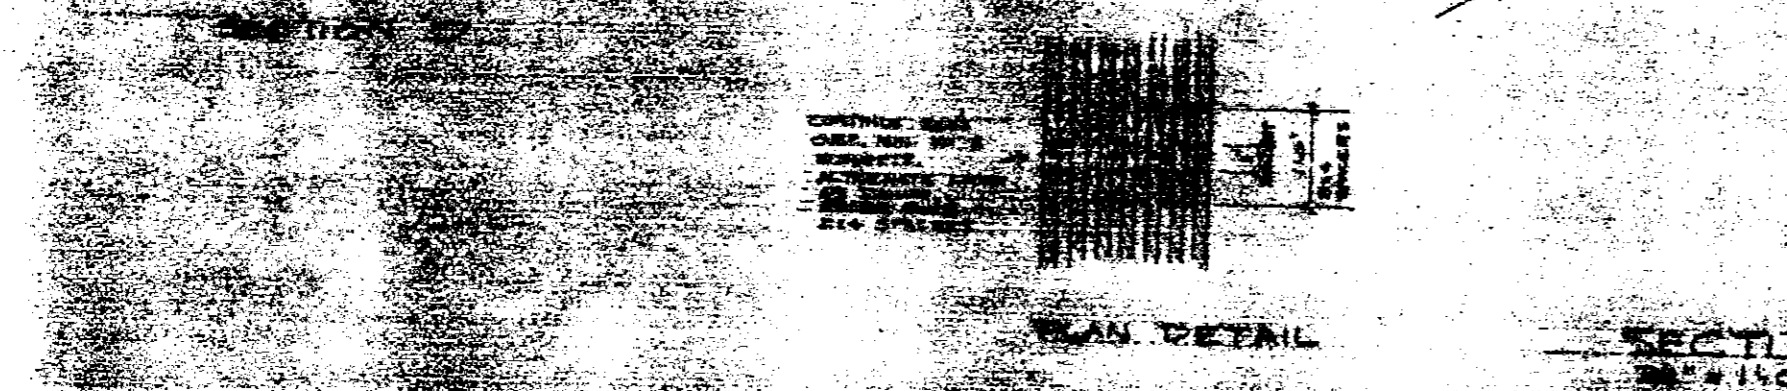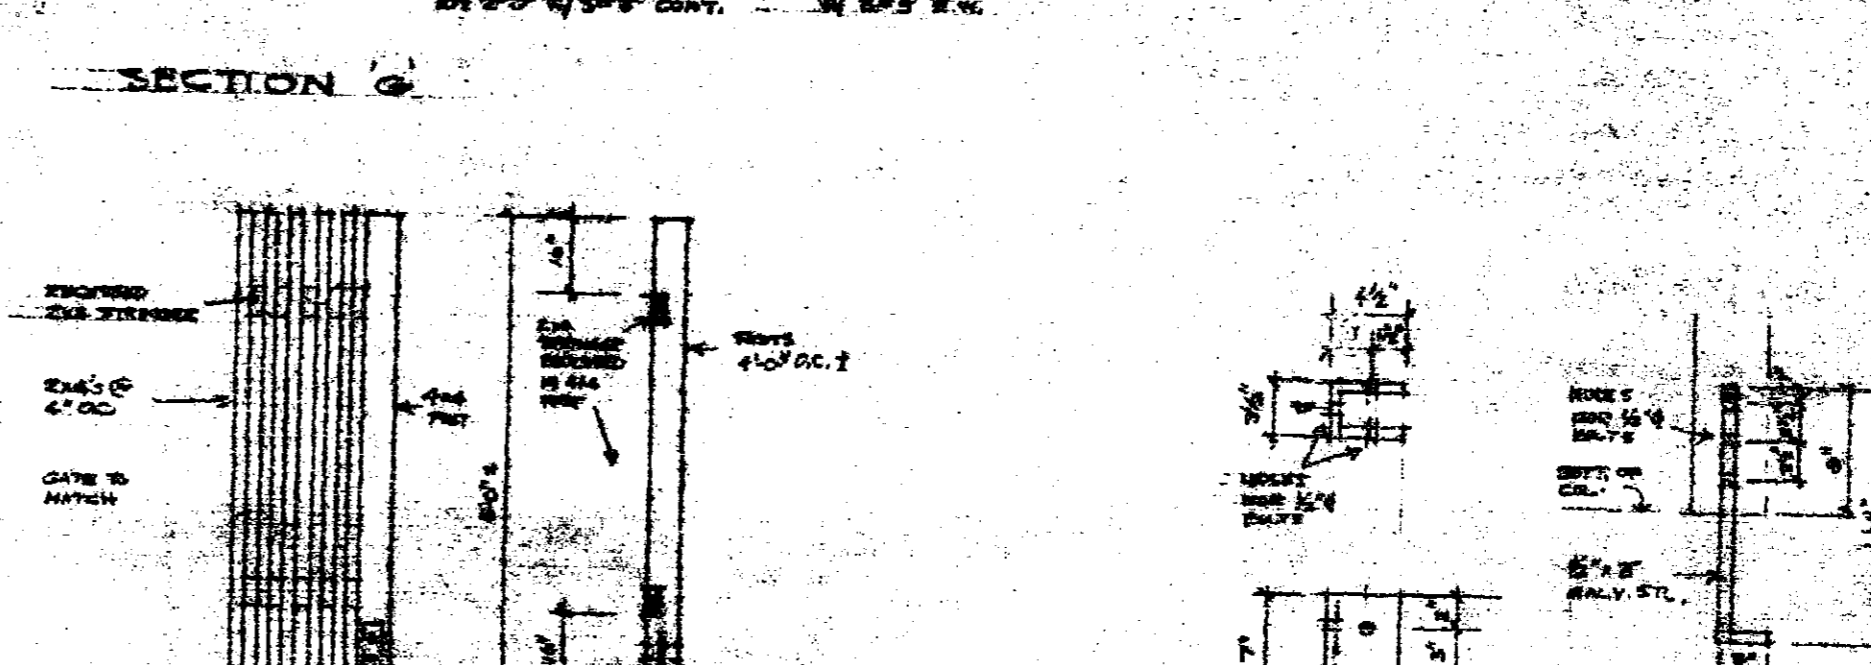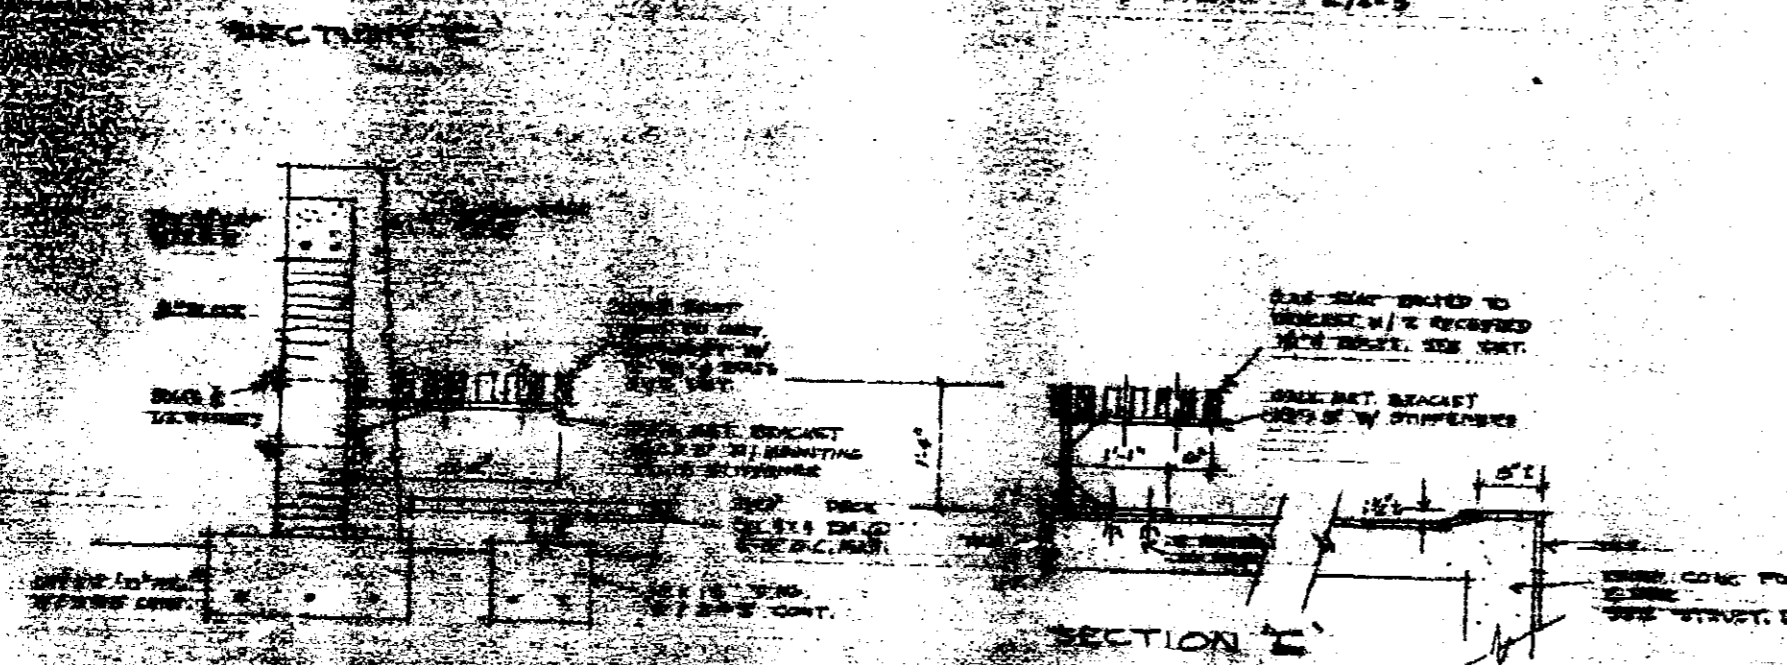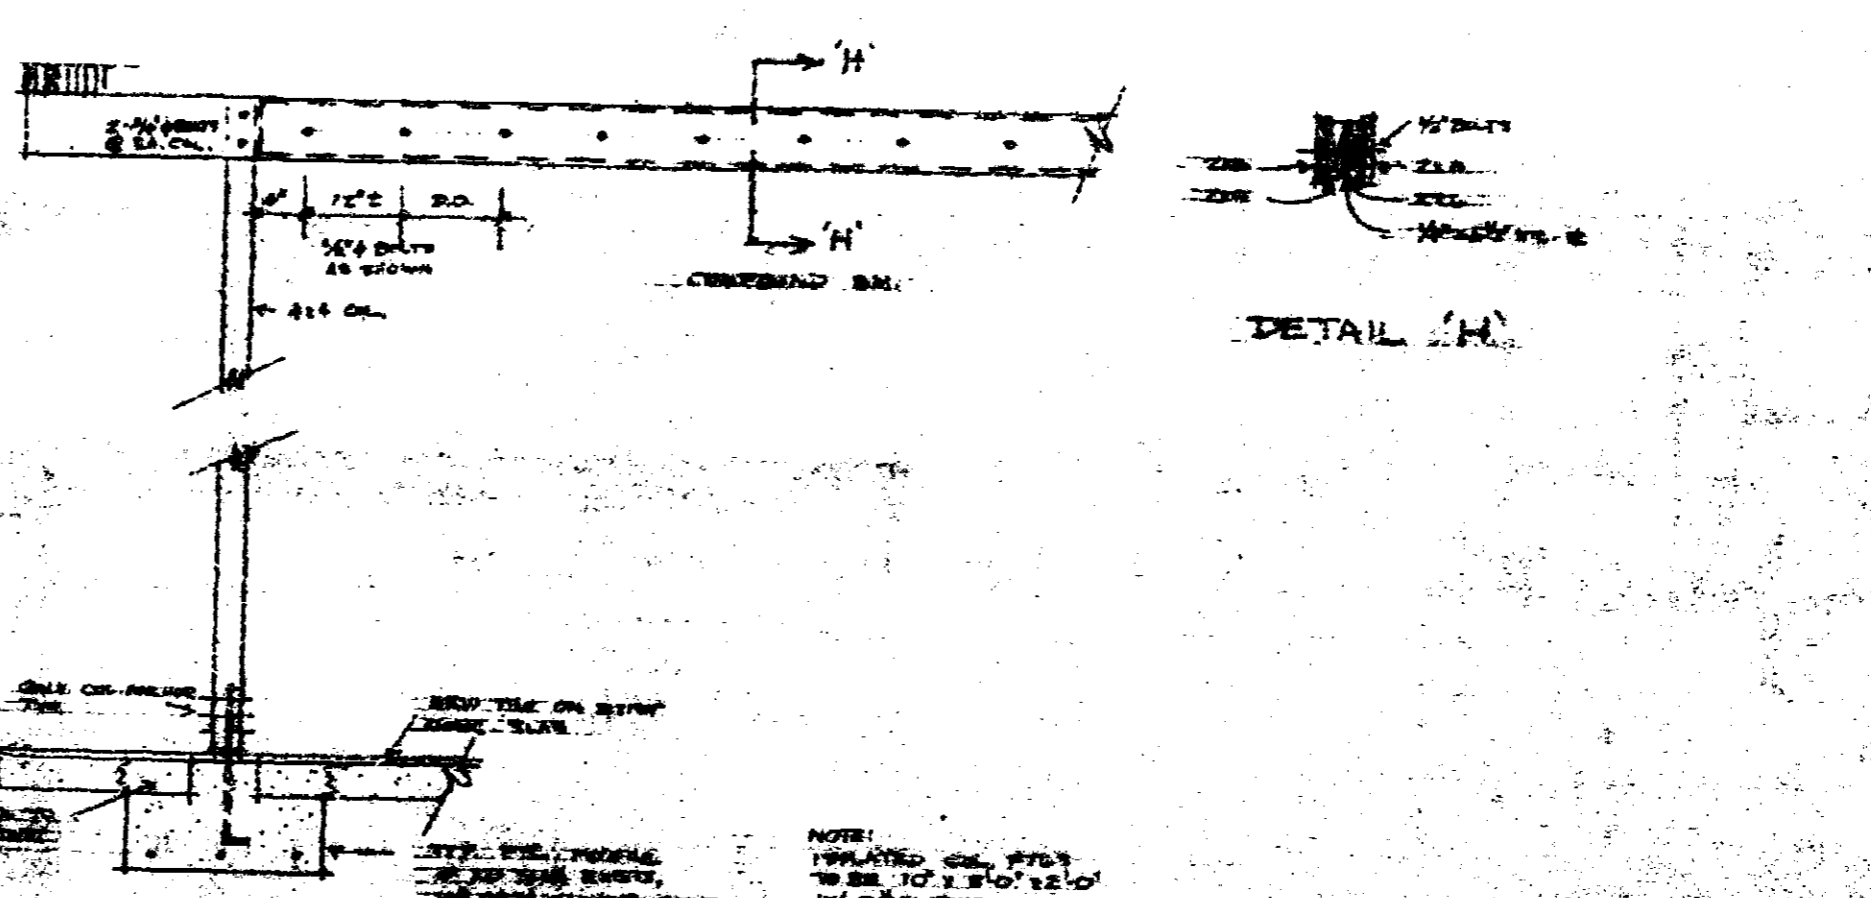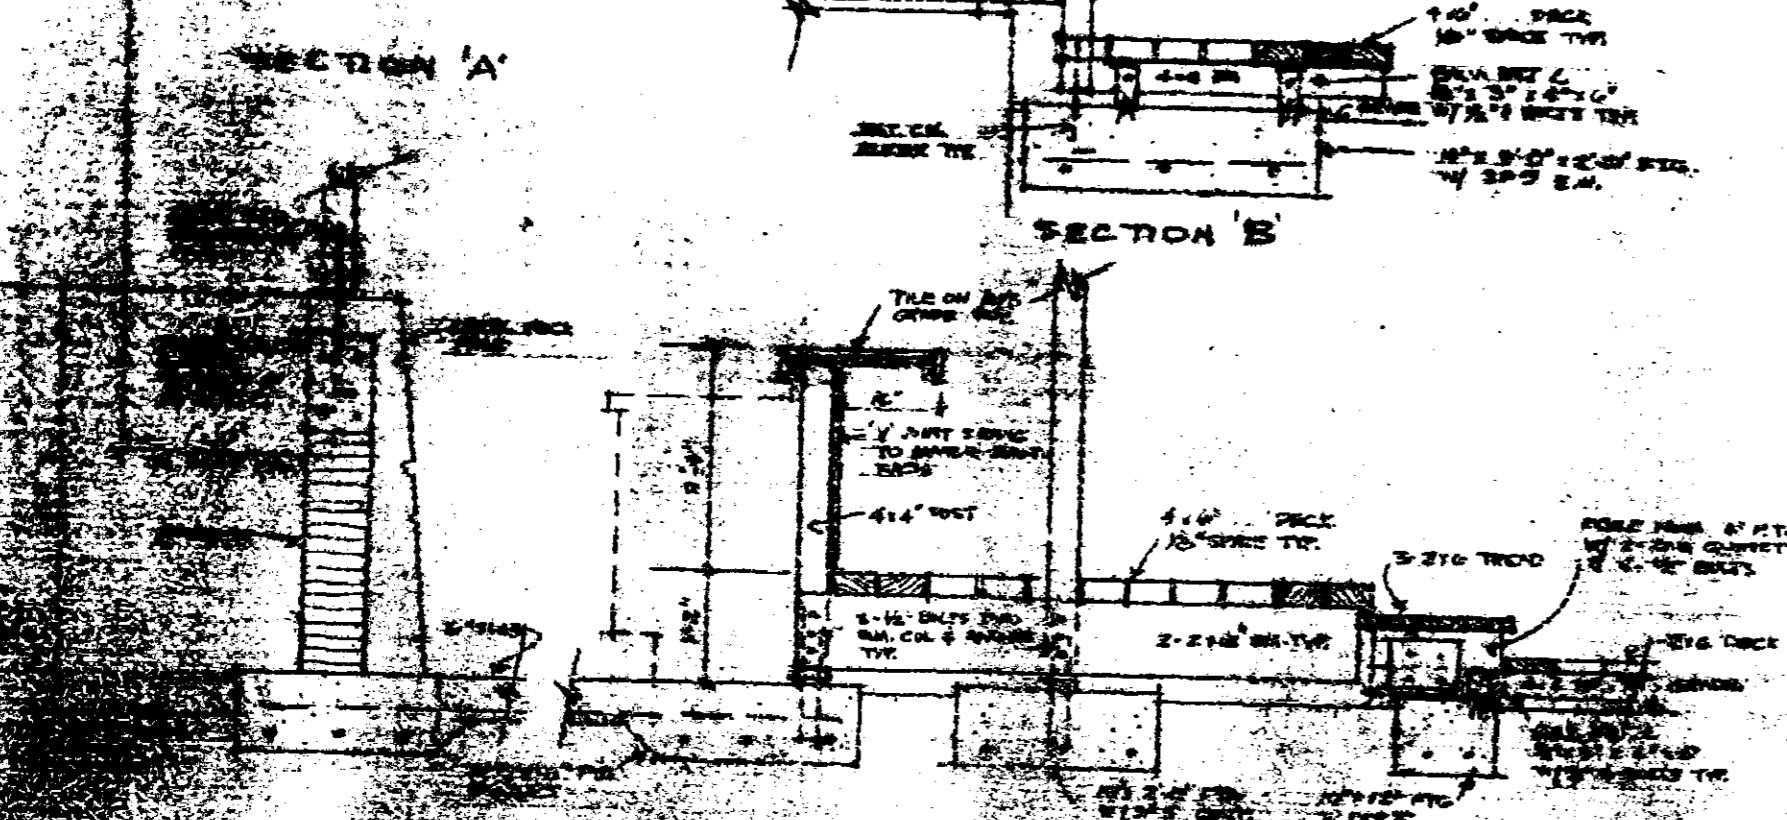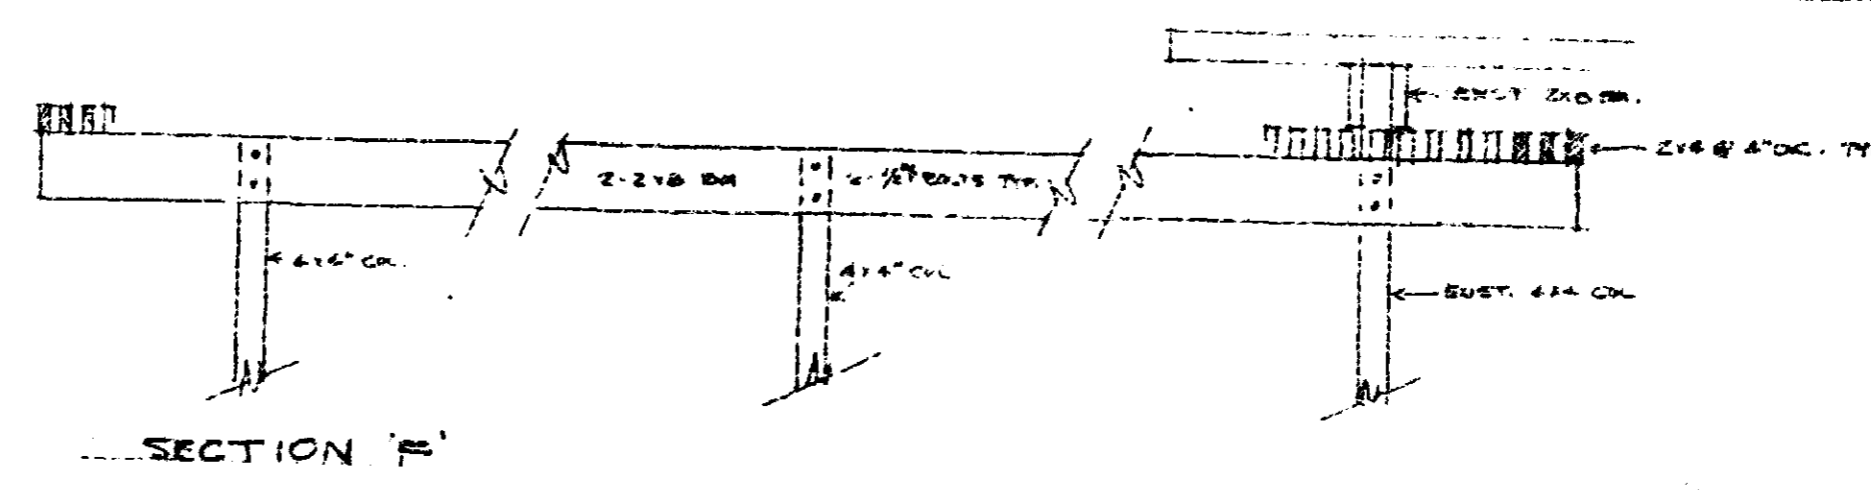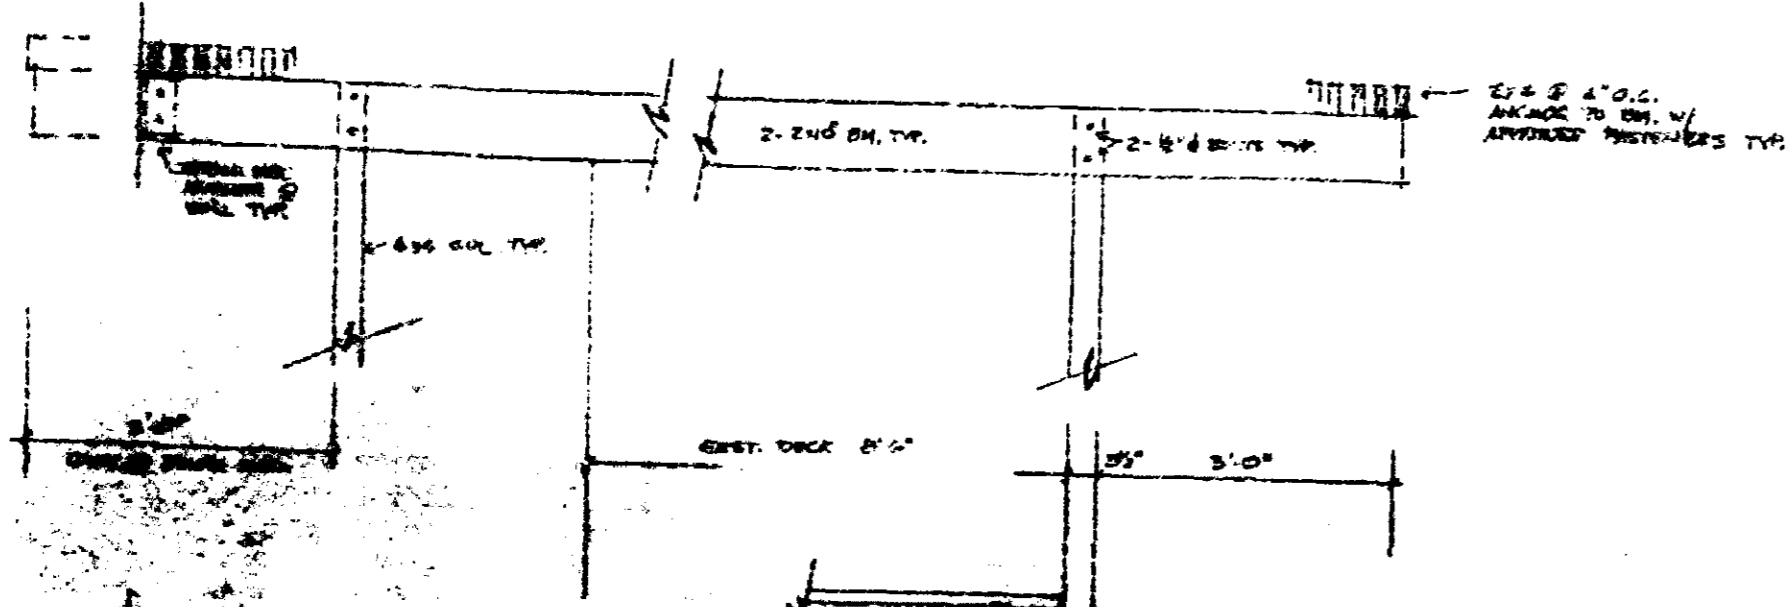

CITY OF MIAMI BEACH
APPROVED



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NO.	DATE	REVISIONS


POOL & DECK ADDITION
 FOR DR. & MRS. TERMAN
 MIAMI BEACH, FLORIDA

STANLEY H. DREING
 ARCHITECT
 1200 BIRCHWOOD AVENUE MIAMI, FLORIDA

90261

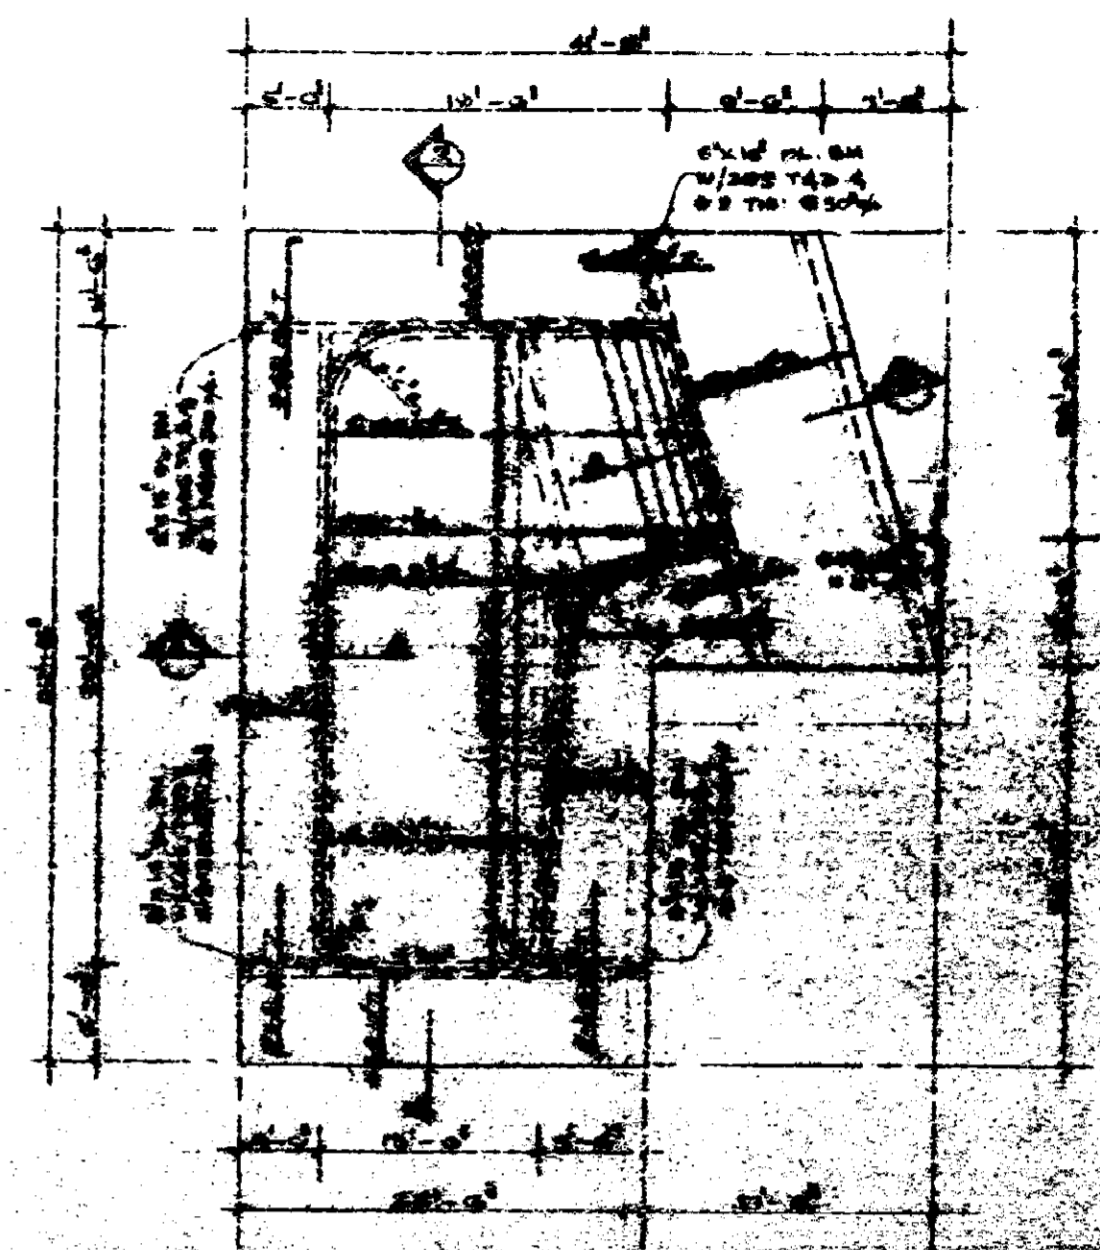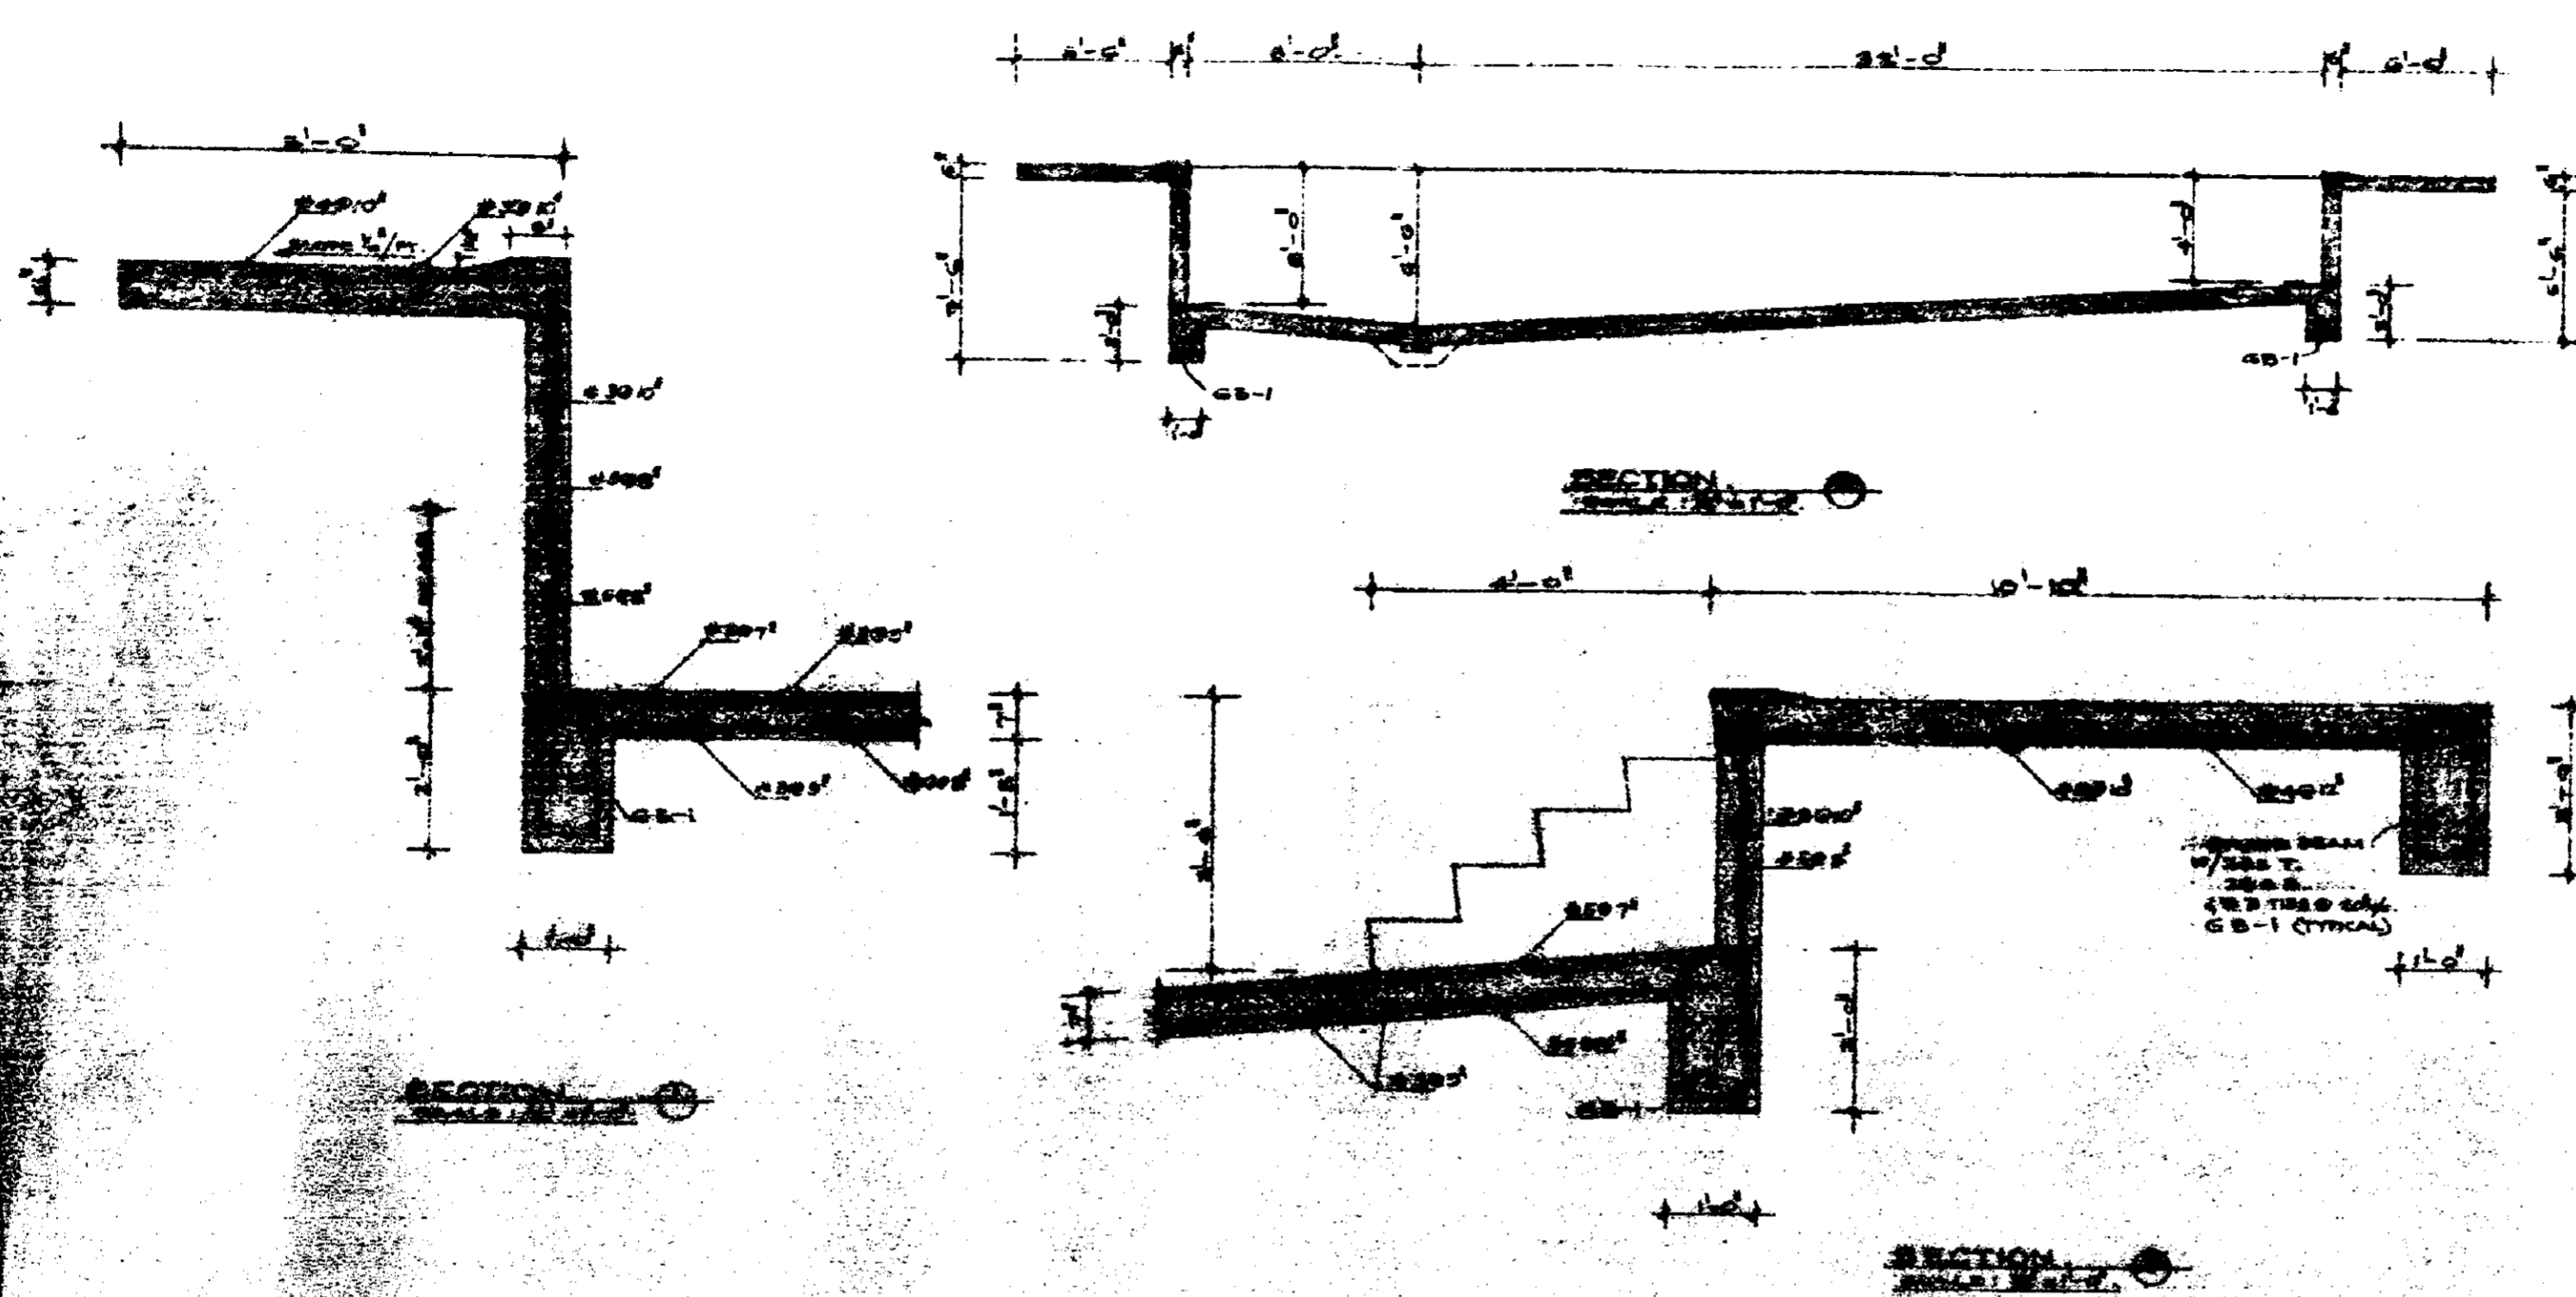

DECK AND ROCK PILING
SECTION 4


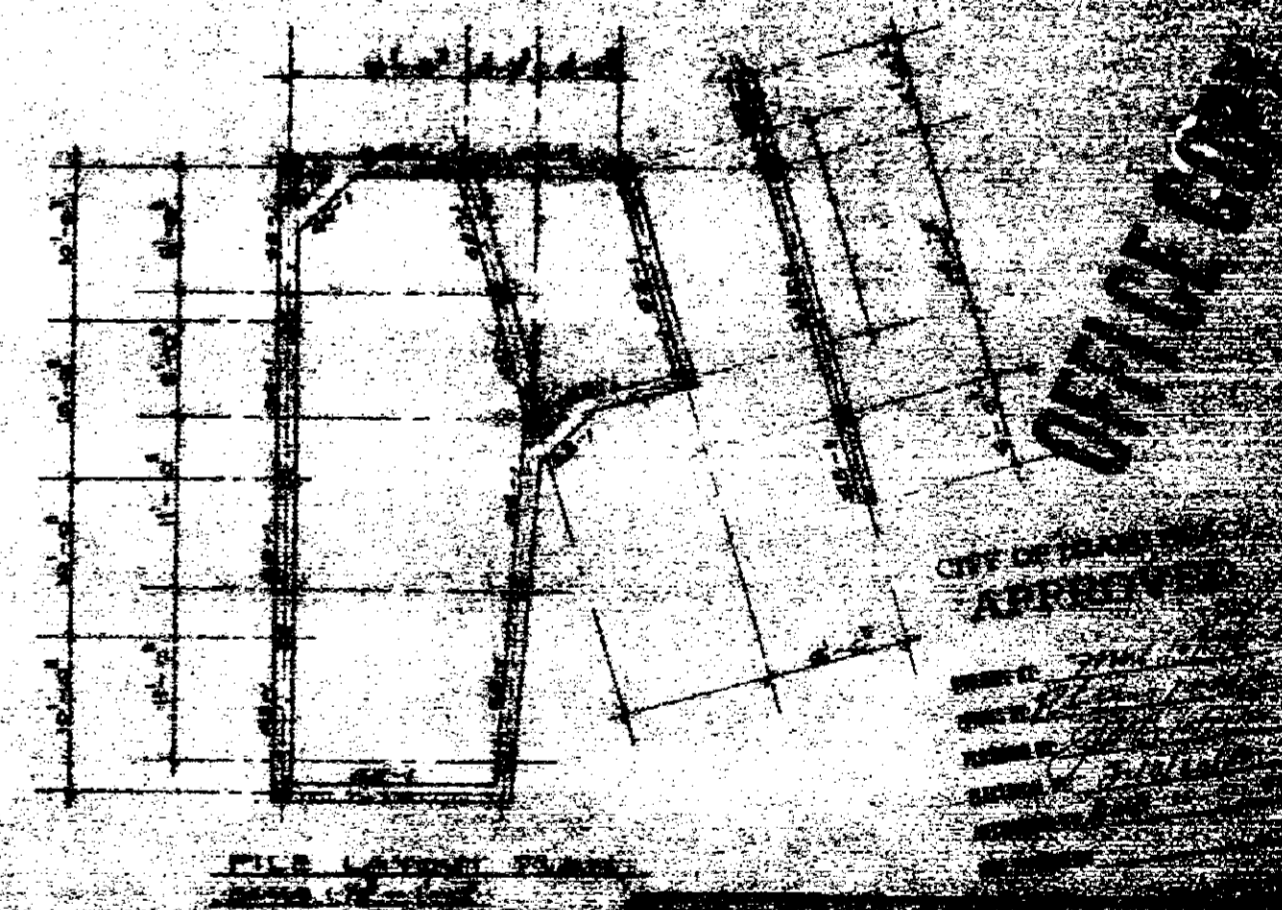


FILE LEGEND TABLE
SECTION 5

Richard J. [Signature]

OFFICE OF THE
CHIEF OF ENGINEERS
APPROVED

90261

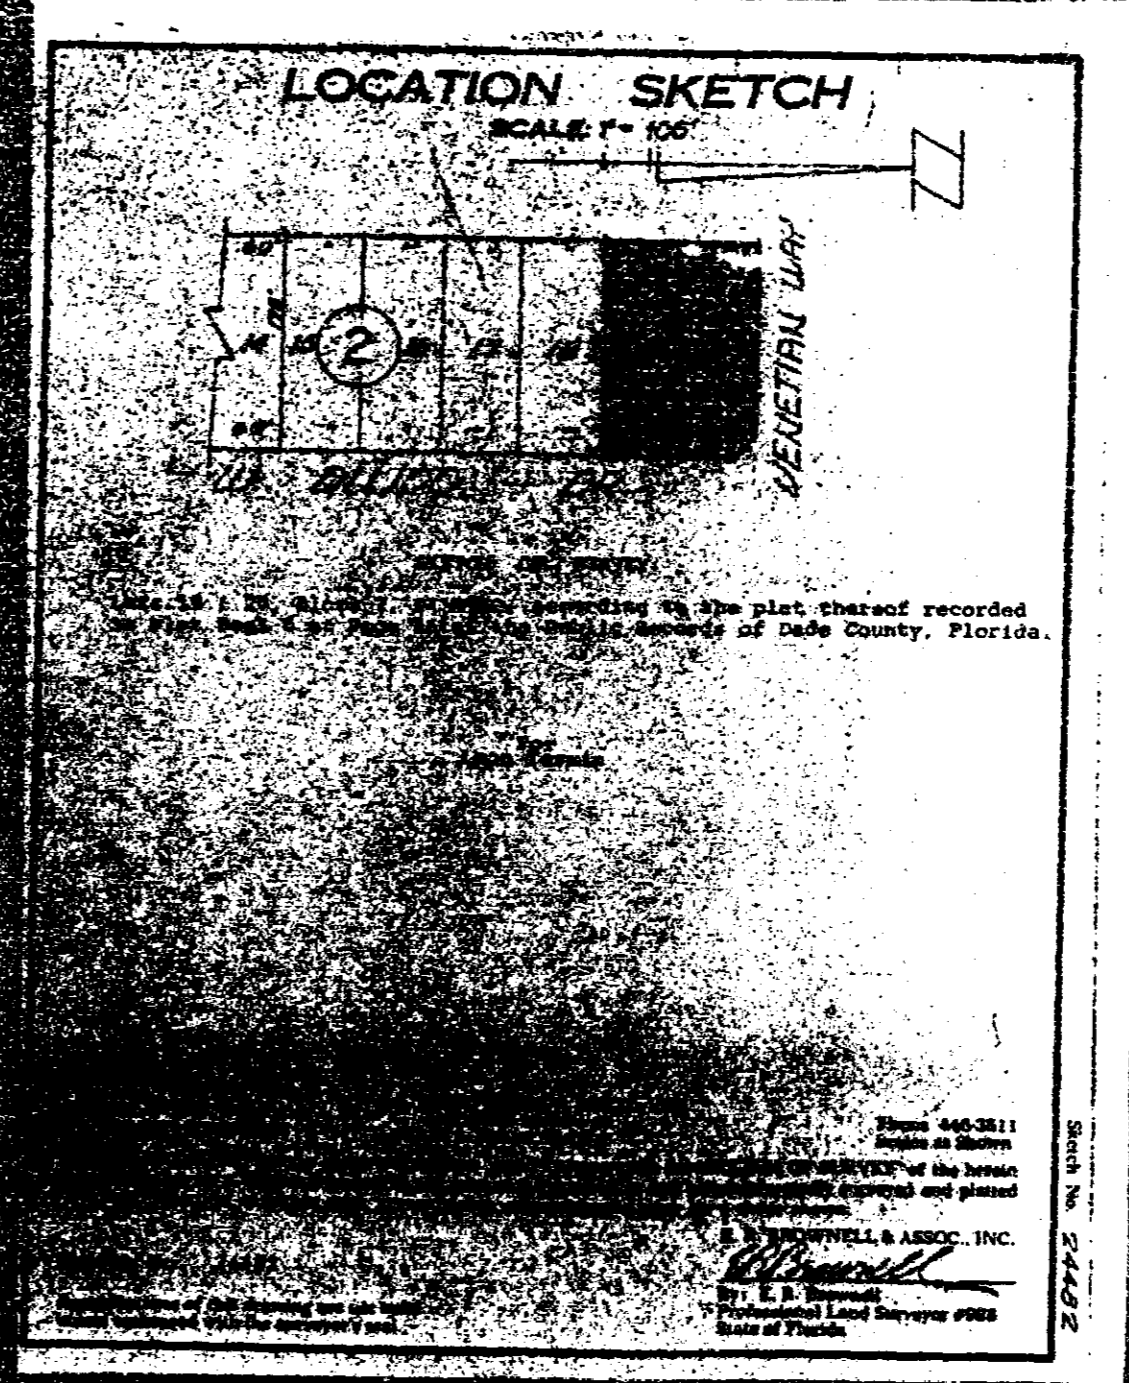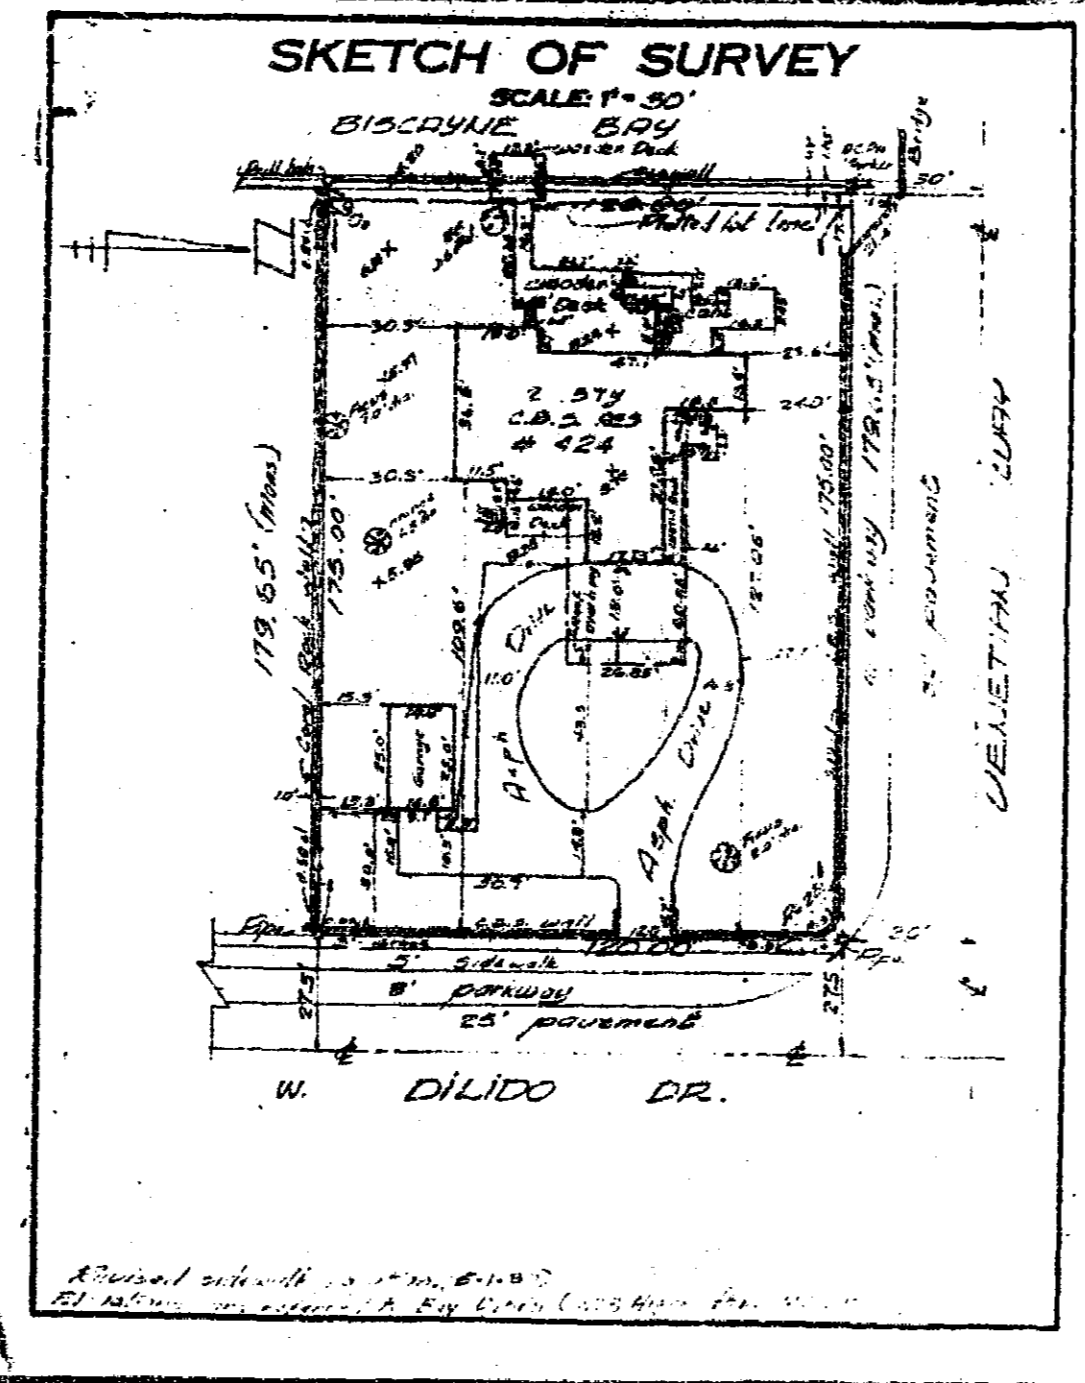

90261

FILE NO: 1312 APPLICANT LEON & JUDITH TERMIN
ADDRESS 424 West Dilido Drive
LOT - BLOCK - SUBDIVISION Lots 19 & 20, Block 2, Dilido Island Sub.

VARIANCE REQUESTED:
Applicant wishes to waive 2.5 ft. of the required 10 ft. side yard setback to construct a swimming pool, and waive 5 ft. of required 7 1/2 ft. for a pool deck.

DATE OF HEARING JULY 11, 1980
VARIANCE GRANTED July 11, 1980 VARIANCE DENIED _____
Approved with the following condition: Pool deck elevation shall not exceed 6 ft. 6 in.

PUBLIC WORKS DEPARTMENT Engineering Division
TO: CODE ENFORCEMENT DIVISION Construction Services
LEGAL DESCRIPTION: Lots 19 & 20, Blk 2, Di Lido Island
LEGAL ADDRESS: 424 W. Di Lido Drive
PLAN DESCRIPTION: Addition and swimming pool
THE ABOVE PLAN SUBMITTED TO THIS DIVISION NEEDS THE FOLLOWING CORRECTIONS:
GARBAGE FACILITIES: To use existing facilities
SANITARY SEWER: " "
WATER: " "
DRAINAGE: Pool waste water to be piped to bay. Drainage line to discharge below mean low water.
GRADES: As shown
ENCROACHMENTS: None
EASEMENTS: _____
PUBLIC WORKS DEPARTMENT PERMITS REQUIRED FOR WORK DONE ON CITY PROPERTY.
COMMENTS: Complete sections of sidewalk to be removed & replaced where necessary.
[Signature]
187-2101
APPROVED FOR PERMIT SUBJECT TO ABOVE CORRECTIONS 11/4/80 FRANK AYMONIN
(SLS) ENGINEERING DIV. *[Signature]*

90261

NEXT
Professional Microfilm Services, Inc.
Miami, Florida
FILE

THIS IS TO CERTIFY THAT PROFESSIONAL MICROFILM SERVICE, INC. PRESENTS THE FOLLOWING IMAGES AS AN ACCURATE AND COMPLETE MICROFILM COPY OF THE ORIGINAL BUSINESS FILES AS EDITED BY THE INSTITUTION INSTRUCTIONS.

PERMIT
B 7100 85

37




00501

**PREVIOUS DOCUMENT
IN POOR
ORIGINAL CONDITION**


Professional Microfilm Services, Inc.
Miami, Florida

50000019B

50000019B

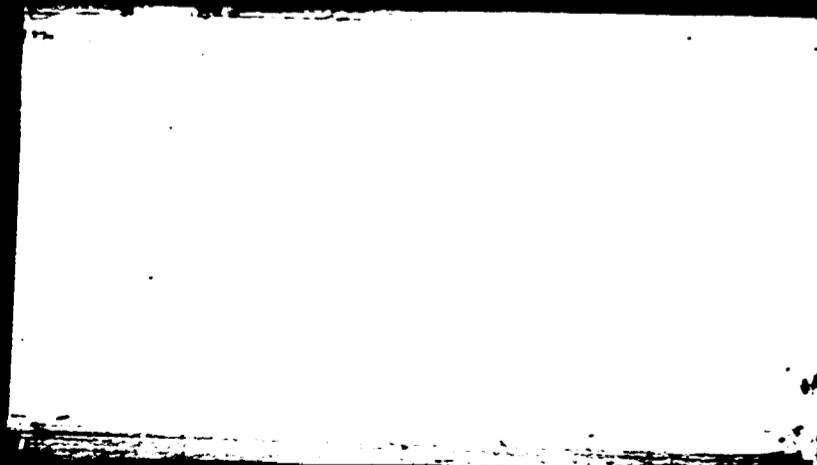

DISEYNE DAY

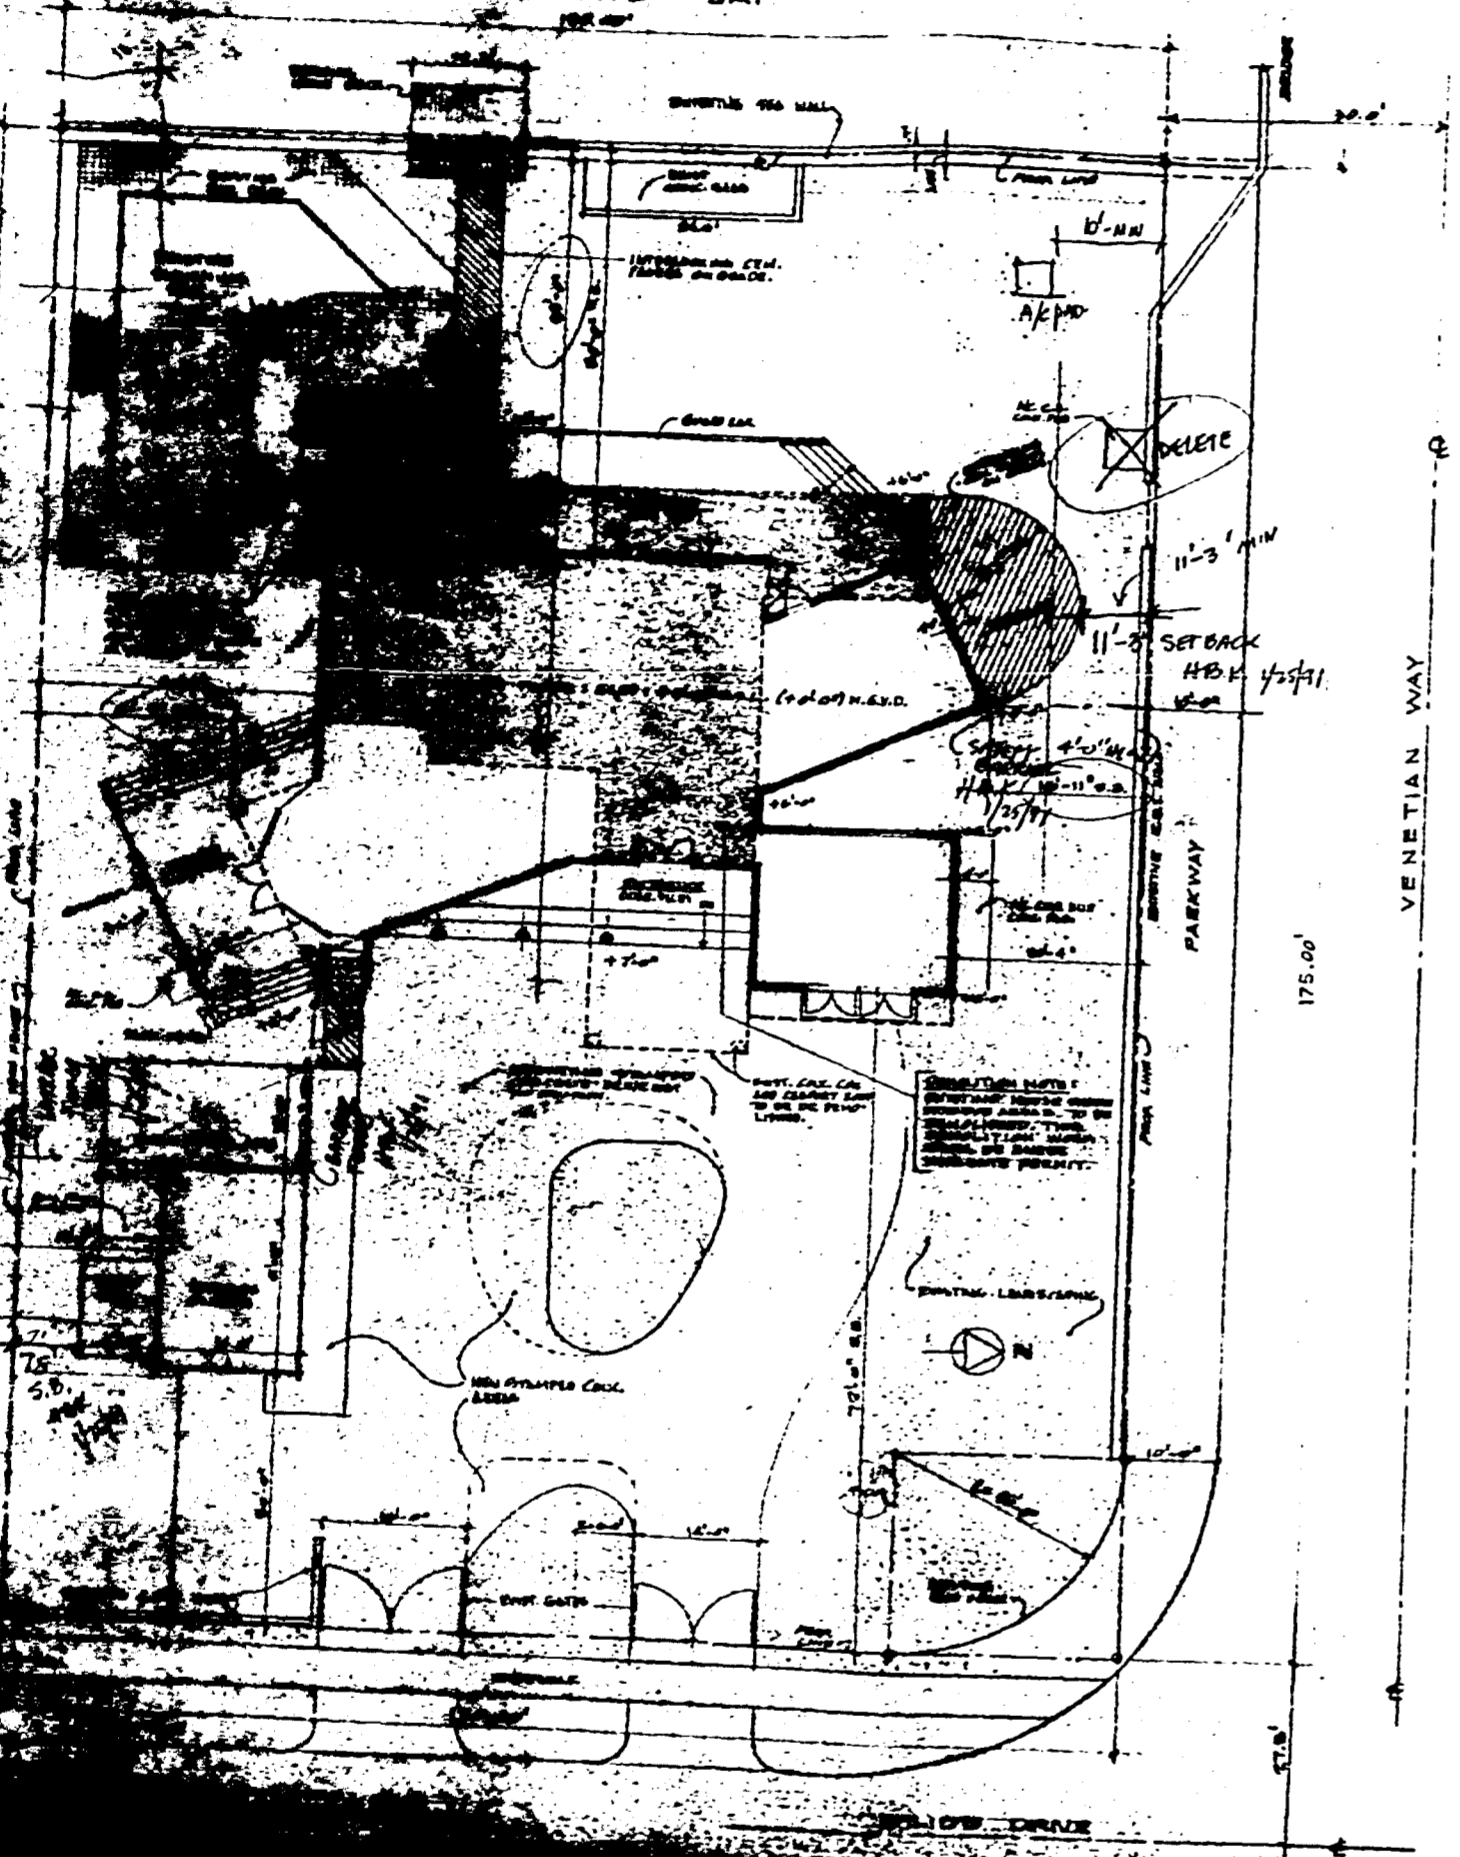

GENERAL NOTES

- THE EXPOSED BRICK SHALL BE 1/2" THICK (MIN.) OF THE "FRENCH BOND" TYPE, GLAZE TREATMENT AND INSTALLATION AS PER MANUFACTURER'S RECOMMENDATIONS. APPROVED MANUFACTURER'S "MADE IN U.S.A." MARKING SHALL BE SHOWN ON ALL BRICKS. APPROVED MANUFACTURER'S "MADE IN U.S.A." MARKING SHALL BE SHOWN ON ALL BRICKS. APPROVED MANUFACTURER'S "MADE IN U.S.A." MARKING SHALL BE SHOWN ON ALL BRICKS.
- THE EXPOSED BRICK MUST BE RESISTANT TYPE HYDRUS BRICK SHALL BE 1/2" THICK (MIN.) OF "FRENCH BOND" TYPE, GLAZE TREATMENT AND INSTALLATION AS PER MANUFACTURER'S RECOMMENDATIONS. APPROVED MANUFACTURER'S "MADE IN U.S.A." MARKING SHALL BE SHOWN ON ALL BRICKS. APPROVED MANUFACTURER'S "MADE IN U.S.A." MARKING SHALL BE SHOWN ON ALL BRICKS.
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Henry B. Konover A.I.A.
 Henry B. Konover Architects & Planners P.A.
 4014 Chase Ave., Miami Beach, Florida 33140 (305) 674-0960

OFFICE COPY
 CITY OF MIAMI BEACH
 APPROVED FOR PERMIT BY
 THE FOLLOWING:

DATE: 1/25/41
 BY: HBK

DES. SMITH RESIDENCE
 4014 CHASE DRIVE
 MIAMI BEACH, FLORIDA

SITE PLAN
 1" = 10'-0"

DATE: 1-25-41
 BY: HBK


A-2
 SHT. 2 OF 2

Henry B. Konover
 1/25/41

500000-99B

000504

DATE: 11/24/70
SCALE: 1/4" = 1'-0"

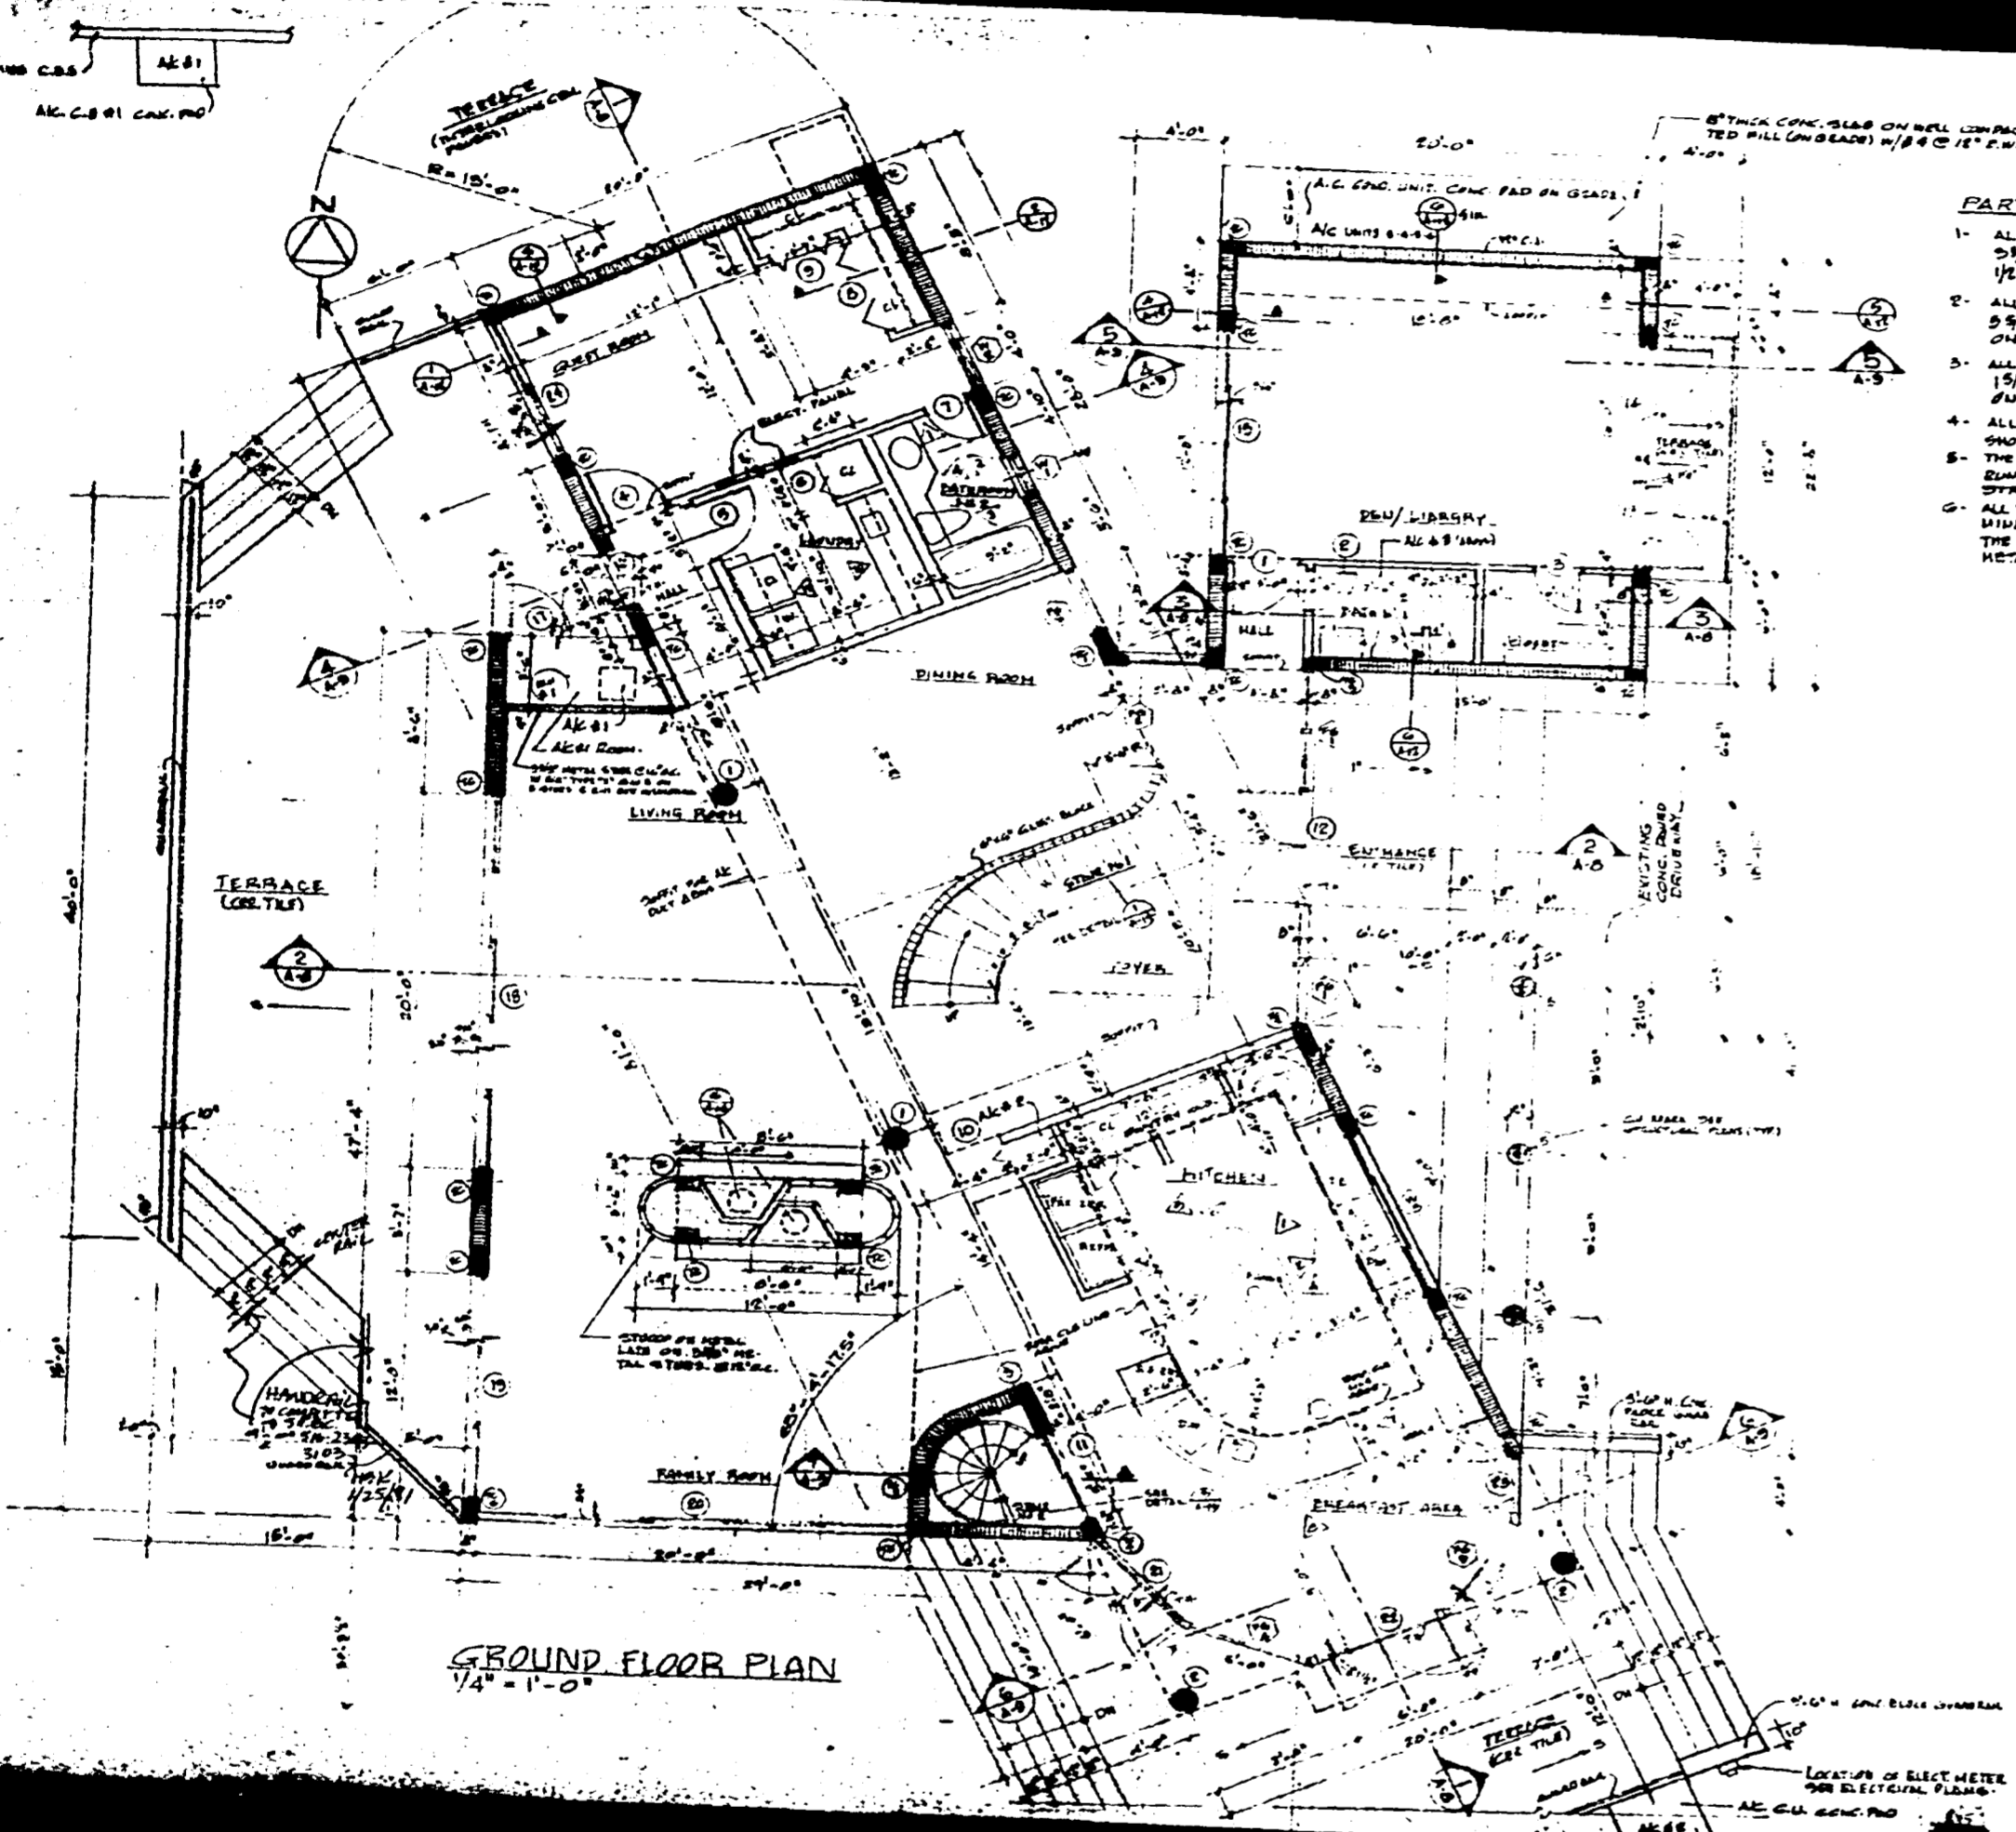

- PARTITIONS NOTES** - SEE ALL NOTES ON SHEET 212
- 1- ALL PARTITIONS SHOWN (6" TH) SHALL BE GALVANIZED 3 1/2" GA-25 METAL STUDS @ 24" O.C. (SWAN) WITH 1/2" G.W.B. (GYPSUM WALL BOARD) ON EACH SIDE.
 - 2- ALL PARTITIONS SHOWN (6" TH) SHALL BE GALVANIZED 3 1/2" GA-25 METAL STUDS @ 24" O.C. WITH 1/2" G.W.B. ON EACH SIDE.
 - 3- ALL PARTITIONS SHOWN (6" TH) SHALL BE GALVANIZED 1 1/2" METAL STUDS @ 24" O.C. WITH 1/2" G.W.B. ON EACH SIDE.
 - 4- ALL PARTITIONS IN CONTACT WITH CONCRETE LINE STUDS & SHOWER WALL SHALL BE MOISTURE RESISTANT TYPE.
 - 5- THE METAL STUDS PARTITION SHALL HAVE TOP & BOTTOM STUDS ANCHORED, NOT MORE THAN 24" O.C. FROM TO.
 - 6- ALL THE OUTSIDE EDGES OF PARTITIONS SHALL BE TERMINATED WITH METAL CORNER BRACKETS AND A FABRIC REINFORCED INSIDE CORNER. EXPOSED EDGE SHALL RECEIVE A METAL TRIM CONTINUOUS.

OFFICE COPY
 CITY OF MIAMI BEACH
 PERMITTED FOR PERMIT BY
 THE FOLLOWING:
 [Signature]
 [Date]

Henry B. Konover A.I.A.
 Henry B. Konover Architects & Planners P.A.
 4014 Chase Ave., Miami Beach, Florida 33140 (305) 675 0990

MRS. S. SMITH RESIDENCE
 424 BILIBO DRIVE
 MIAMI BEACH, FLORIDA




GROUND FLOOR PLAN
 1/4" = 1'-0"

DATE: 11/24/70
 DRAWN: H.B.K.
 CHECK: H.B.K.

COMM 9000
A-3
 SHT. 5 OF 5

1000000-9B

1000000-9B

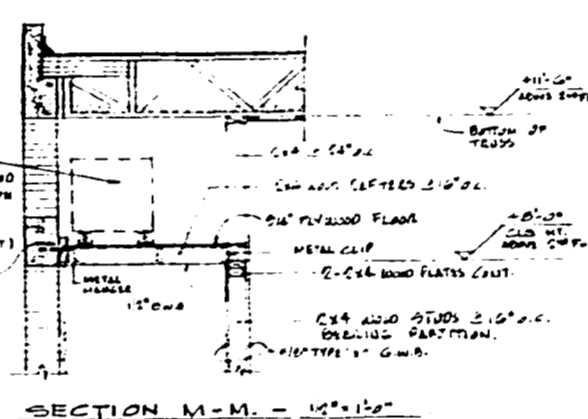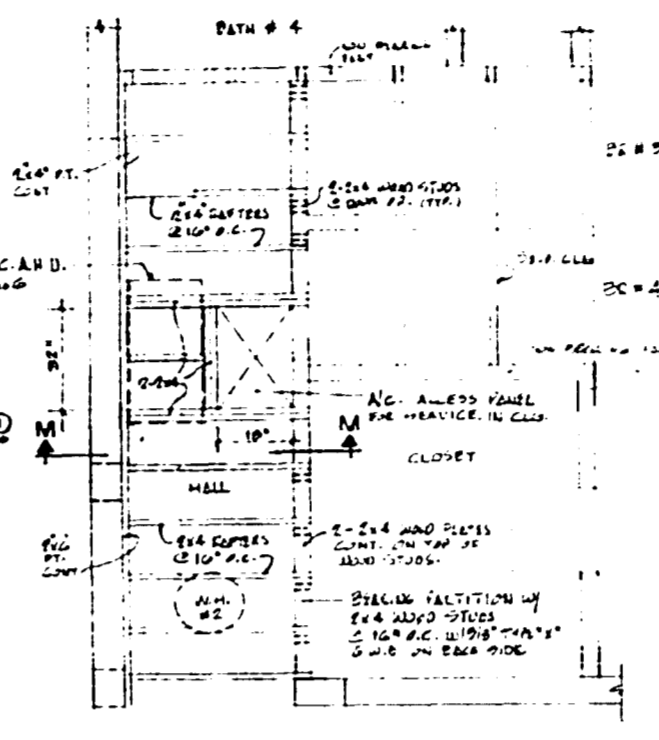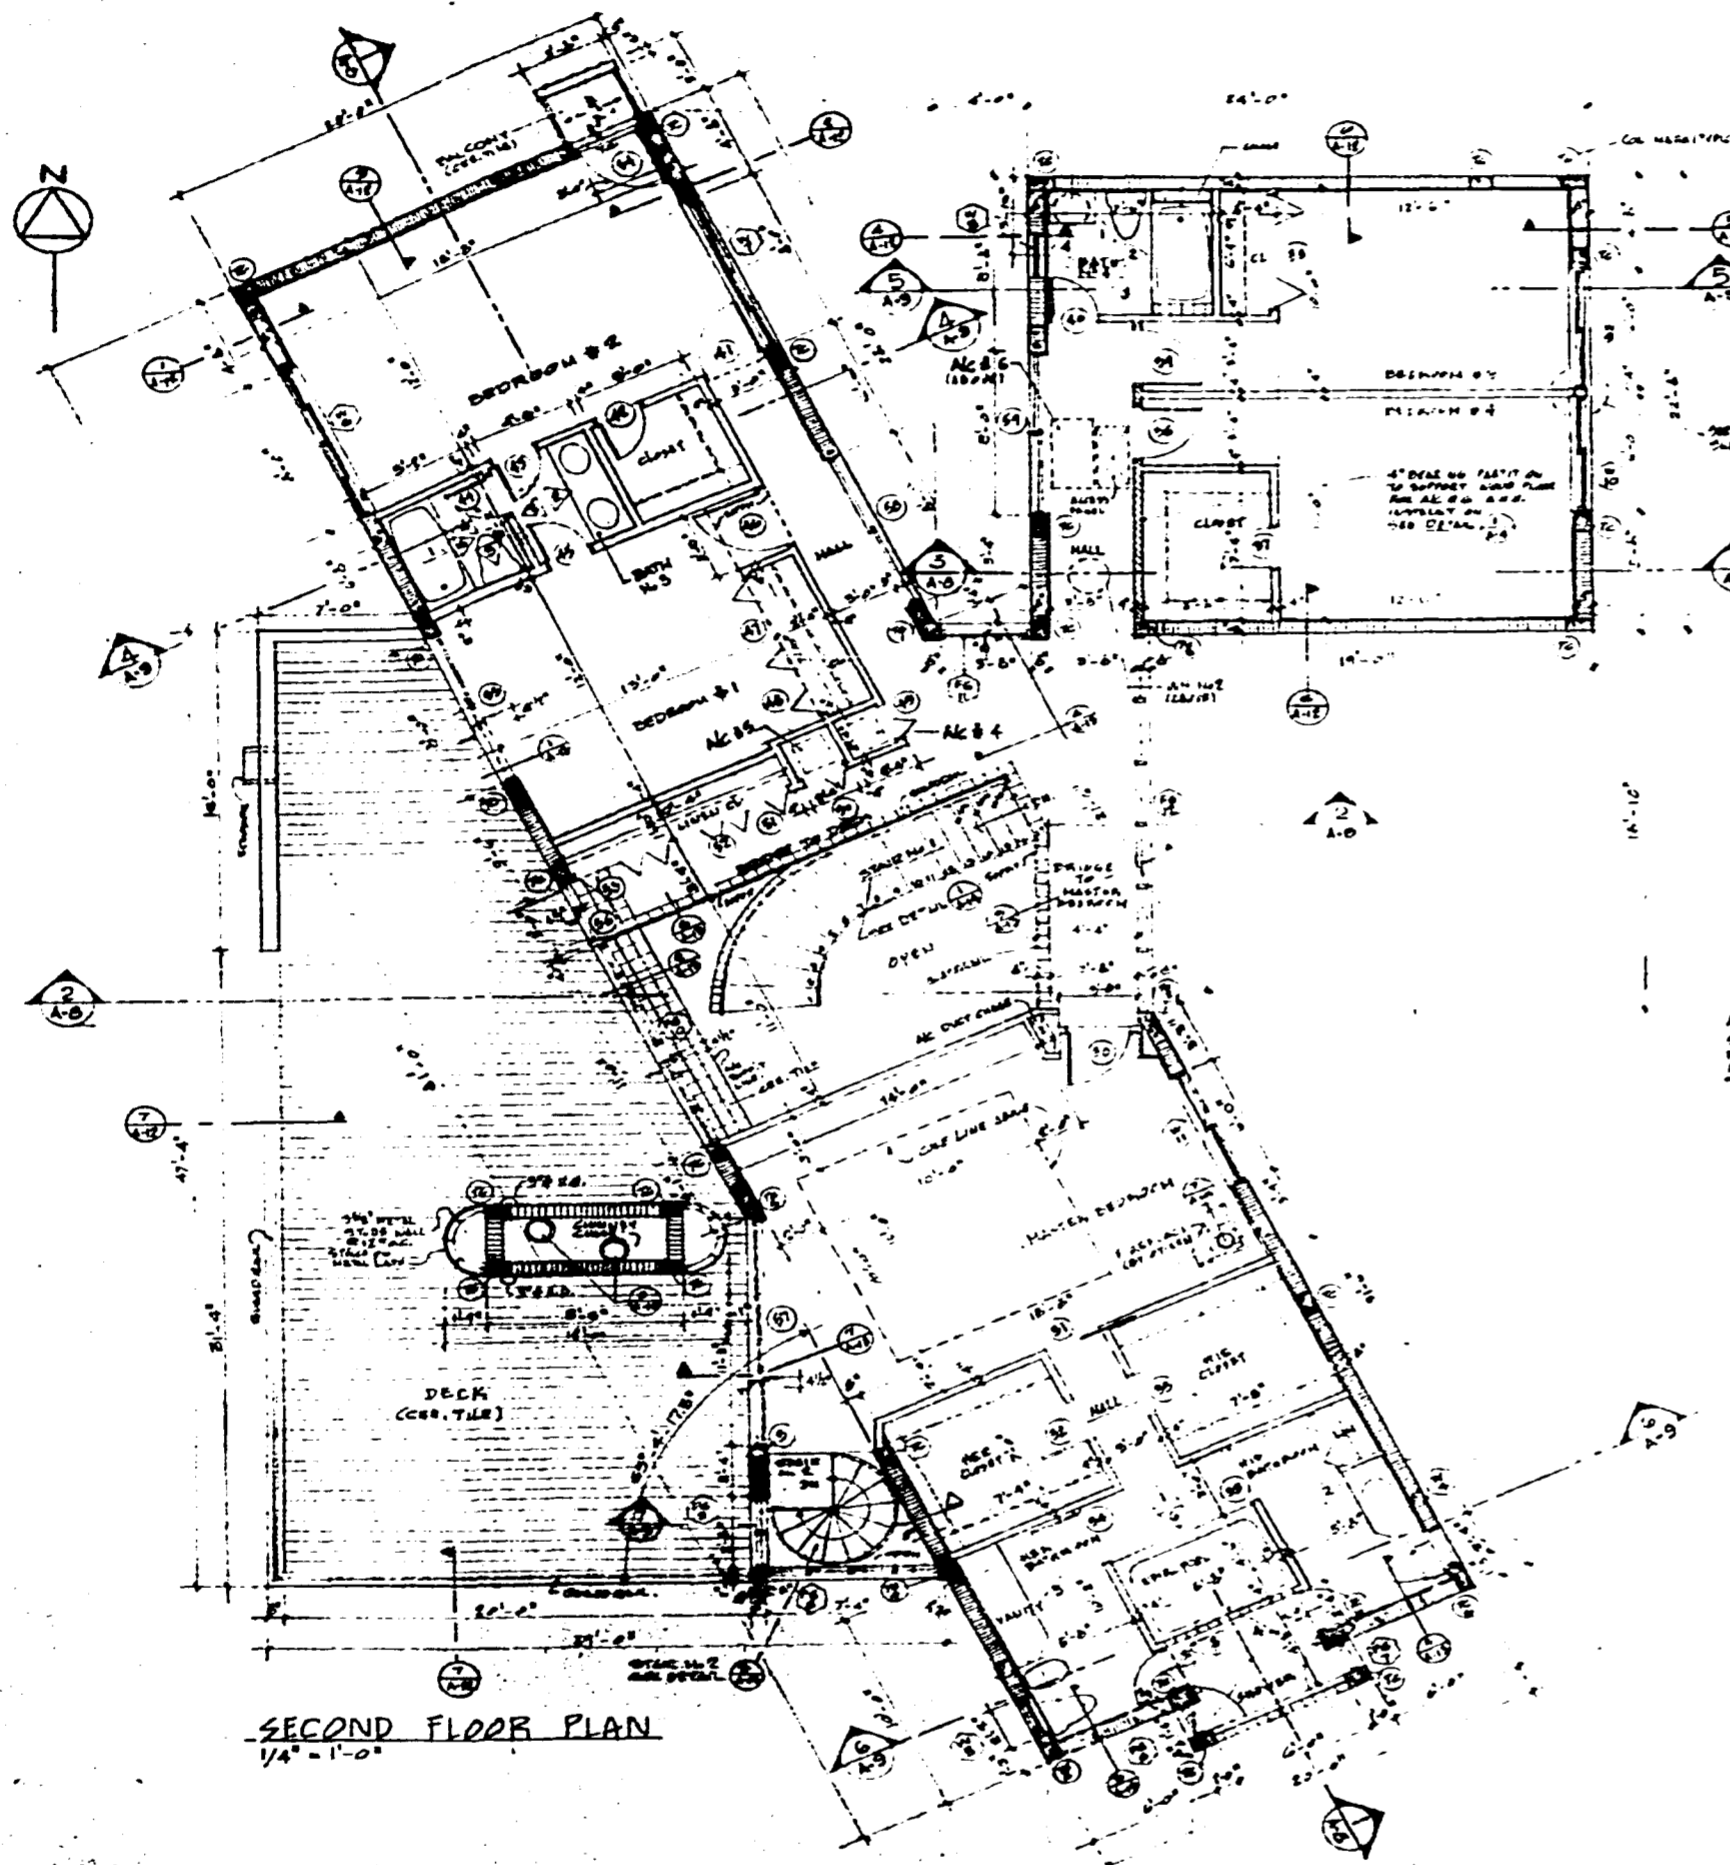


APPROVED FOR PERMIT BY
 THE FOLLOWING:
 [Signature]
 [Signature]
 [Signature]
 [Signature]
 [Signature]

Henry B. Konover A.I.A.
 Henry B. Konover Architects & Planners P.A.
 4014 Chase Ave., Miami Beach, Florida 33140 (305) 874 0900

DR. B. SMITH RESIDENCE
 424 DILLIDO DRIVE
 MIAMI BEACH, FLORIDA
 SECOND FLOOR PLAN
 1/4" = 1'-0"
 DATE: 11-27-90
 DRAWN: J.M.
 CHECK: H.B.K.
 COMM 0000
 A-4
 SHT. 4 OF 16




500000-9B

00000000

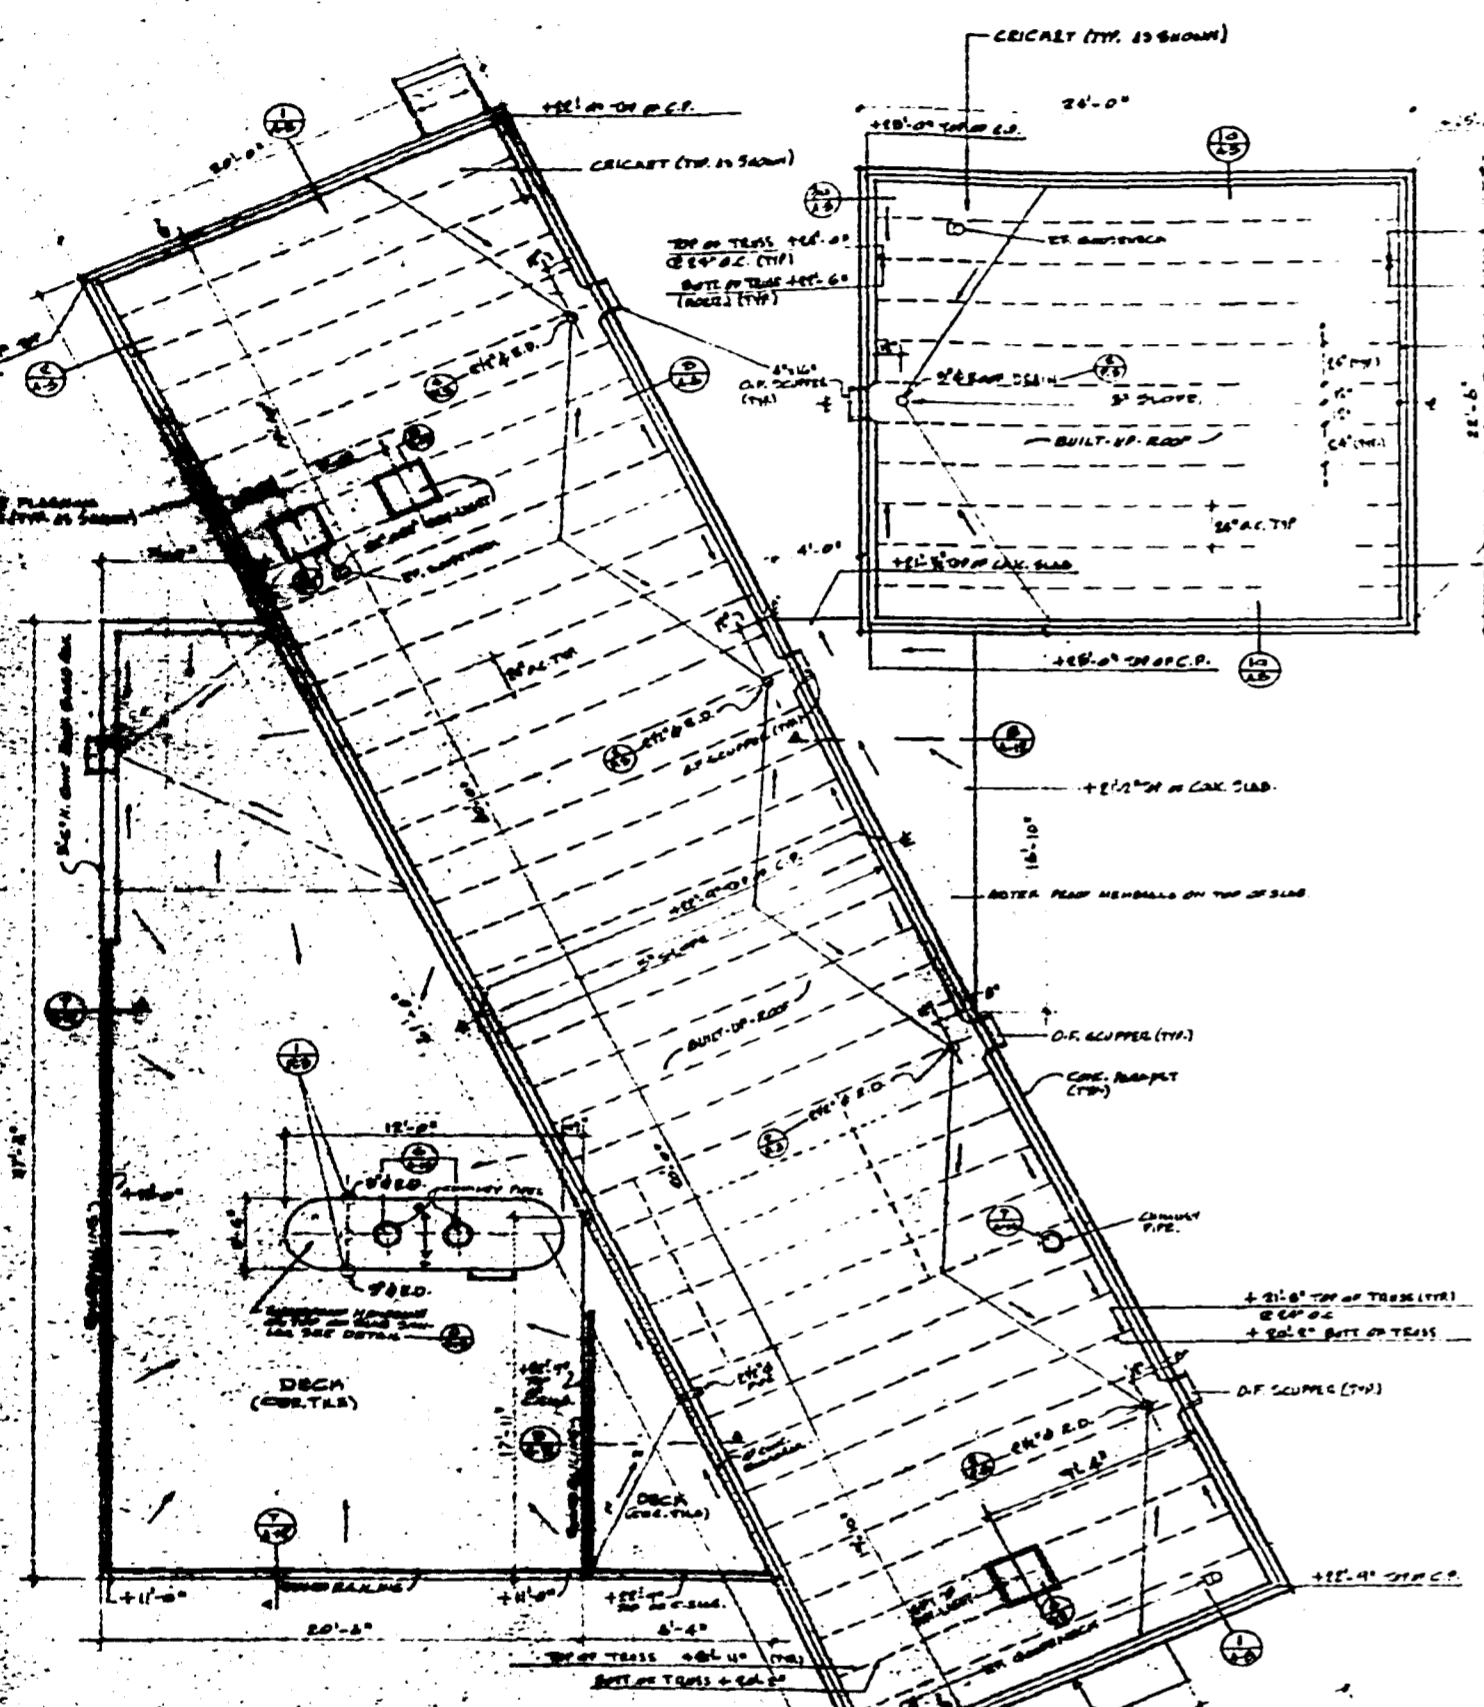

ROOF PLAN
1/4" = 1'-0"

OFFICE COPY
 CITY OF MIAMI BEACH
 APPROVED FOR PERMIT BY
 THE FOLLOWING:
 BUILDING: [Signature]
 ZONING: [Signature]
 PLUMBING: [Signature]
 ELECTRICAL: [Signature]
 MECHANICAL: [Signature]
 FIRE PREVENTION: [Signature]
 ENGINEERING: [Signature]

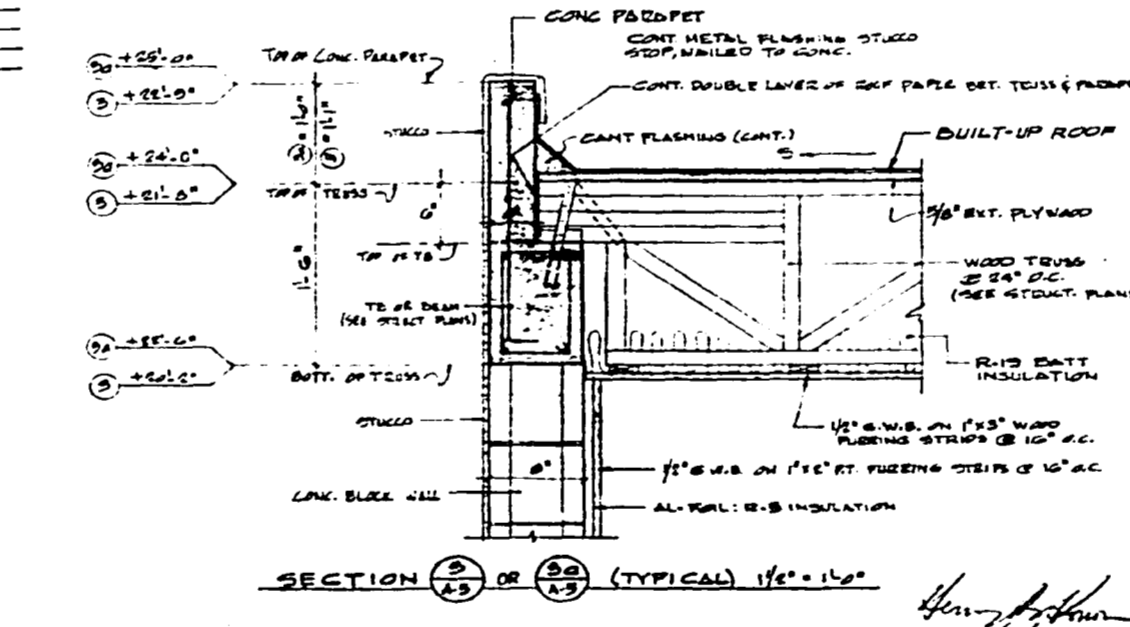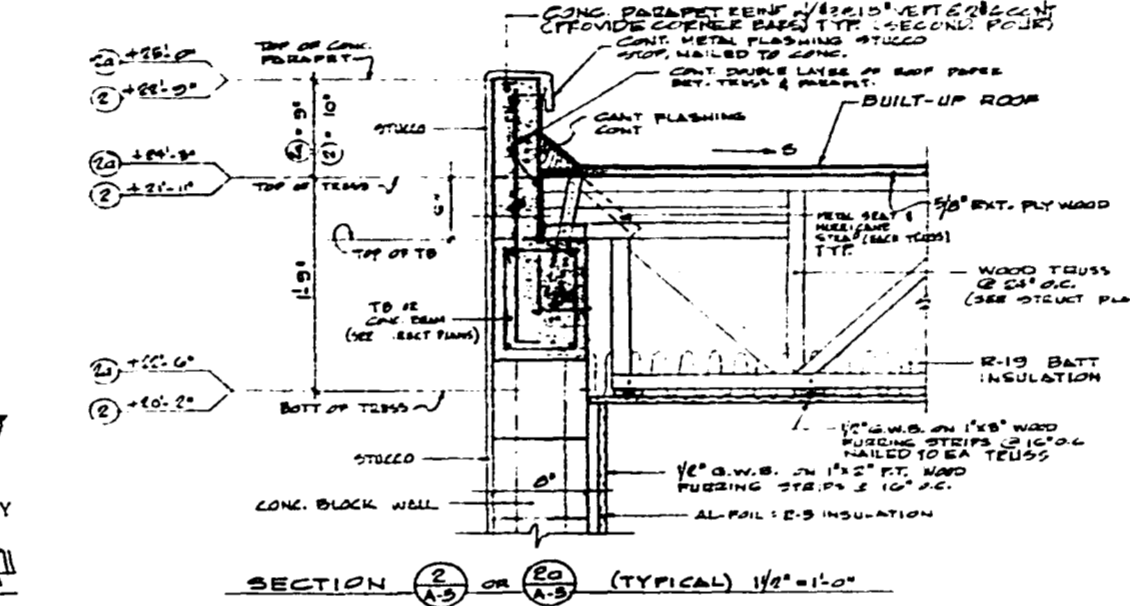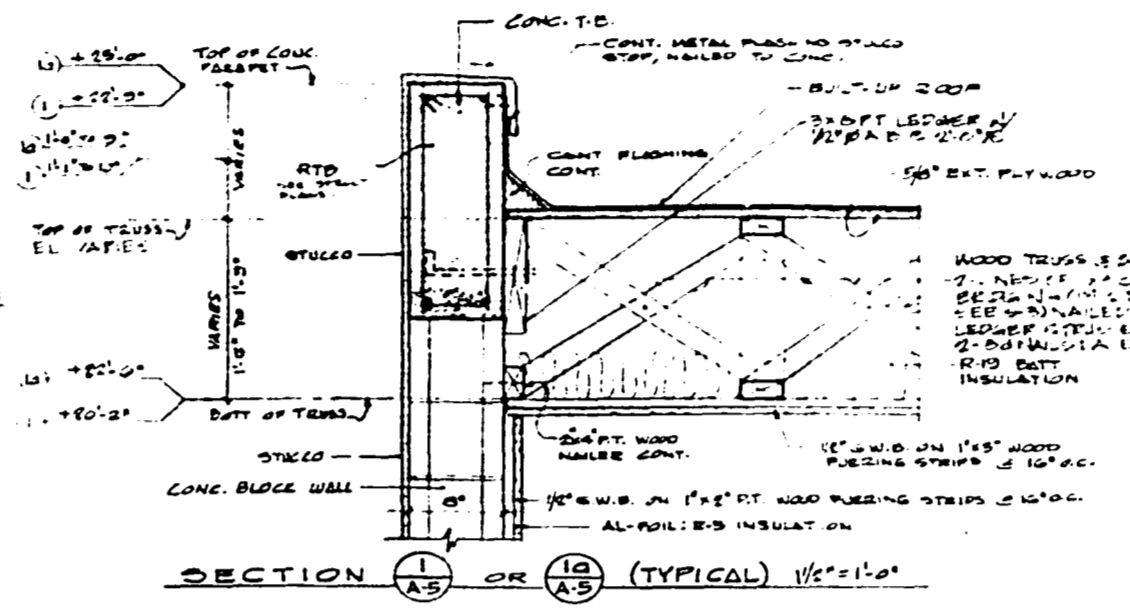

Henry B. Konover A.I.A.
 Henry B. Konover Architects & Planners P.A.
 401 Chase Ave., Miami Beach, Florida 33140 (305) 675-0880

RESIDENCE
 424 BILLY DRIVE
 MIAMI BEACH, FLORIDA
 33133

ROOF PLAN
 ROOF PARAPETS DETAILS


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 BY: H.B.K.

CONC. [Signature]


A-5

500000-99B

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EAST ELEVATION
1/4" = 1'-0"

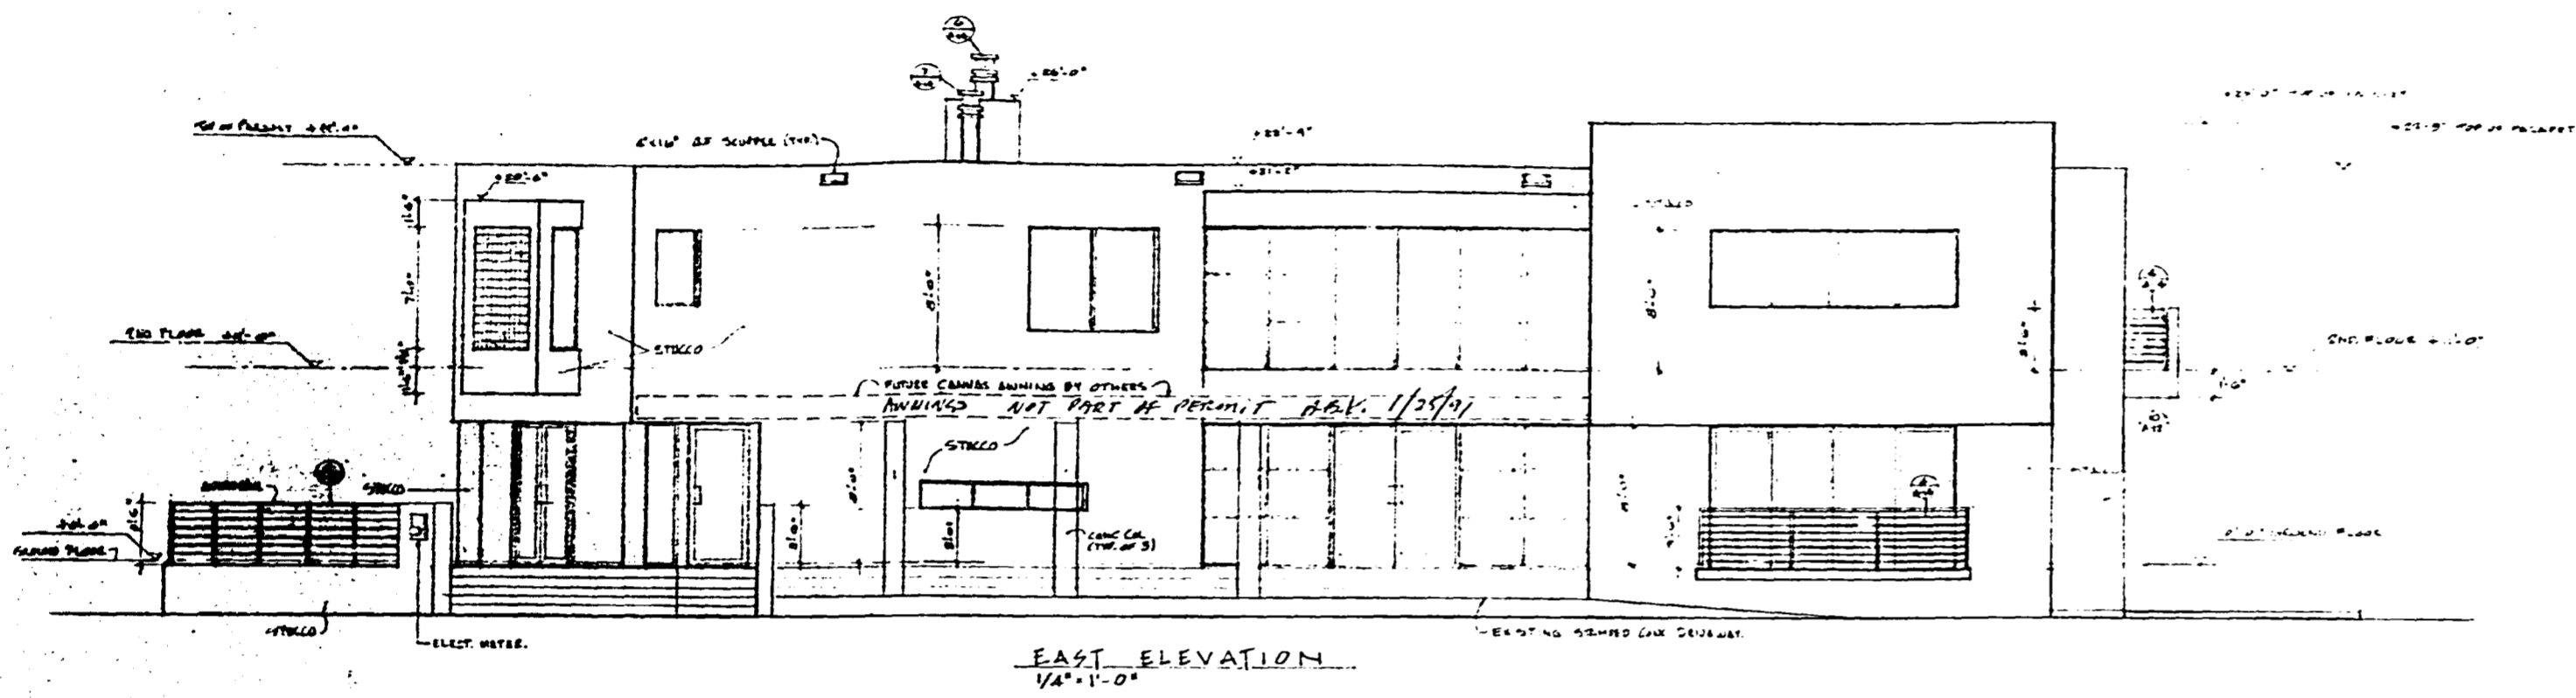

WEST ELEVATION
1/4" = 1'-0"


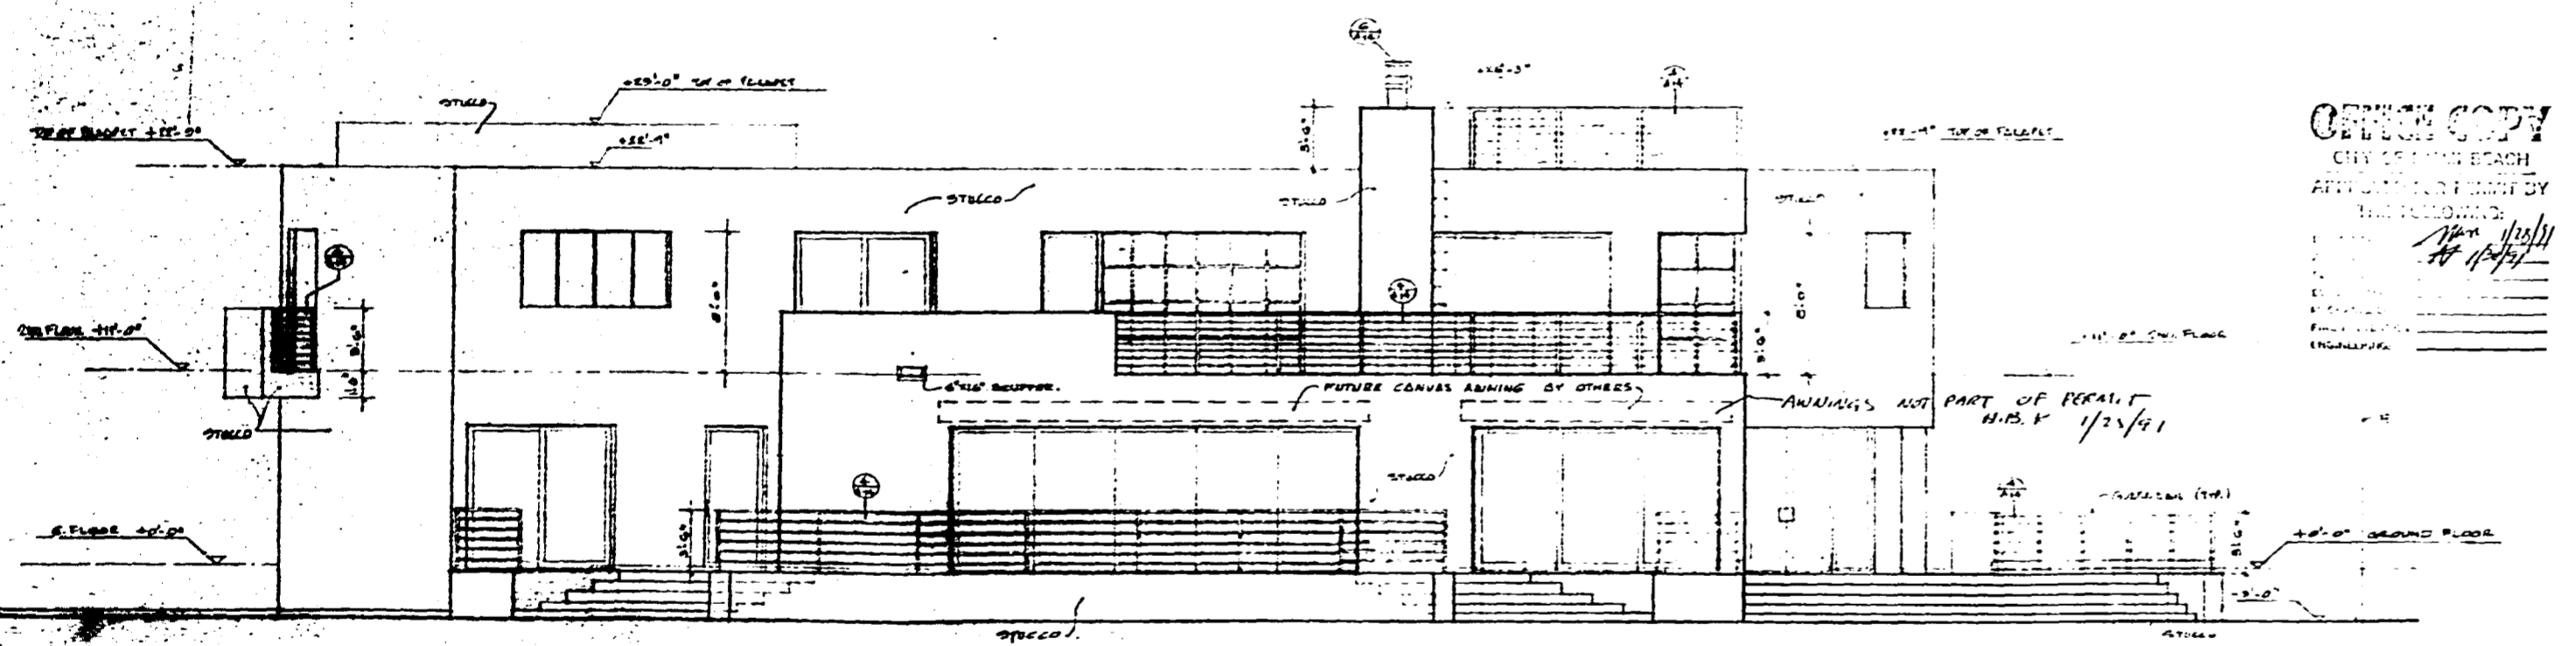
OFFICE COPY
CITY OF MIAMI BEACH
APPROVED FOR PERMIT BY
THE ENGINEER:
[Signature]
DATE: 1/25/41

Henry B. Konover A.I.A.
Henry B. Konover Architects & Planners P.A.
4014 Chase Ave., Miami Beach, Florida 33140 (305) 673-0960

DRS. SMITH RESIDENCE
424 DIEDO DRIVE
MIAMI BEACH, FLORIDA
ELEVATIONS EAST & WEST
1/4" = 1'-0"
DATE: 11-27-79
DRAWN: K.P.A.
CHECK: H.B.K.
COMM. 90.01
A-6
SHT. 6 OF 11
[Signature]
1/25/41

5000009100008

0000008

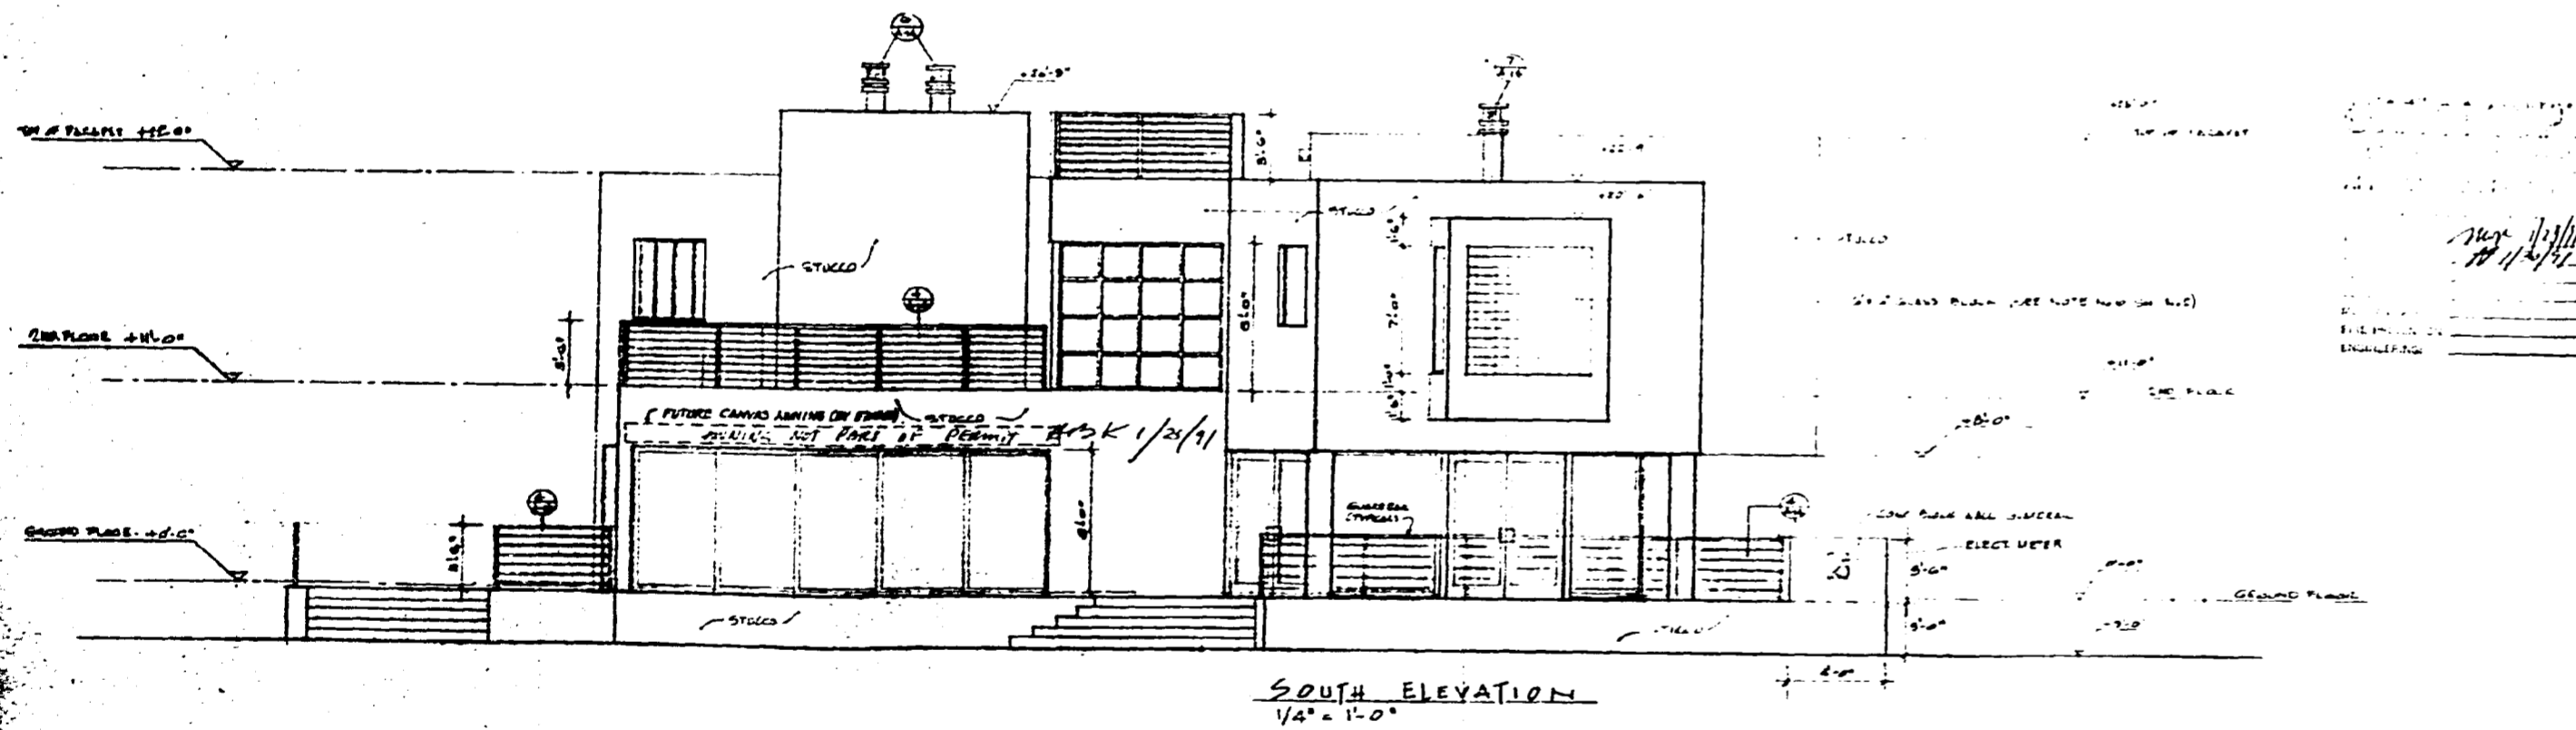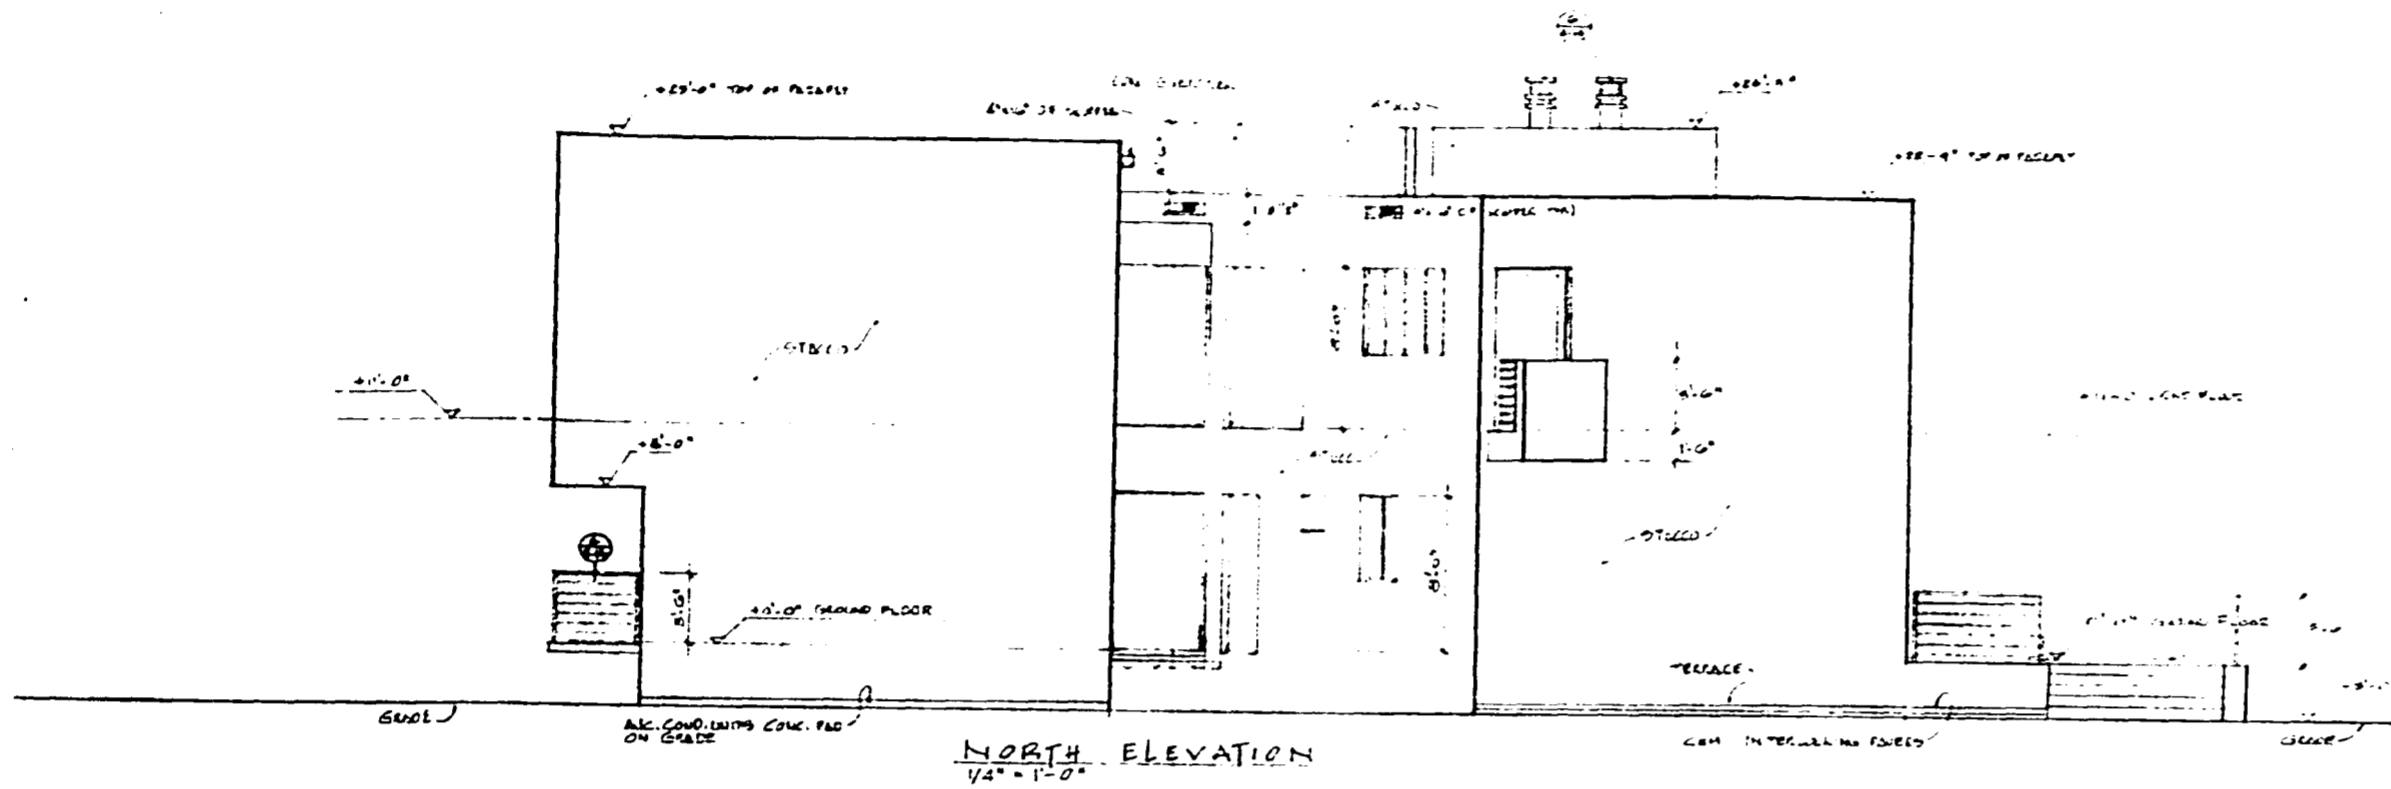

Henry B. Konover A.I.A.
 Henry B. Konover Architects & Planners P.A.
 4014 Chase Ave., Miami Beach, Florida 33140 (305) 874-0800

DR. SMITH RESIDENCE
 424 DIXIE DRIVE
 MIAMI BEACH, FLORIDA

ELEVATIONS
 1/4" = 1'-0" SOUTH & NORTH


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 CHECKED BY: H.B.K.

COMM. 2-2074
A-7
 SHEET 7 OF 8

Henry B. Konover
 11/15/77

500000-9B

000509

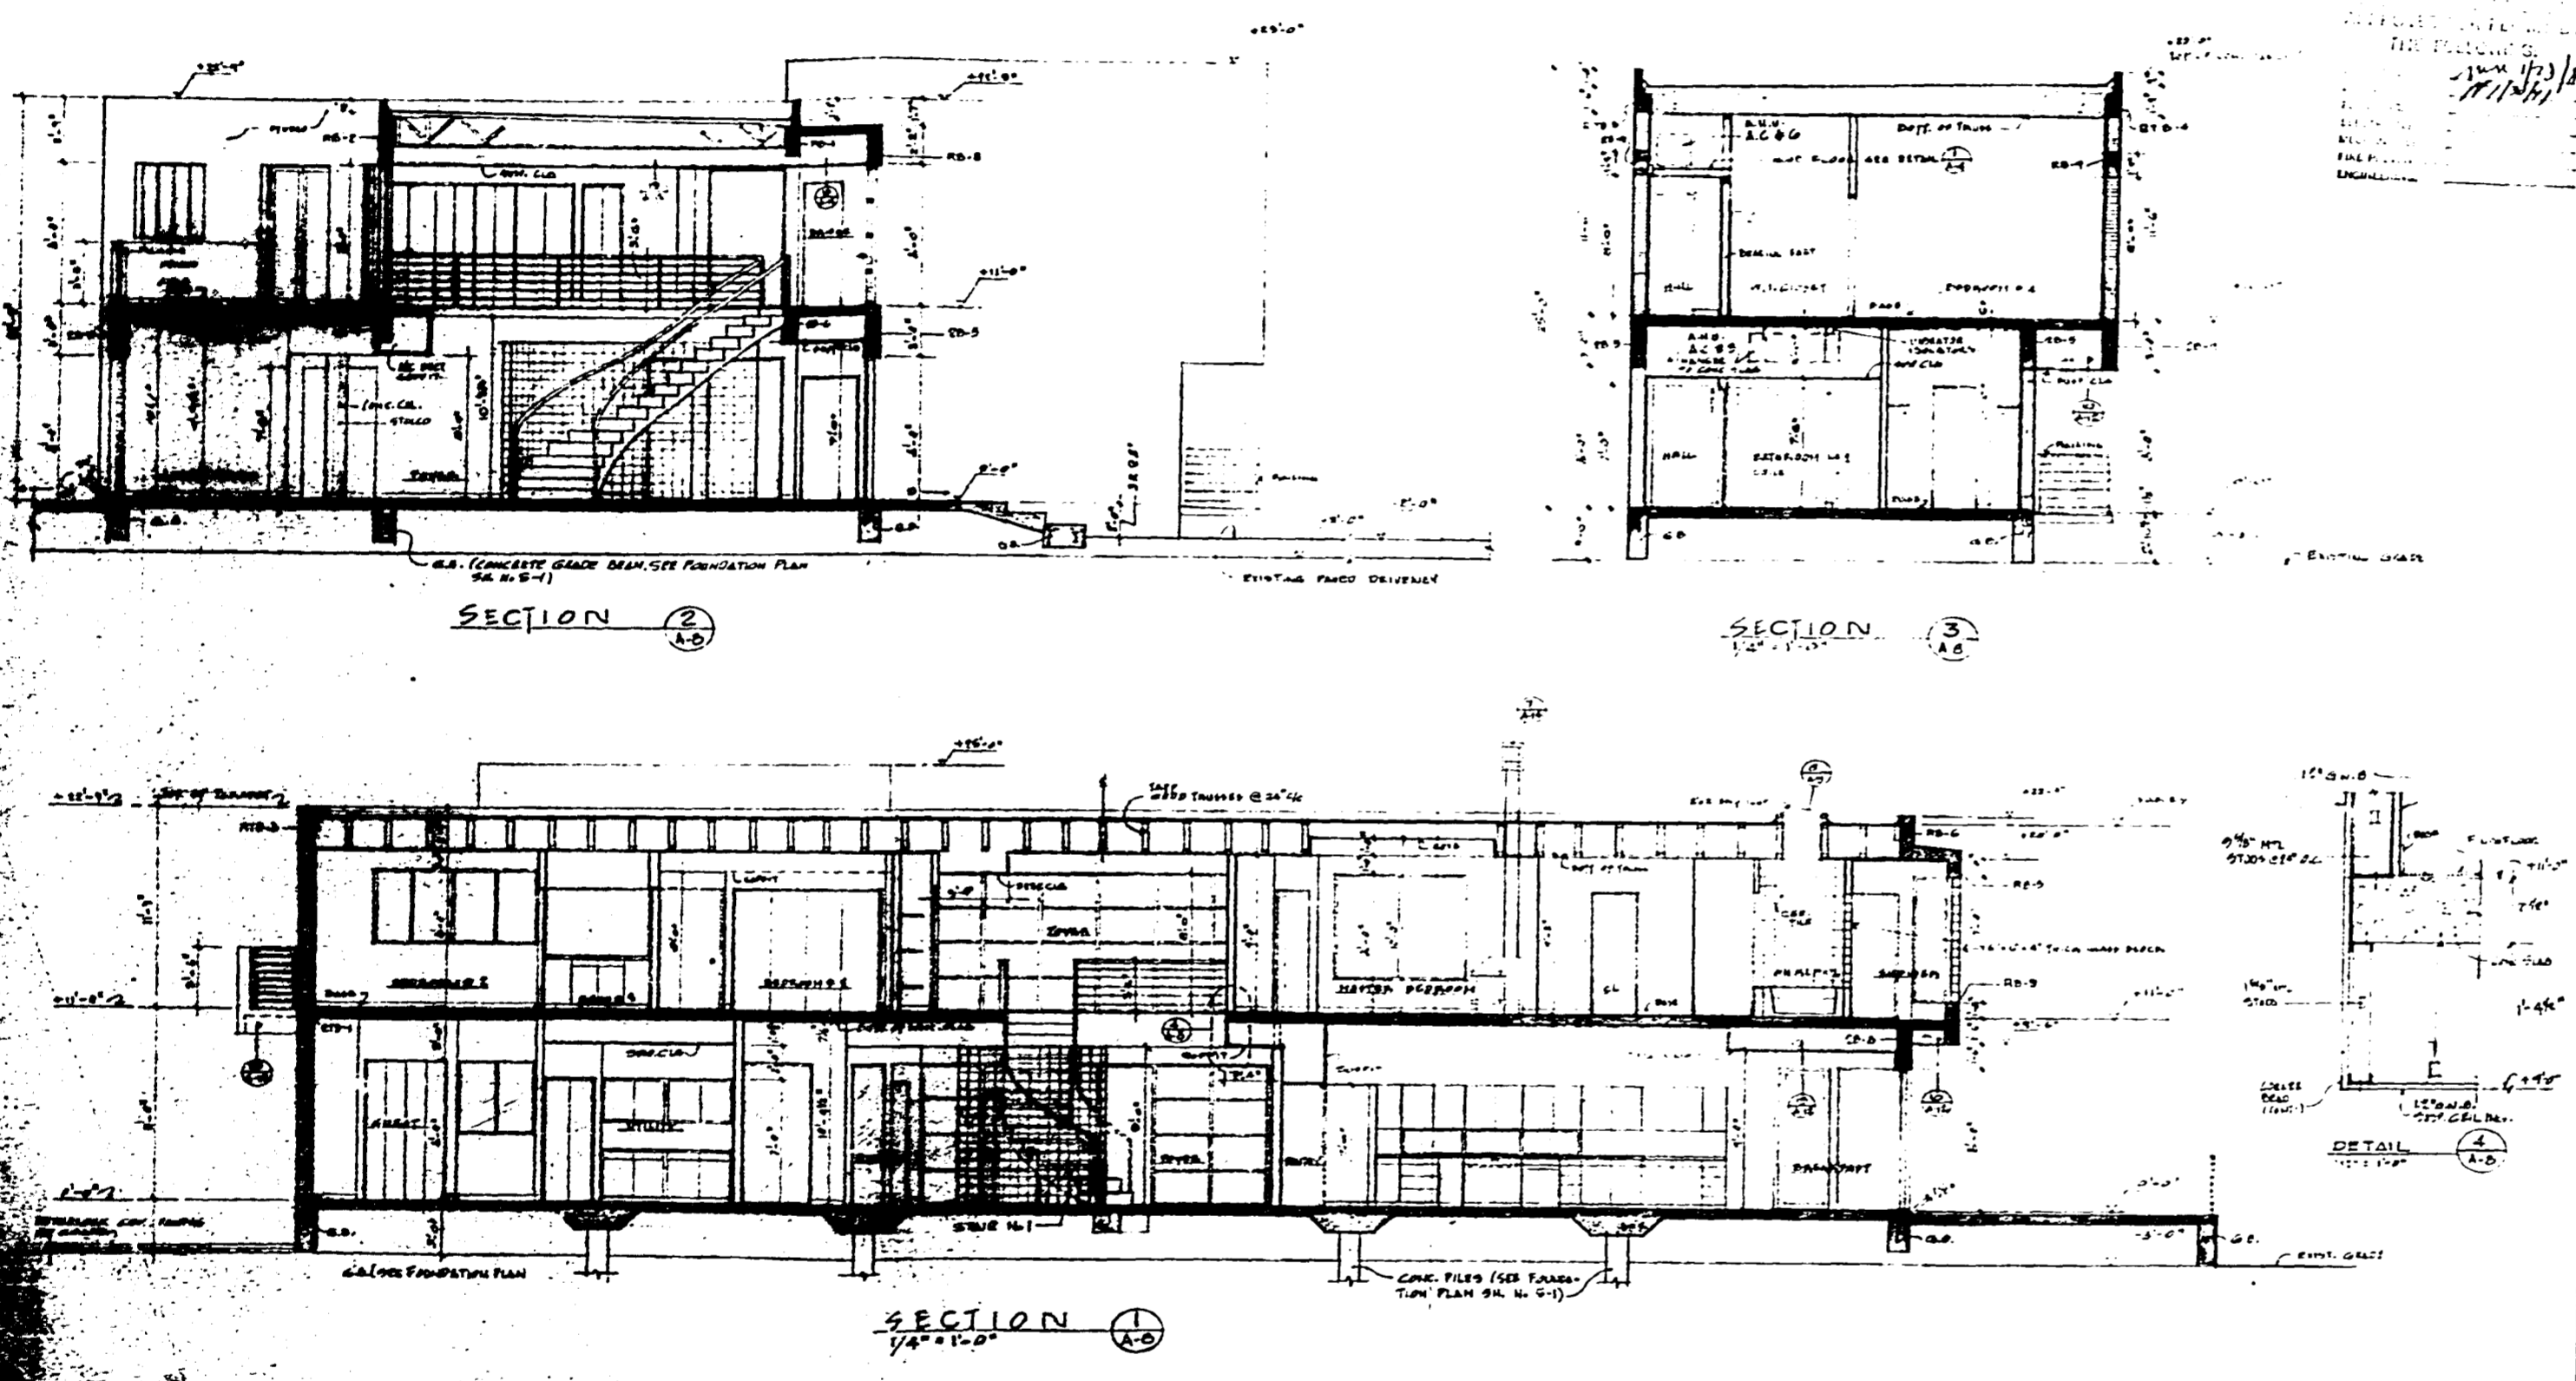

Henry B. Konover A.I.A.
 Henry B. Konover Architects & Planners P.A.
 4014 Chase Ave., Miami Beach, Florida 33140 (305) 671-0900

DRS. SMITH RESIDENCE
 424 DELINO DRIVE
 MIAMI BEACH, FLORIDA

SECTIONS
 1/4" = 1'-0"


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 CHECKED BY: H.B.K.

CONCRETE
 A-8
 INT. & EXT.

Henry B. Konover
 11/27/79

50000009B


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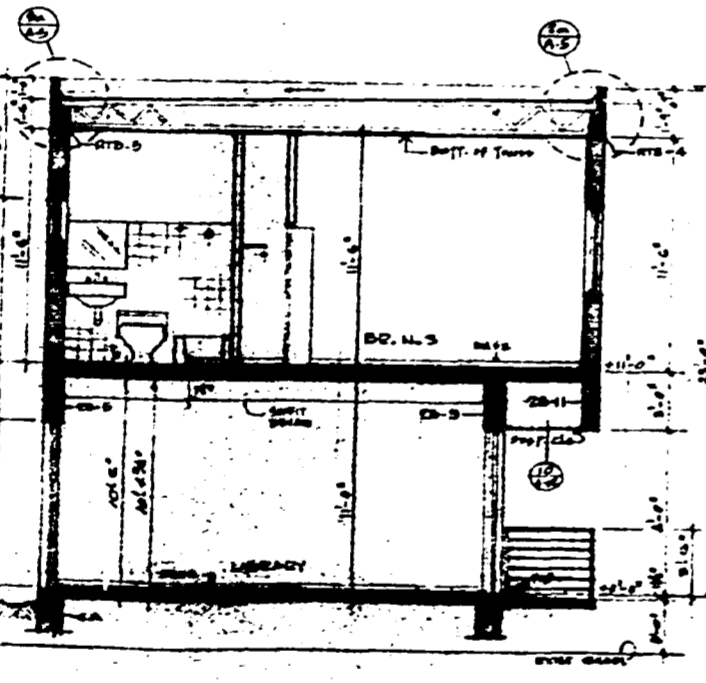
MODEL ASC-9 SINGLE ACRYLIC DOME, SELF SUBING UNIT BY PAULHNER PLASTIC INC. 212 E. 21ST ST. ST. LOUIS, MO. 63103

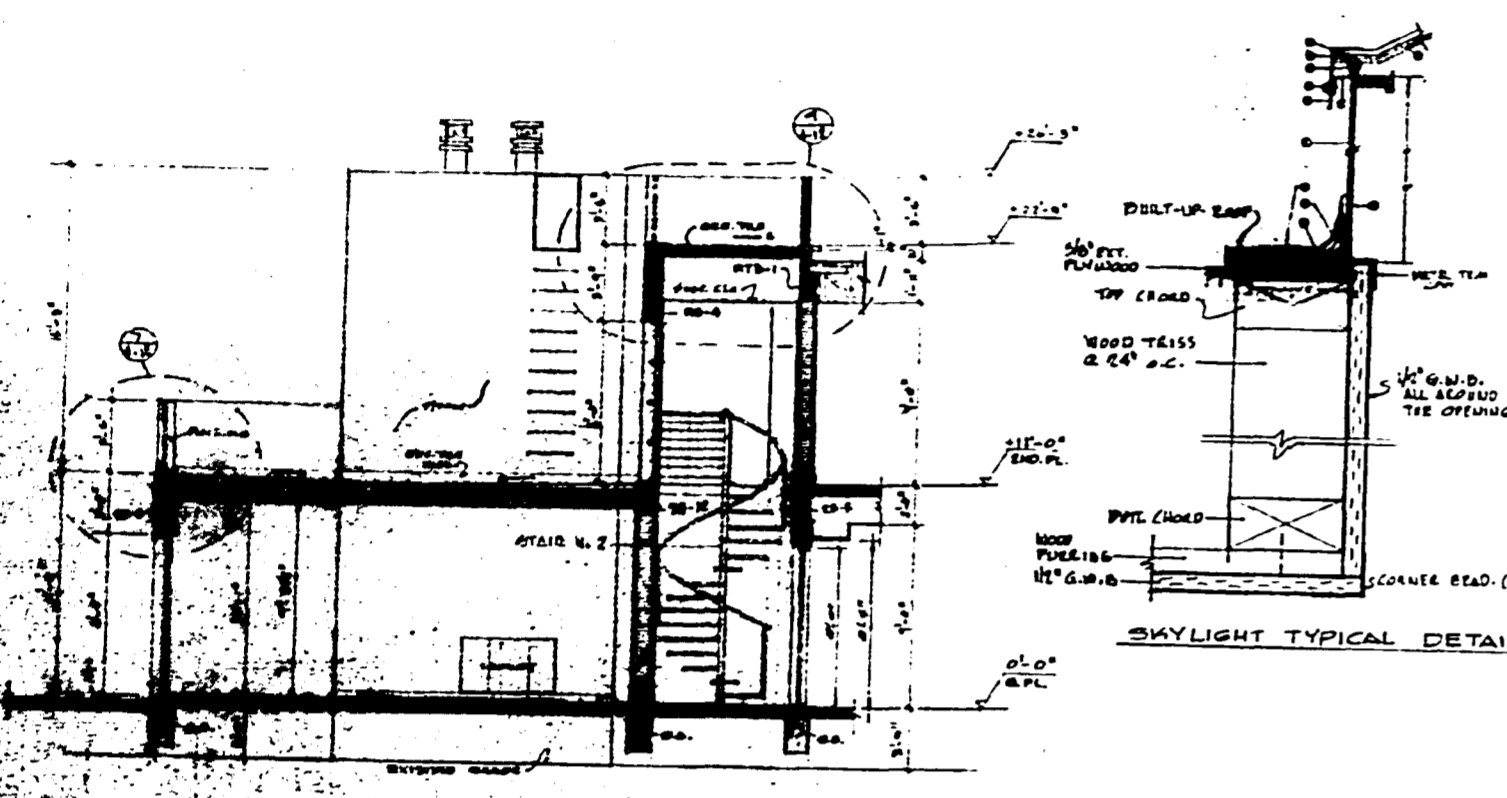LEGEND:
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 2. EXTENDED ALUM. CONTAINING FRAME (CANTILEVER)
 3. CONTAINING SCREEN
 4. MOUNTING OUTSCREW
 5. SEALING GASKET
 6. GASKET-TWIN GUMS ONLY
 7. WET PASTE/DRAINAGE WARE-AS REQUIRED
 8. INHIBIT DOME - OPTIONAL
 9. GUTTER DOME (SOLAR BEARER-2370)
 10. ROOF DECK
 11. FLASHING MASTIC
 12. INSIDE GIRD/ROOF OPENING: UNIT - 2850 SQUARE = 22 1/2" x 21 1/2"


SKYLIGHT TYPICAL DETAIL (S) N.T.S.



SECTION 1 (1/4" = 1'-0")

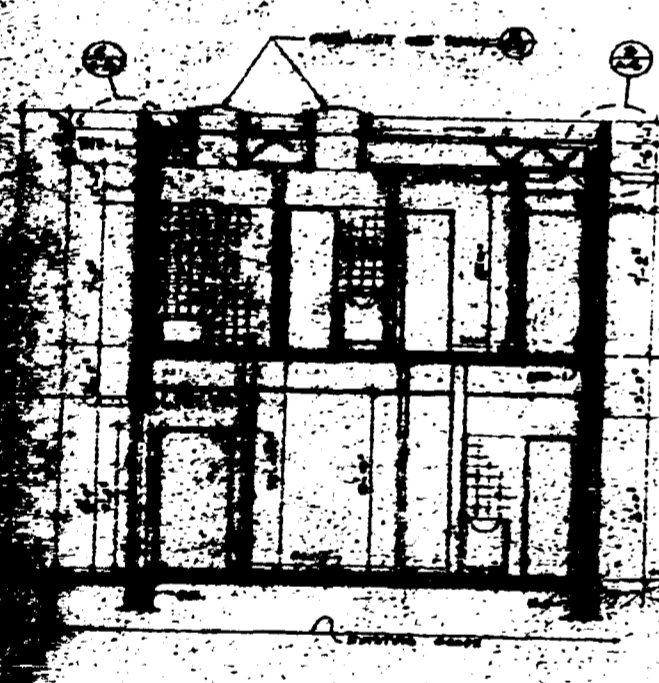

SECTION 2 (1/4" = 1'-0")

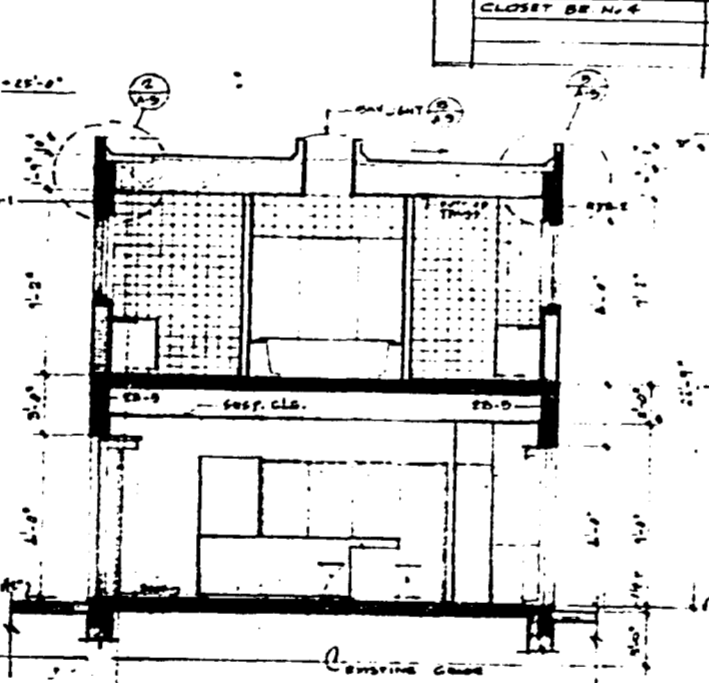

SECTION 3 (1/4" = 1'-0")

ROOM NAME	FLOOR	WALL	BASE	CEILING	GLASS	REMARKS
KITCHEN	1ST	DRYWALL	WOOD	DRYWALL	GLASS	
DINING ROOM	1ST	DRYWALL	WOOD	DRYWALL	GLASS	
HALL TO GUEST ROOM	1ST	DRYWALL	WOOD	DRYWALL	GLASS	
LAUNDRY	1ST	DRYWALL	WOOD	DRYWALL	GLASS	
GUEST ROOM	1ST	DRYWALL	WOOD	DRYWALL	GLASS	
1ST BATH CLOSET	1ST	DRYWALL	WOOD	DRYWALL	GLASS	
BATH ROOM N.1	1ST	DRYWALL	WOOD	DRYWALL	GLASS	
BATH ROOM	1ST	DRYWALL	WOOD	DRYWALL	GLASS	
LIVING ROOM	1ST	DRYWALL	WOOD	DRYWALL	GLASS	
FAMILY ROOM	1ST	DRYWALL	WOOD	DRYWALL	GLASS	
STAIR N.1	1ST	DRYWALL	WOOD	DRYWALL	GLASS	
HALL	1ST	DRYWALL	WOOD	DRYWALL	GLASS	
BREAKFAST AREA	1ST	DRYWALL	WOOD	DRYWALL	GLASS	
HALL TO LIBRARY	1ST	DRYWALL	WOOD	DRYWALL	GLASS	
LIBRARY	1ST	DRYWALL	WOOD	DRYWALL	GLASS	
BATH N.1	1ST	DRYWALL	WOOD	DRYWALL	GLASS	
LIBRARY CLOSET	1ST	DRYWALL	WOOD	DRYWALL	GLASS	
STAIR N.1	1ST	DRYWALL	WOOD	DRYWALL	GLASS	
HALL TO DECK	1ST	DRYWALL	WOOD	DRYWALL	GLASS	
LINEN CLOSET	1ST	DRYWALL	WOOD	DRYWALL	GLASS	
HALL TO BR. N.1 & N.2	1ST	DRYWALL	WOOD	DRYWALL	GLASS	
BEDROOM N.1 & CLO.	1ST	DRYWALL	WOOD	DRYWALL	GLASS	
BATH N.2	1ST	DRYWALL	WOOD	DRYWALL	GLASS	
BEDROOM N.2	1ST	DRYWALL	WOOD	DRYWALL	GLASS	
BEDROOM N.2 CLOSET	1ST	DRYWALL	WOOD	DRYWALL	GLASS	
MASTER BEDROOM	1ST	DRYWALL	WOOD	DRYWALL	GLASS	
HALL TO BR. N.1 & N.2	1ST	DRYWALL	WOOD	DRYWALL	GLASS	
HER CLOSET	1ST	DRYWALL	WOOD	DRYWALL	GLASS	
HIS CLOSET	1ST	DRYWALL	WOOD	DRYWALL	GLASS	
HER BATHROOM	1ST	DRYWALL	WOOD	DRYWALL	GLASS	
HIS BATHROOM	1ST	DRYWALL	WOOD	DRYWALL	GLASS	
SHOWER	1ST	DRYWALL	WOOD	DRYWALL	GLASS	
BEDROOM TO MASTER BR.	1ST	DRYWALL	WOOD	DRYWALL	GLASS	
HALL TO BR. N.1 & N.2	1ST	DRYWALL	WOOD	DRYWALL	GLASS	
BATH N.1	1ST	DRYWALL	WOOD	DRYWALL	GLASS	
BEDROOM N.1 & CLO.	1ST	DRYWALL	WOOD	DRYWALL	GLASS	
BEDROOM N.2	1ST	DRYWALL	WOOD	DRYWALL	GLASS	
CLOSET BR. N.1	1ST	DRYWALL	WOOD	DRYWALL	GLASS	

Henry B. Konover A.I.A.
 Henry B. Konover Architects & Planners, P.A.
 4014 Chase Ave., Miami Beach, Florida 33140 (305) 673-0950

DRS. SMITH RESIDENCE
 4-2-4 DELXDO DRIVE
 BEACH, FLORIDA

OFFICE COPY
 CITY OF MIAMI
 APPROVED FOR PERMIT BY
 THE FORMER
 DIVISION
 ENGINEER


SECTION 2
 ROOM FINISH SCHEDULE

DATE: 11-27-77
 DRAWN BY: H.B.K.
 CHECKED BY: H.B.K.
 COMM. NO. A-9
 SHEET 1 OF 15


500000-95

0005-1


GROUND FLOOR:
BATHROOM N°1

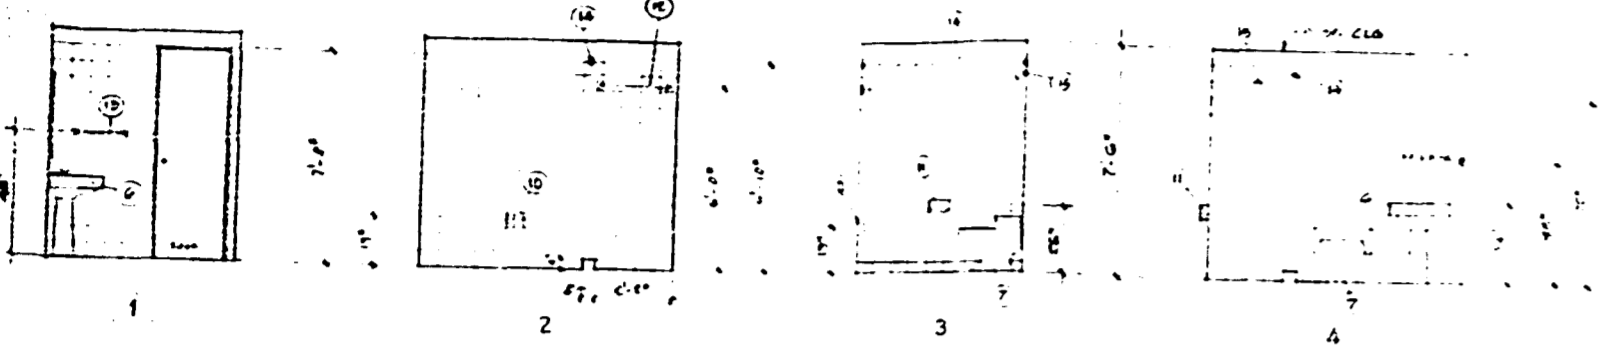


BATHROOM N°2
3/6'-0"

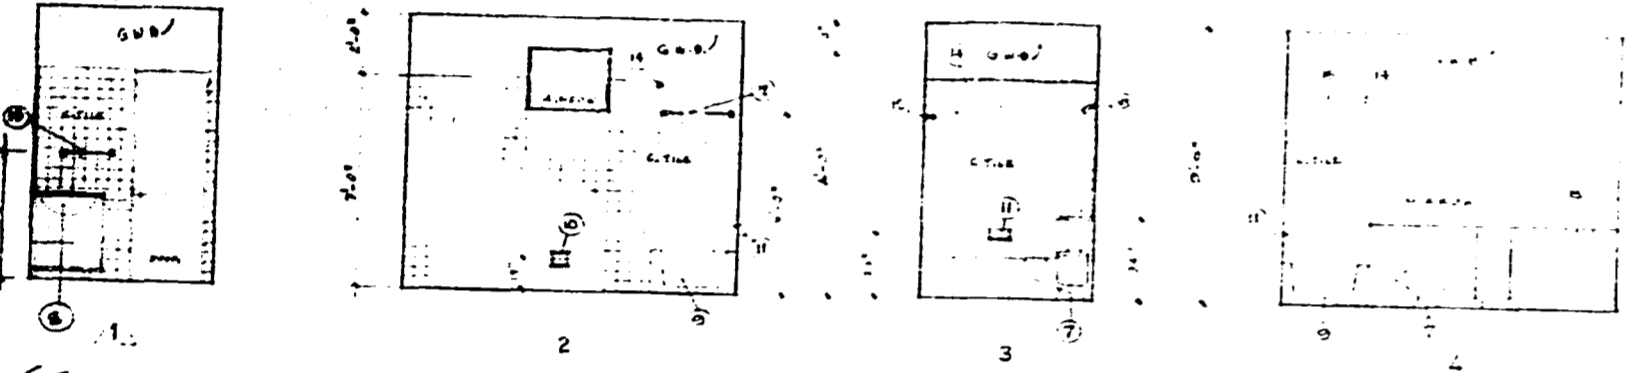

SECOND FLOOR
BATHROOM N°3
3/6'-0"

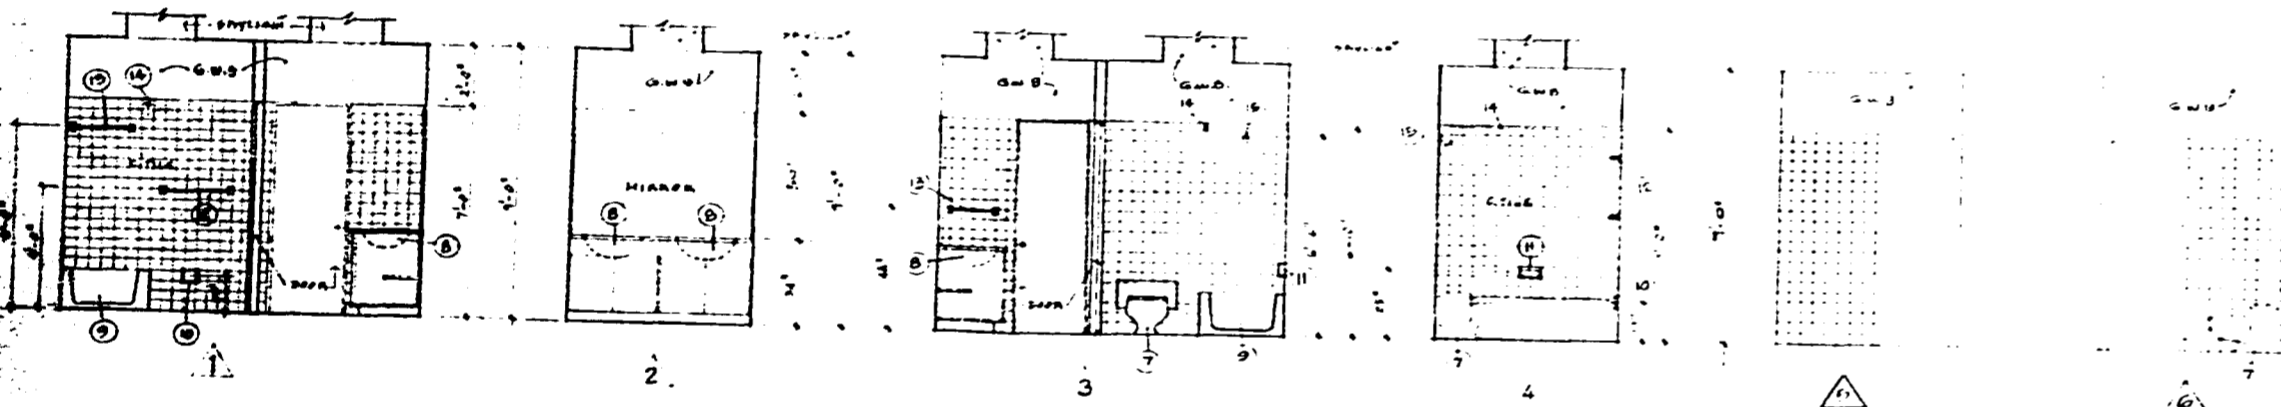

BATHROOM N°4
3/6'-0"

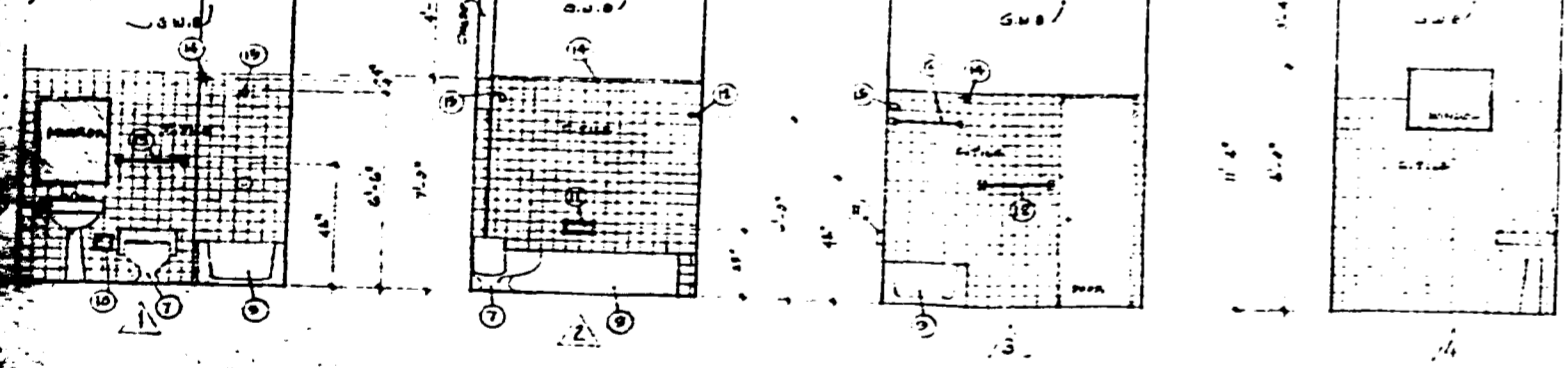

ENTRANCE FINISH AND ACCESSORY SCHEDULE

1	TOILET	PERMANENT WHITE ENAMEL
2	WICES	ENAMELED METAL TRAY
3	WASHBASIN	PERMANENT WHITE ENAMEL
4	WASHBASIN	PERMANENT WHITE ENAMEL
5	WASHBASIN	PERMANENT WHITE ENAMEL
6	WASHBASIN	PERMANENT WHITE ENAMEL
7	TOILET	PERMANENT WHITE ENAMEL
8	WASHBASIN	PERMANENT WHITE ENAMEL
9	WASHBASIN	PERMANENT WHITE ENAMEL
10	WASHBASIN	PERMANENT WHITE ENAMEL
11	WASHBASIN	PERMANENT WHITE ENAMEL
12	WASHBASIN	PERMANENT WHITE ENAMEL
13	WASHBASIN	PERMANENT WHITE ENAMEL
14	WASHBASIN	PERMANENT WHITE ENAMEL
15	WASHBASIN	PERMANENT WHITE ENAMEL
16	WASHBASIN	PERMANENT WHITE ENAMEL

NOTE: ALL CABINETS SHALL BE PLASTIC LAMINATED FINISH

OFFICE OF THE CITY ENGINEER
CITY OF MIAMI
APPROVED FOR THE RECORDS

Henry B. Konover A.I.A.
Henry B. Konover Architects & Planners, P.A.
4014 Chase Ave, Miami Beach, Florida 33140 (305) 675-0950

DR. SMITH RESIDENCE
24 DILLIDO DRIVE
MIAMI BEACH, FLORIDA

ELEVATIONS OF
BATHROOMS N°1, N°2, N°3, N°4
3/6'-0", BUREAU OF PUBLIC WORKS
MIAMI BEACH, FLORIDA



DATE: 11-27-59
DRAWN: V.M.
CHECK: J.A.

COMM 9001
A-10
SHT. 10 OF 16

500000-95

0005-1-2

MASTER BATHROOMS

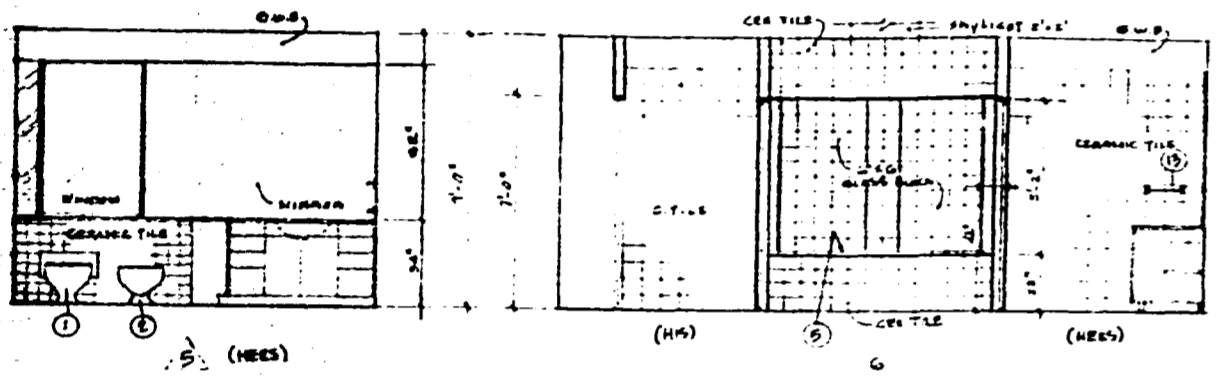
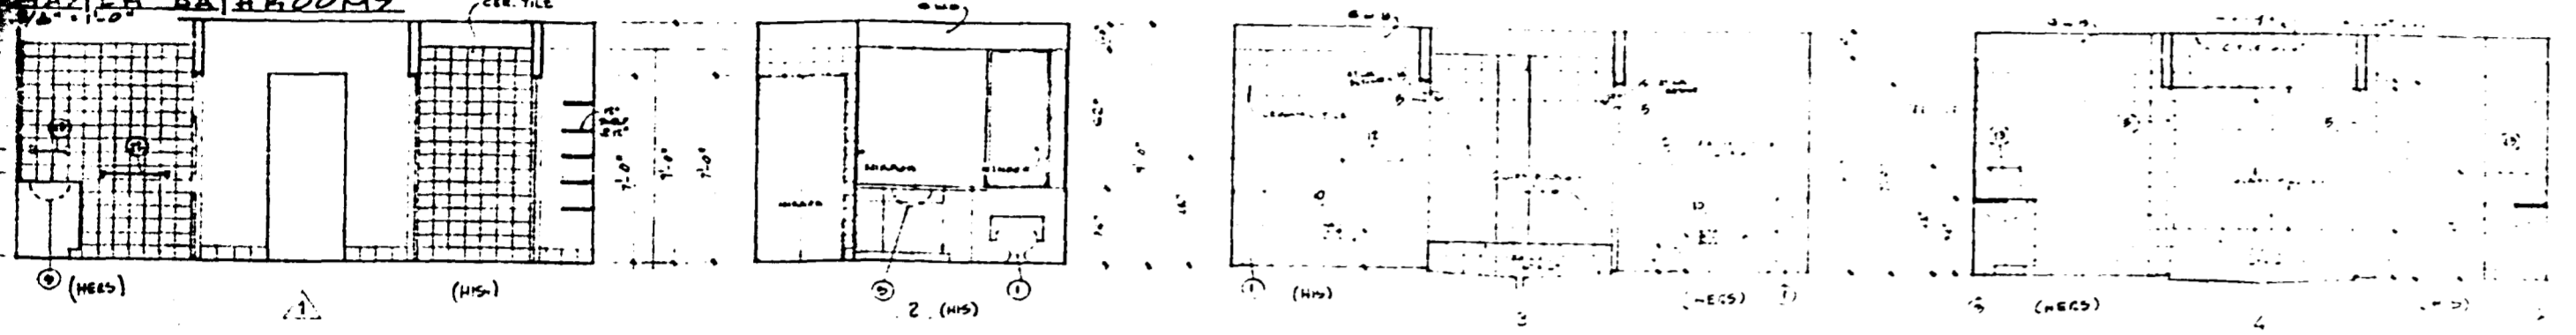


OFFICIAL COPY
CITY OF MIAMI BEACH
APPROVED FOR PERMIT BY
THE CITY ENGINEER
[Signature]

KITCHEN & UTILITY EQUIPMENT & ACCESSORY SCHEDULE

NO.	DESCRIPTION	MANUFACTURER NAME AND MODEL	REMARKS
1	REF. CUPB'D	N.T.C.	
2	FRIDGE	N.T.C.	
3	COUNTER	N.T.C.	
4	DISHWASHER	N.T.C.	
5	GARBAGE DISPOSAL	N.T.C.	
6	TRASH COMPACTOR	N.T.C.	
7	SINK	N.T.C.	
8	SINK	N.T.C.	
9	DOUBLE OVEN	N.T.C.	
10	WASHER	N.T.C.	
11	DRYER	N.T.C.	
12	PLASTIC LAMINATED TOPS		FOR COUNTER TOPS

KITCHEN ELEVATIONS & DETAILS

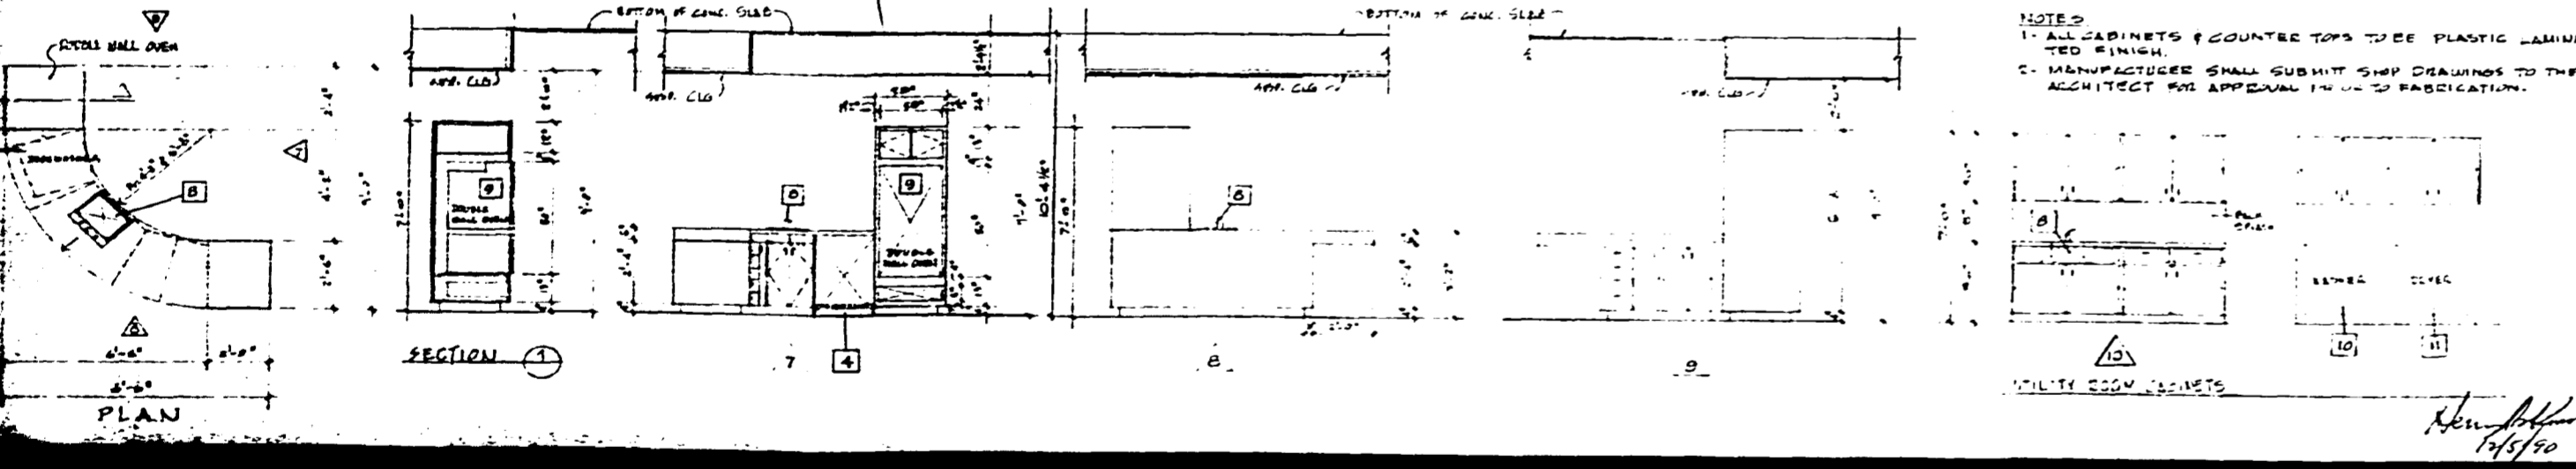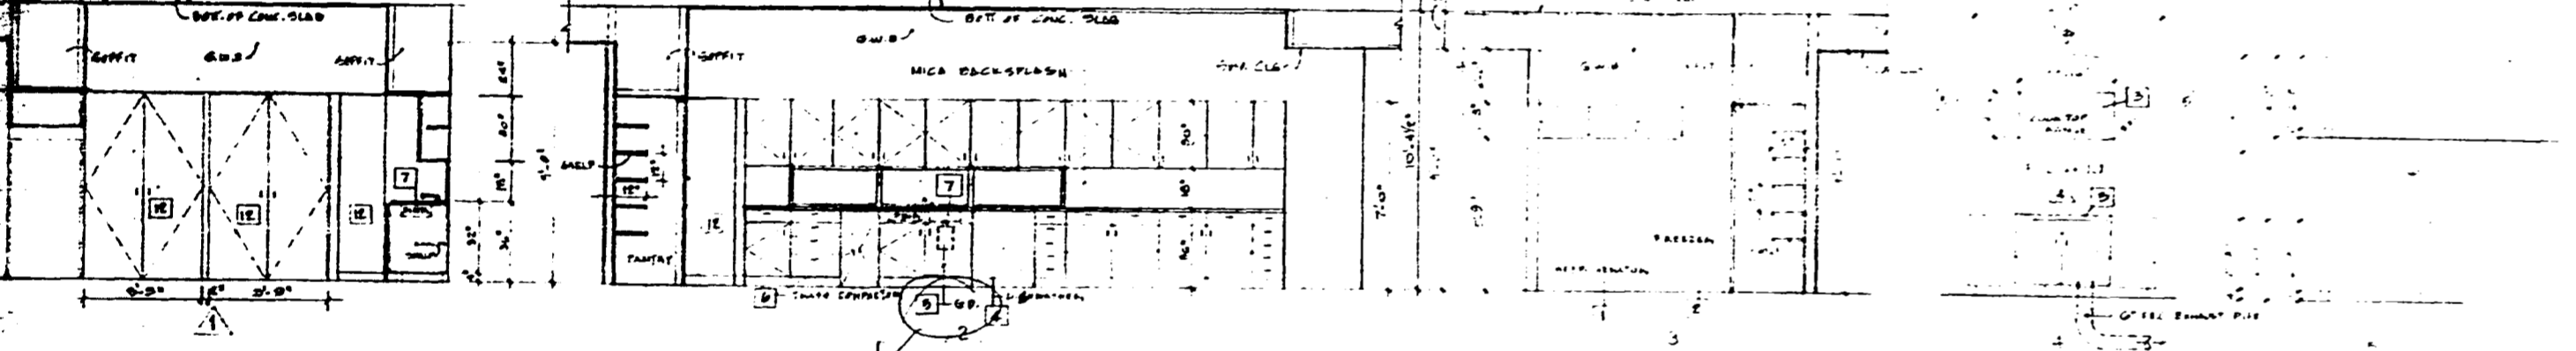

Henry B. Konover A.I.A.
Henry B. Konover Architects & Planners P.A.
4014 Chase Ave., Miami Beach, Florida 33140 (305) 673-0900


MR. & MRS. SMITH RESIDENCE
424 BILIBO DRIVE
MIAMI BEACH, FLORIDA

MASTER BATHROOMS AND
KITCHEN ELEVATIONS
9/6/70 - H.B.K. ARCHT. EXP. 10/10/70

DATE: 10/21/70
DRAWN BY: H.B.K.
CHECKED BY: H.B.K.
COMM. 2002
A-11
SHT. 11 OF 16

500000-99B

00513

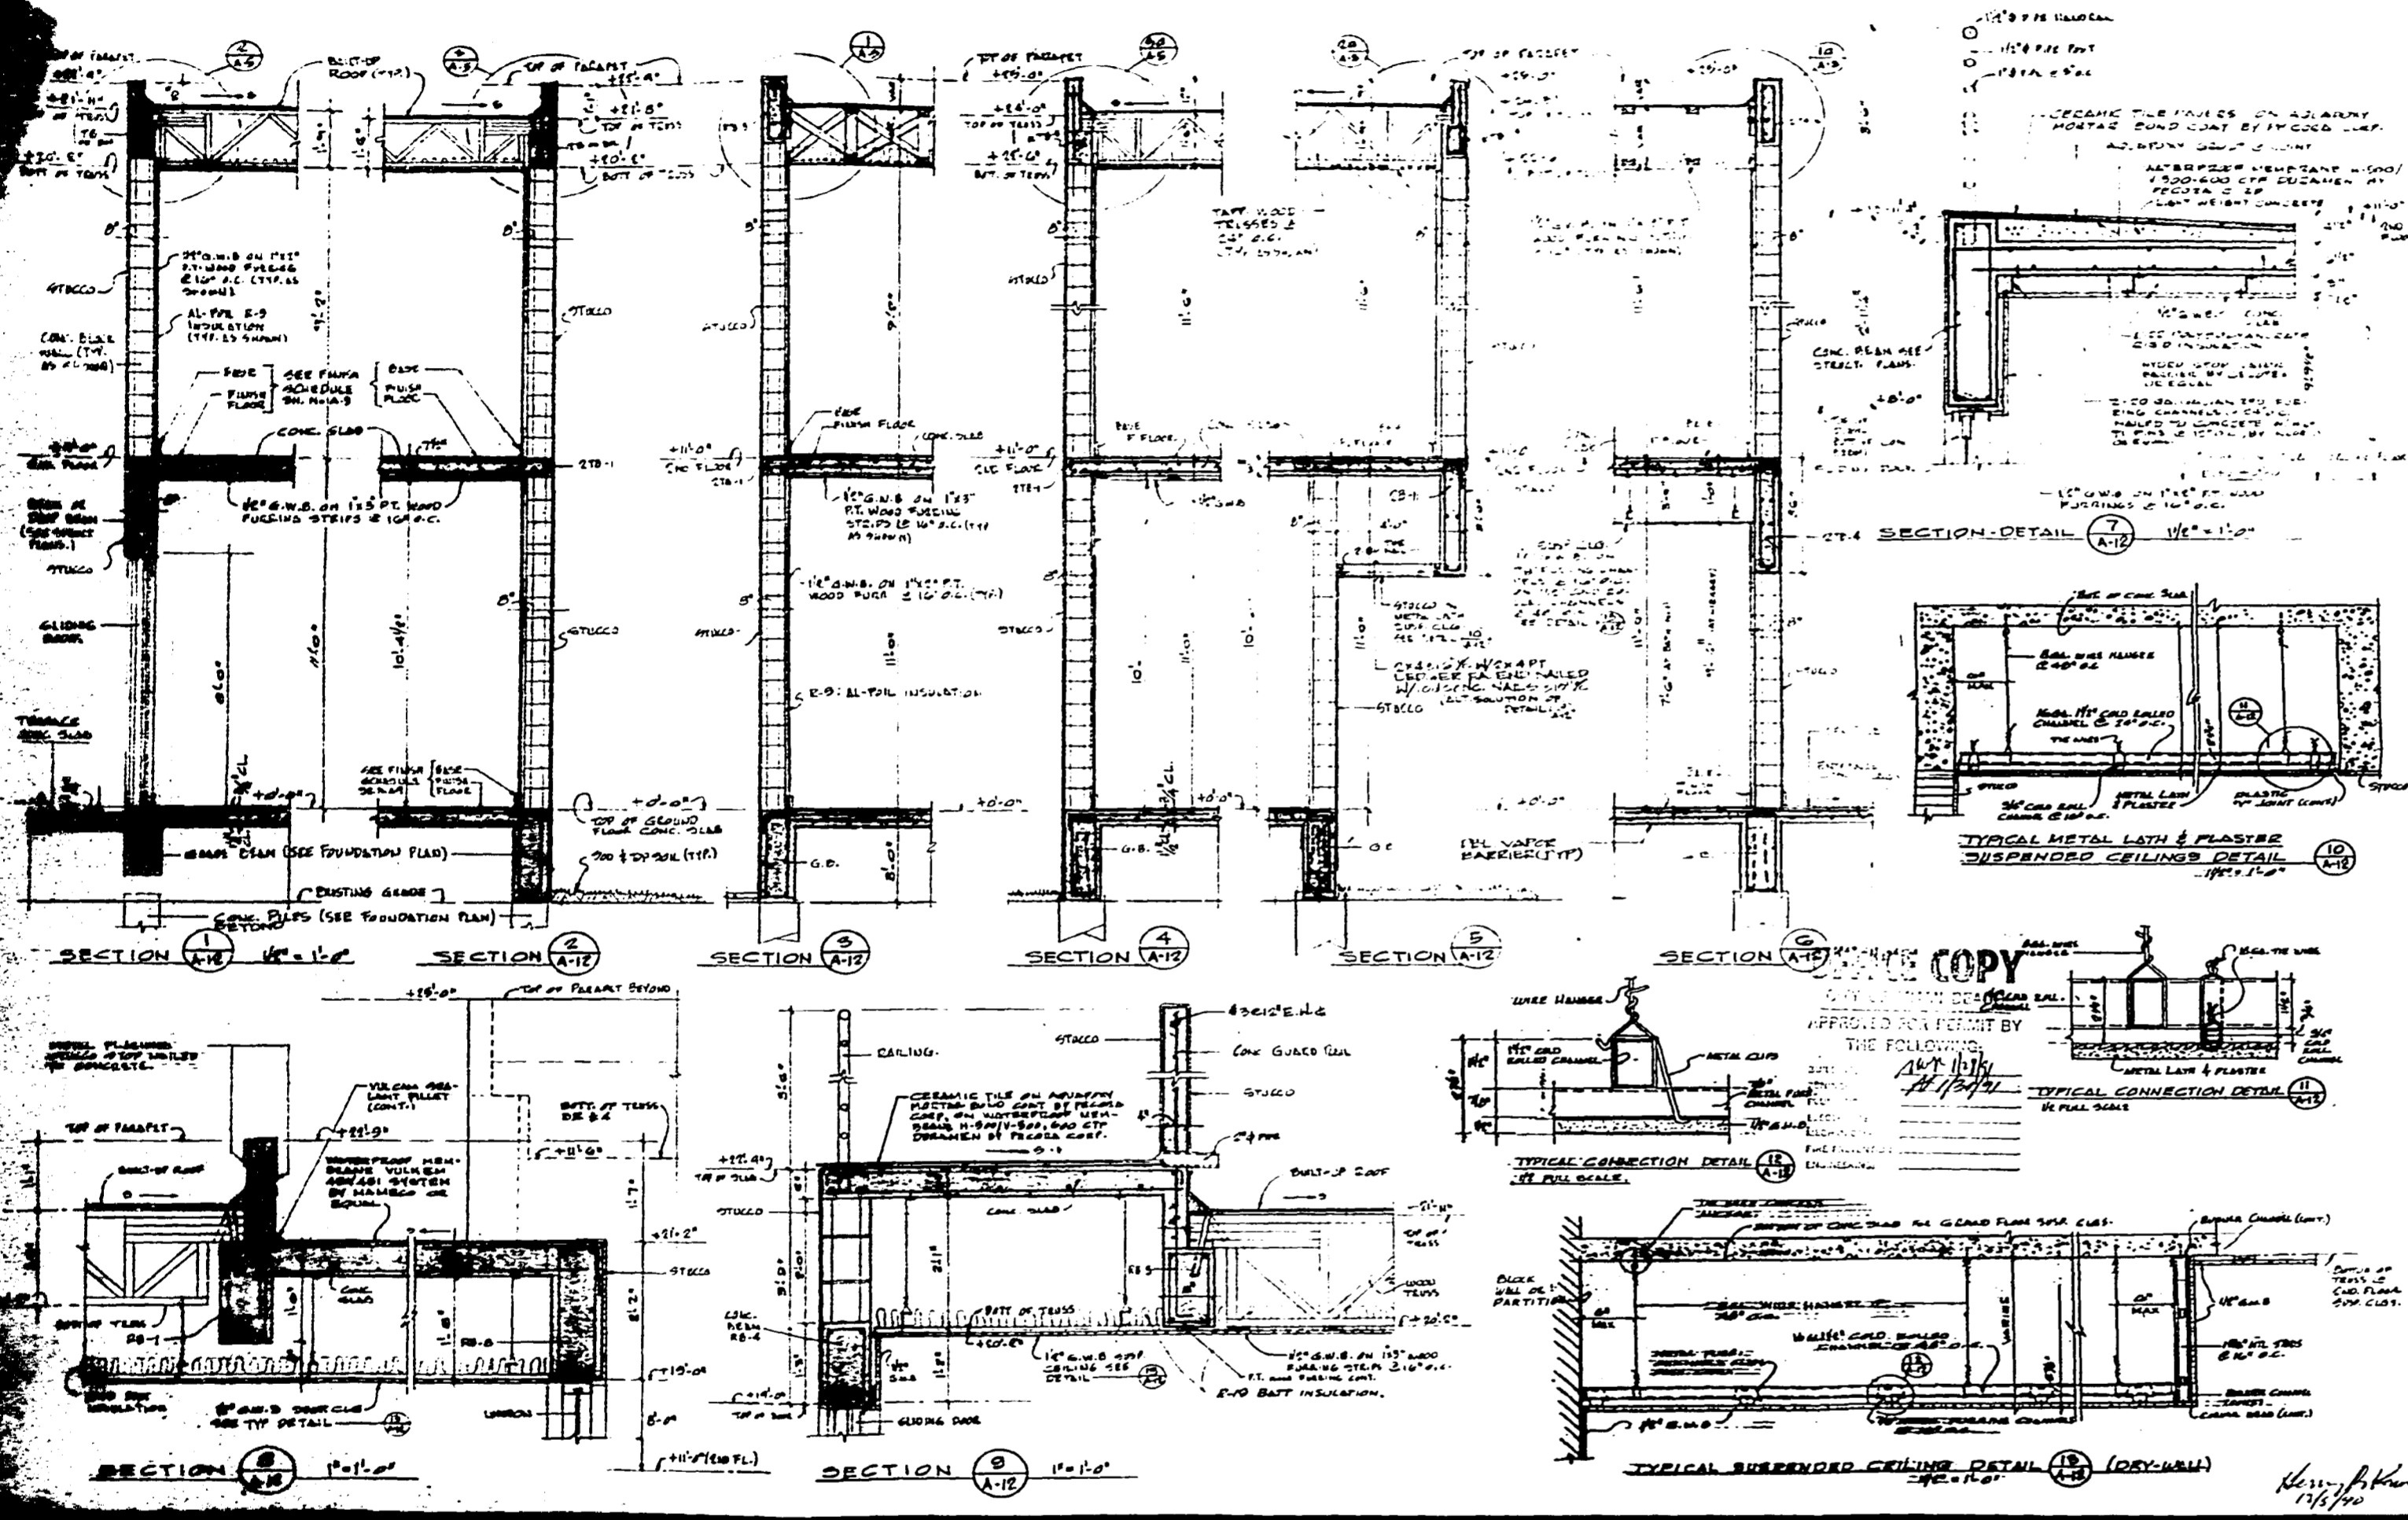

Henry B. Konover A.I.A.
 Henry B. Konover Architects & Planners P.A.
 4014 Chase Ave., Miami Beach, Florida 33140 (305) 673 0560

DRS. SMITH RESIDENCE
 424 DELIDO DRIVE
 MIAMI BEACH, FLORIDA


WALL SECTIONS DETAILS
 SUSPENDED CEILING DETAILS

DATE: 11-27-50
 DRAWN BY: H.B.K.
 CHECK BY: H.B.K.

COMM 9008
 A-12
 SHT. 12 OF 14

5000000-99B

000514

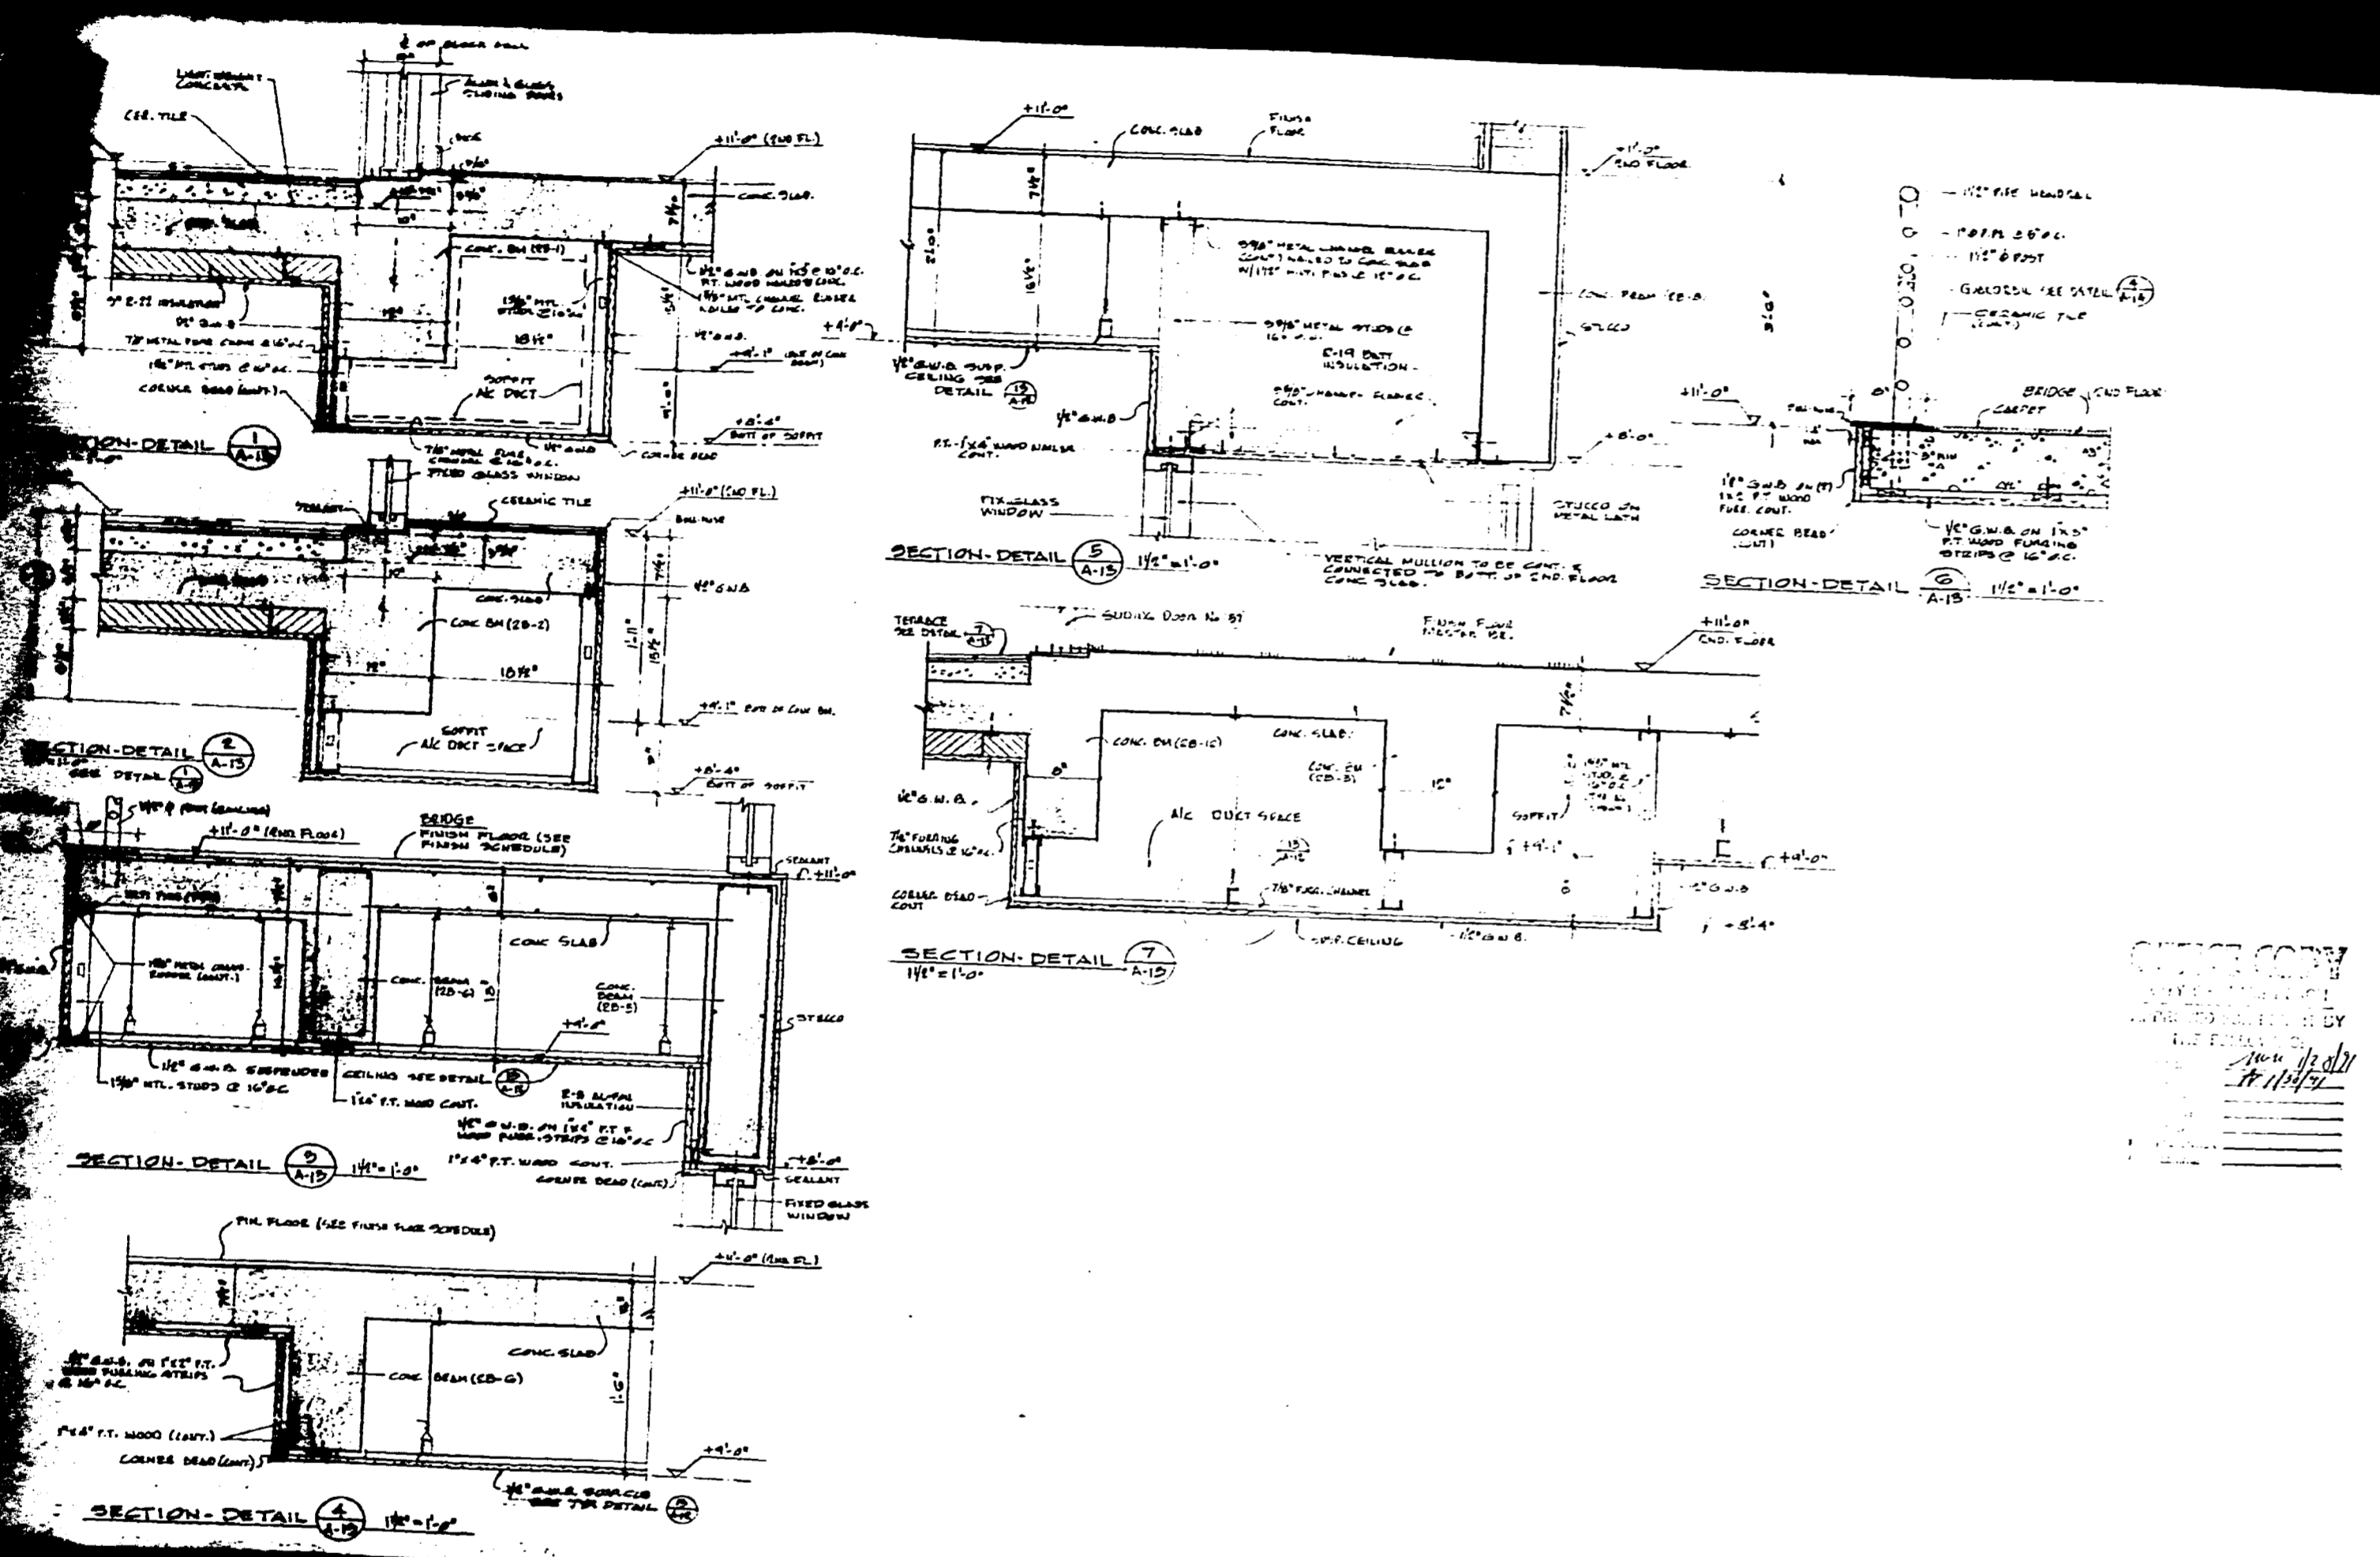

Henry B. Konover A.I.A.
 Henry B. Konover Architects & Planners, P.A.
 4014 Chase Ave., Miami Beach, Florida 33140 1301 873 0960

DRB - SMITH RESIDENCE
 424 DELIDO DRIVE
 MIAMI BEACH, FLORIDA

SECTION-DETAILS


DATE: 11-21-94
 DRAWN: A.L.
 CHECK: H.B.
 REV.

COMM 9002
A-13
 SHT. 13 OF 16


ORIGINAL COPY
 BY: [Signature]
 DATE: 11/21/94

500000-9B


000515

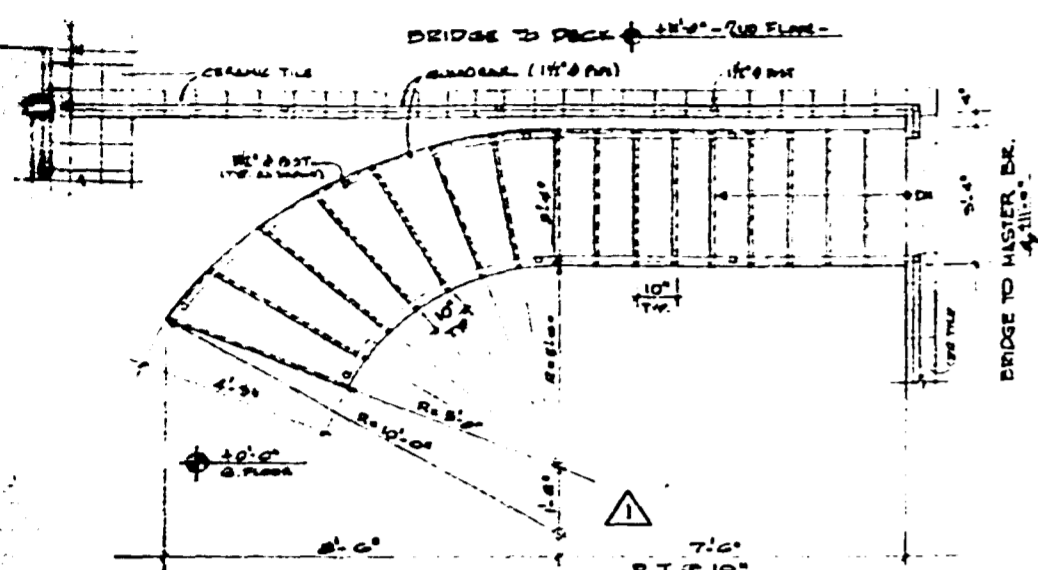


STAIR N.1 PLAN - DETAIL 1
A-14 1/2" = 1'-0"

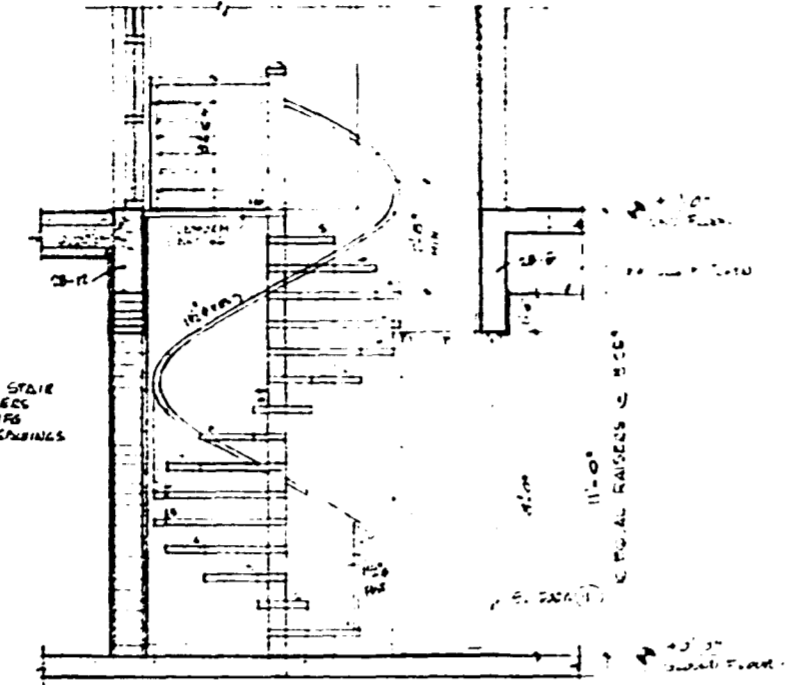


SECTION B-B 1/2" = 1'-0"

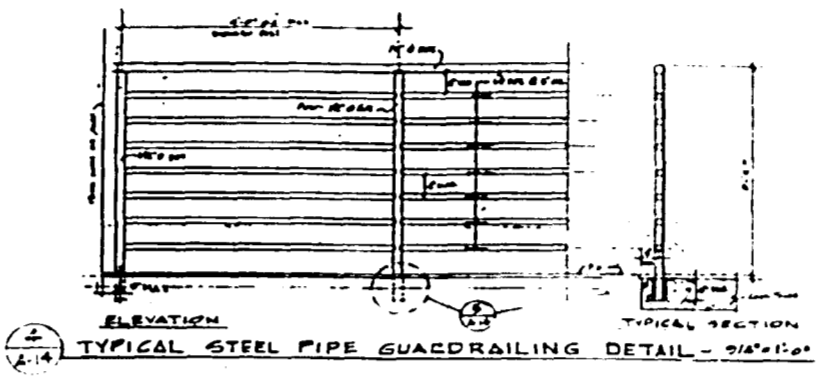


TYPICAL STEEL PIPE GUARDRAILING DETAIL - 2 1/2" DIA.

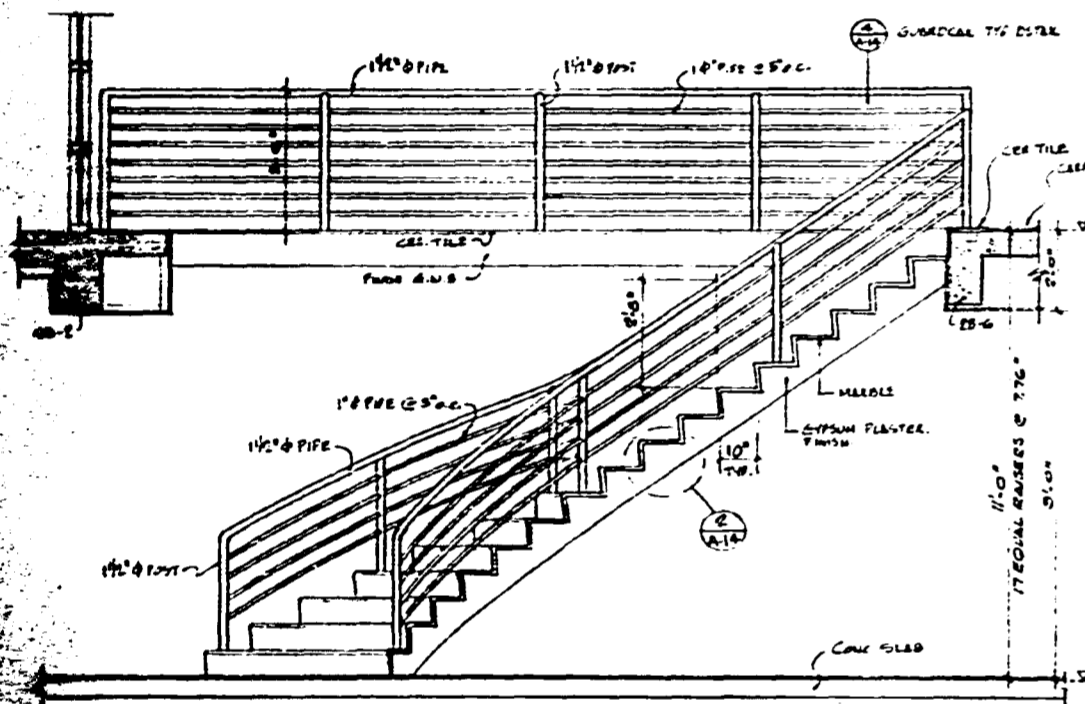


ELEVATION 1/2" = 1'-0"

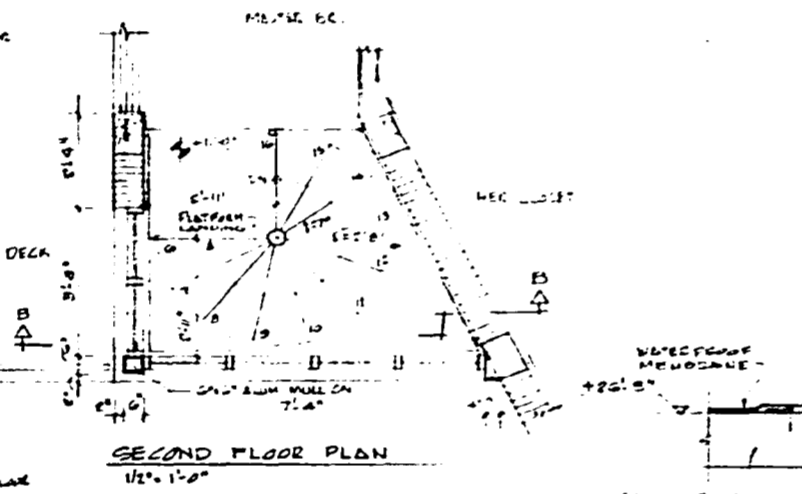


SECOND FLOOR PLAN 1/2" = 1'-0"

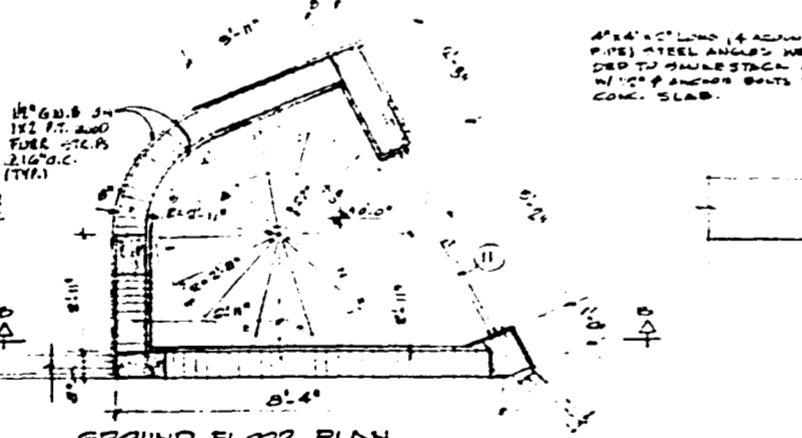


GROUND FLOOR PLAN
STAIR N.2 (SPIRAL) DETAIL 3
A-14 1/2" = 1'-0"

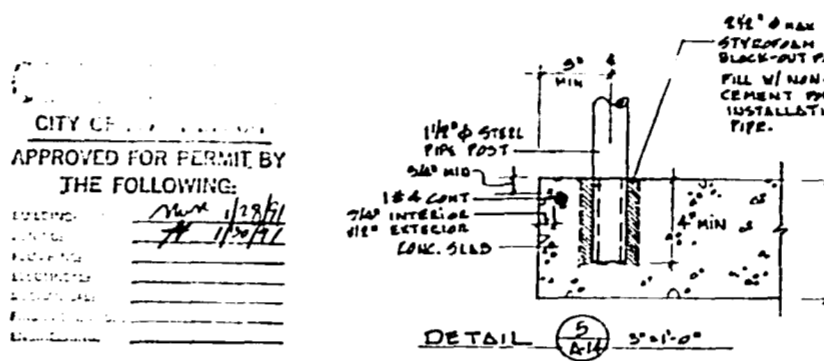


DETAIL 5 1/2" = 1'-0"

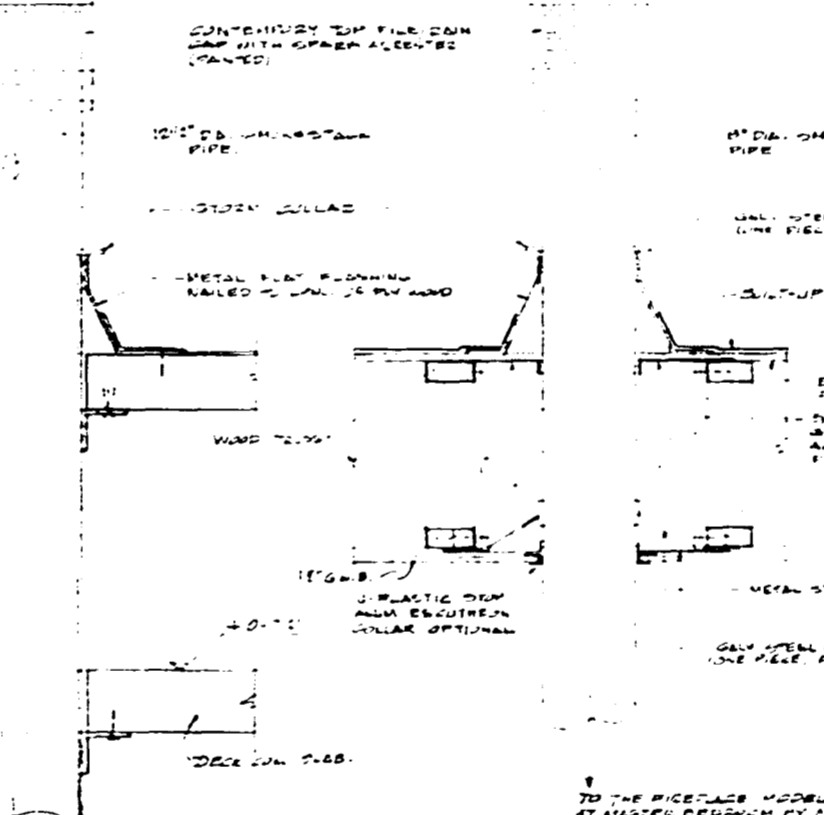

DETAIL 6 1/2" = 1'-0"

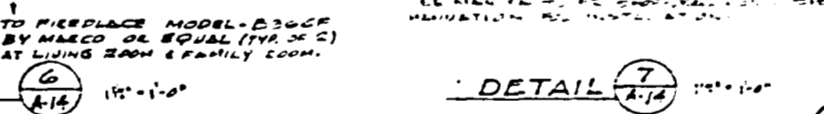

DETAIL 7 1/2" = 1'-0"

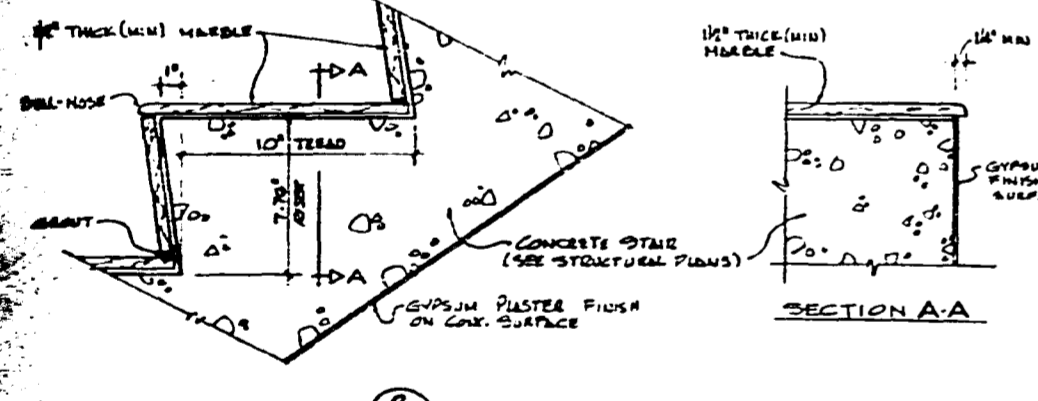

SECTION - DETAIL 2
A-14 5" = 1'-0"

CITY OF MIAMI
APPROVED FOR PERMIT BY
THE FOLLOWING:
DATE: 11/15/00
BY: [Signature]

Henry B. Konover A.I.A.
Henry B. Konover Architects & Planners, P.A.
4014 Chase Ave., Miami Beach, Florida 33140 (305) 673-0890

DR. J. SMITH RESIDENCE
424 DELILLO DRIVE
MIAMI BEACH, FLORIDA

STAIR N.1 & STAIR N.2 DETAILS,
GUARDRAILING TYPICAL DETAIL,
CHIMNEY DETAILS.

DATE: 11-27-00
DRAWN BY: [Signature]
CHECK BY: [Signature]

COMM 9002
A-14
SHT. 14 OF 16


500000-99B

000516



WINDOW SCHEDULE				
MARK	CODE	OVERALL SIZE WIDTH X HEIGHT	TYPE	FLRA
1		20 1/2" x 26 1/2"	CASEMENT	GF
2	OX 4040	4'-0" x 4'-0"	HORIZONTAL ROLLING SERIES 8 SIO	GF
3	OKK	1'-0" x 9'-0"	HORIZONTAL ROLLING	GF
4				
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NOTE: ALL EXTERIOR DOORS & WINDOWS SHALL COMPLY WITH CHAPTER 5-6 OF THE DADE COUNTY CODE FOR BURGLARY & INTRUSION.


WINDOWS TYPES ELEVATIONS.

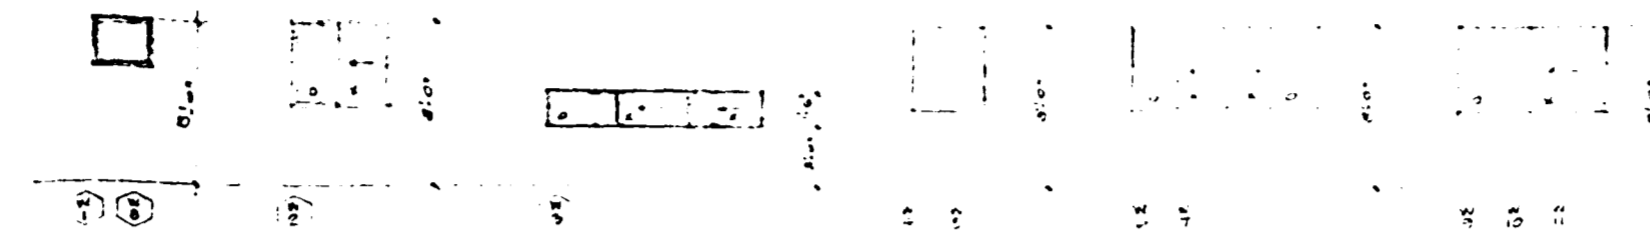



FIXED GLASS WINDOWS TYPES ELEVATIONS.

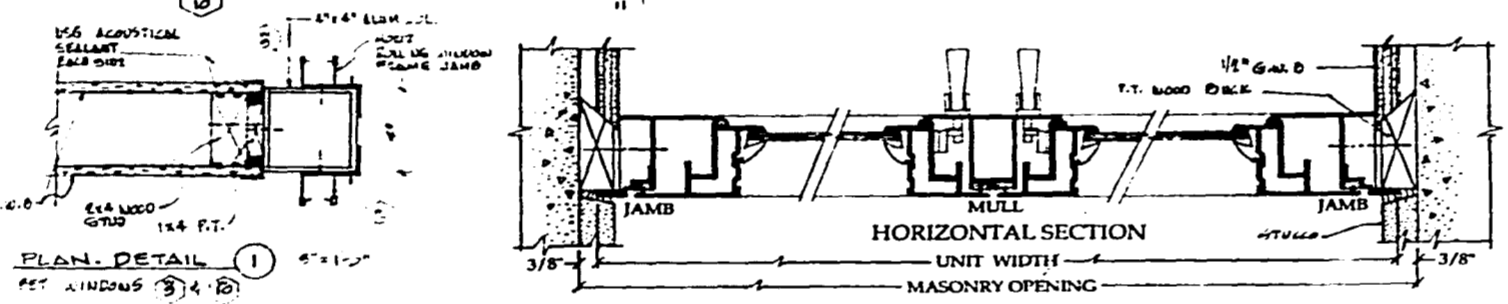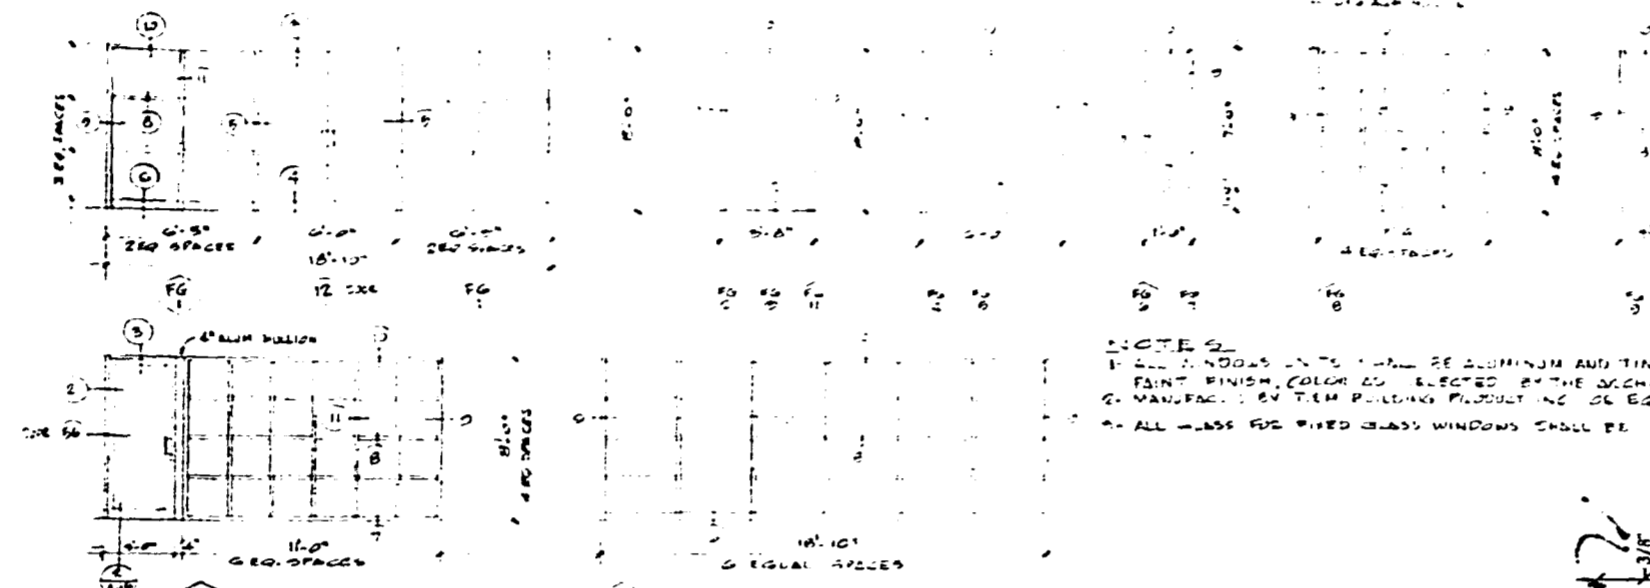

FIXED GLASS WINDOWS ALUM FRAMES SECTIONS DETAILS.

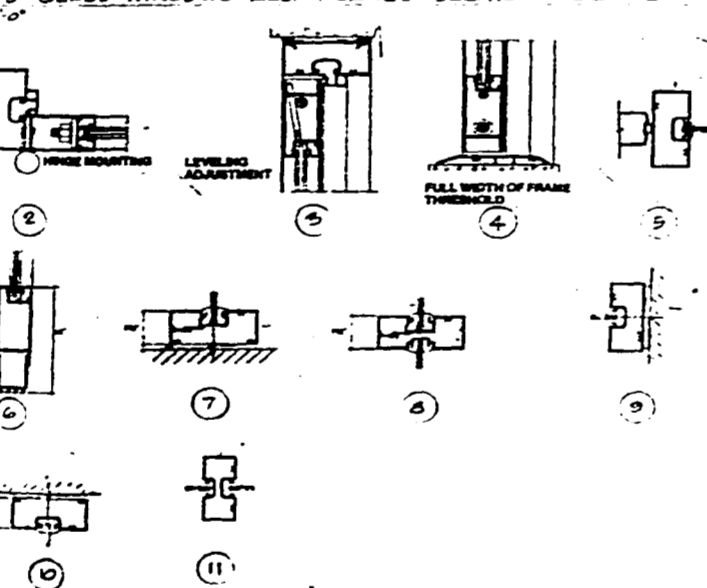

HORIZONTAL ROLLING WINDOW

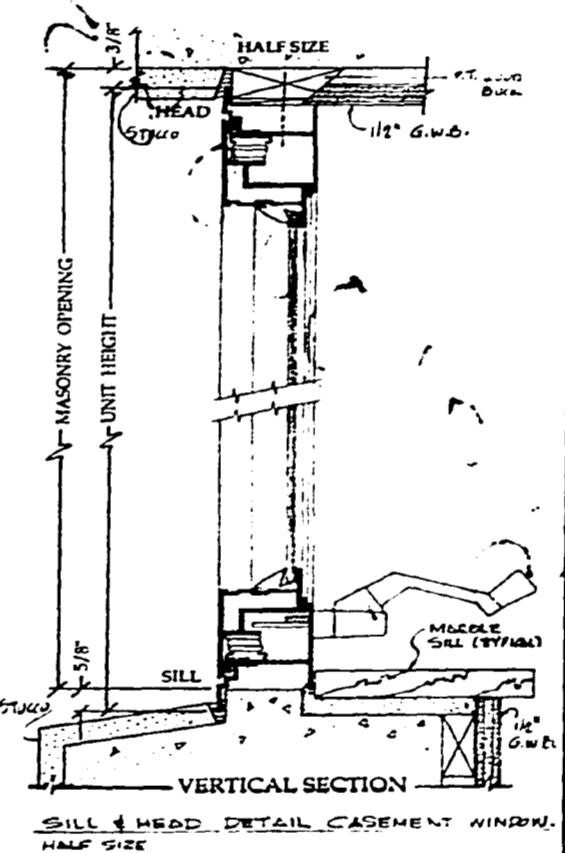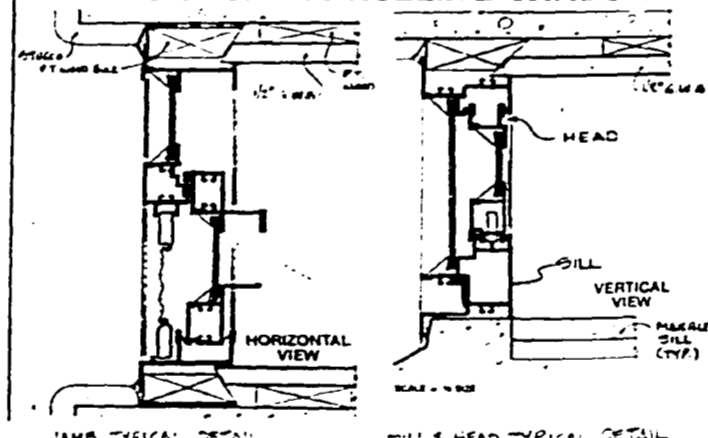

OFFICE COPY

PERMIT BY
DATE

Henry B. Konover A.I.A.

Henry B. Konover Architects & Planners P.A.
4013 Chase Ave., Miami Beach, Florida 33140 (305) 673 0950


DRB - SHIRAZI RESIDENCE
424 BELLEVOUE DRIVE
MIAMI BEACH, FLORIDA

WINDOW SCHEDULE, WINDOWS &
FIXED GLASS WINDOWS TYPES
ELEVATIONS, SECTIONS DETAIL OF
FRAMES & NOTES.

DATE: 11/17/90
DRAWN BY: [Signature]
REV: [Signature]

COMM 9002
A-16
SHT. 16 OF 19

500000918

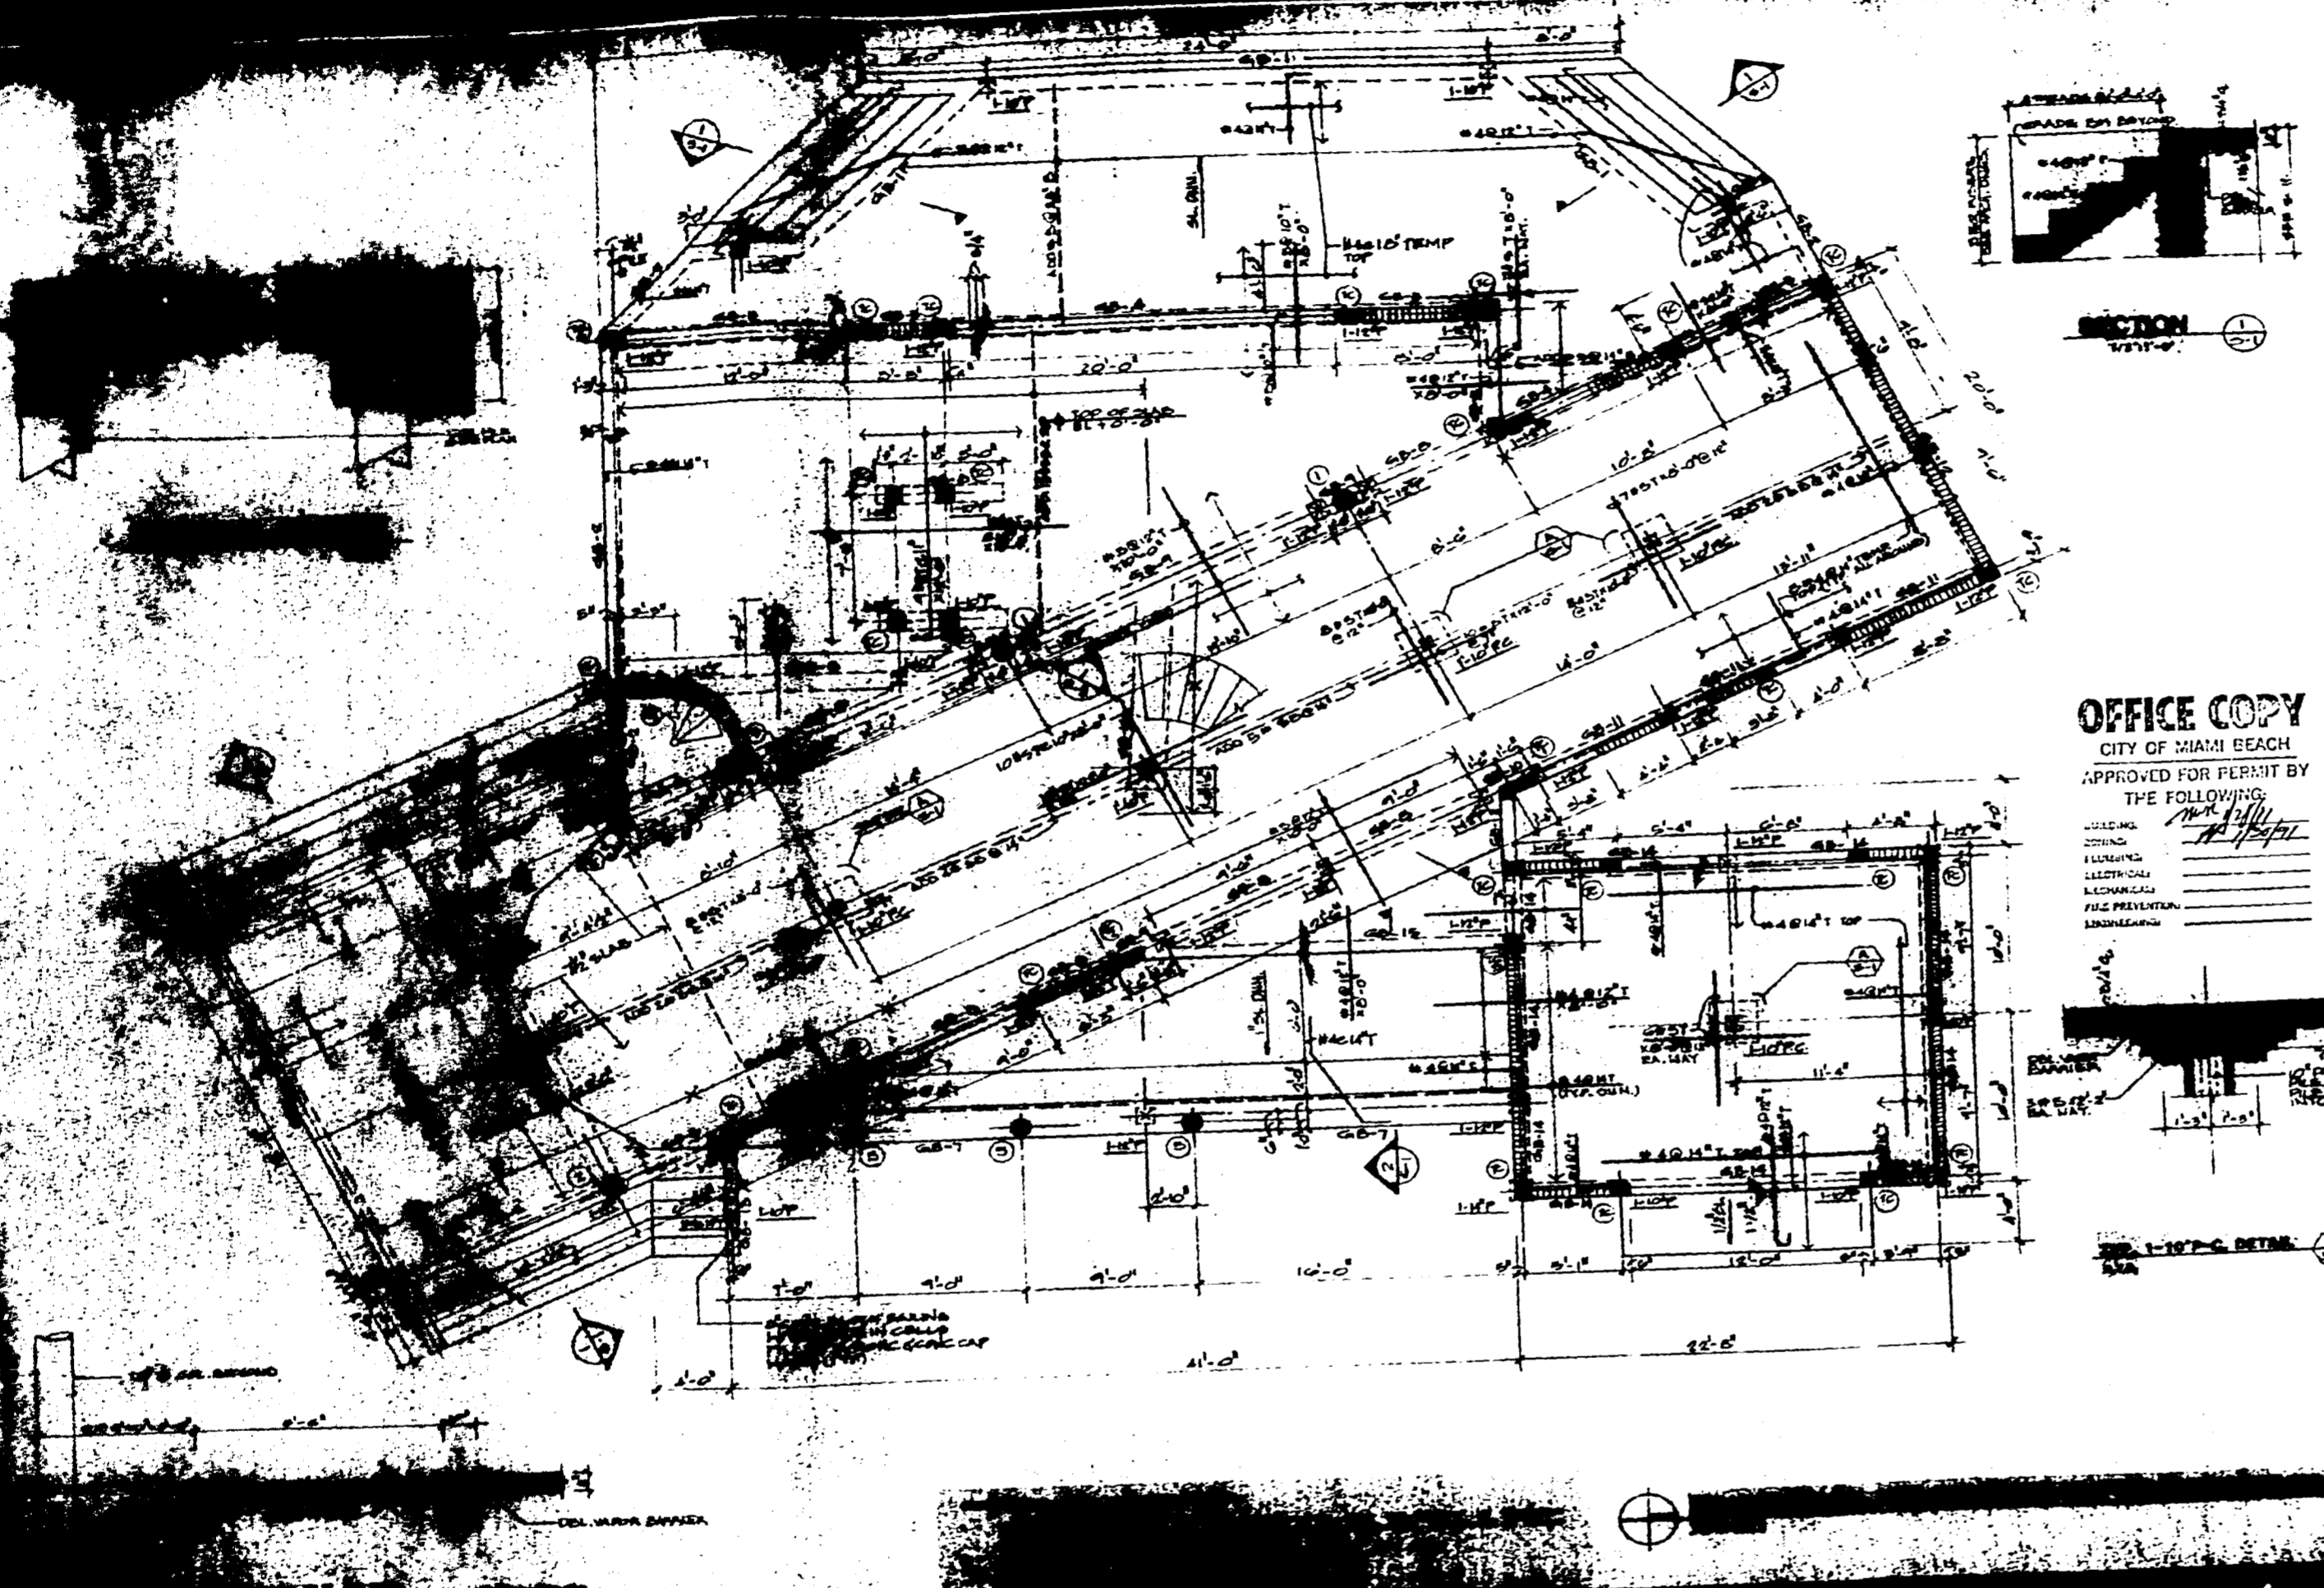

OFFICE COPY
 CITY OF MIAMI BEACH
 APPROVED FOR PERMIT BY
 THE FOLLOWING:

MECHANICAL _____
 ELECTRICAL _____
 FIRE PREVENTION _____
 ENGINEERING _____


Henry B. Konover A.I.A.

Henry B. Konover Architects & Planners P.A.
 401 Chase Ave. Miami Beach, Florida 33139

FOUNDATION & GROUND FLOOR PLAN
 SECTIONS, DETAILS & GENERAL PLANS NOTES

500000-9B

000519

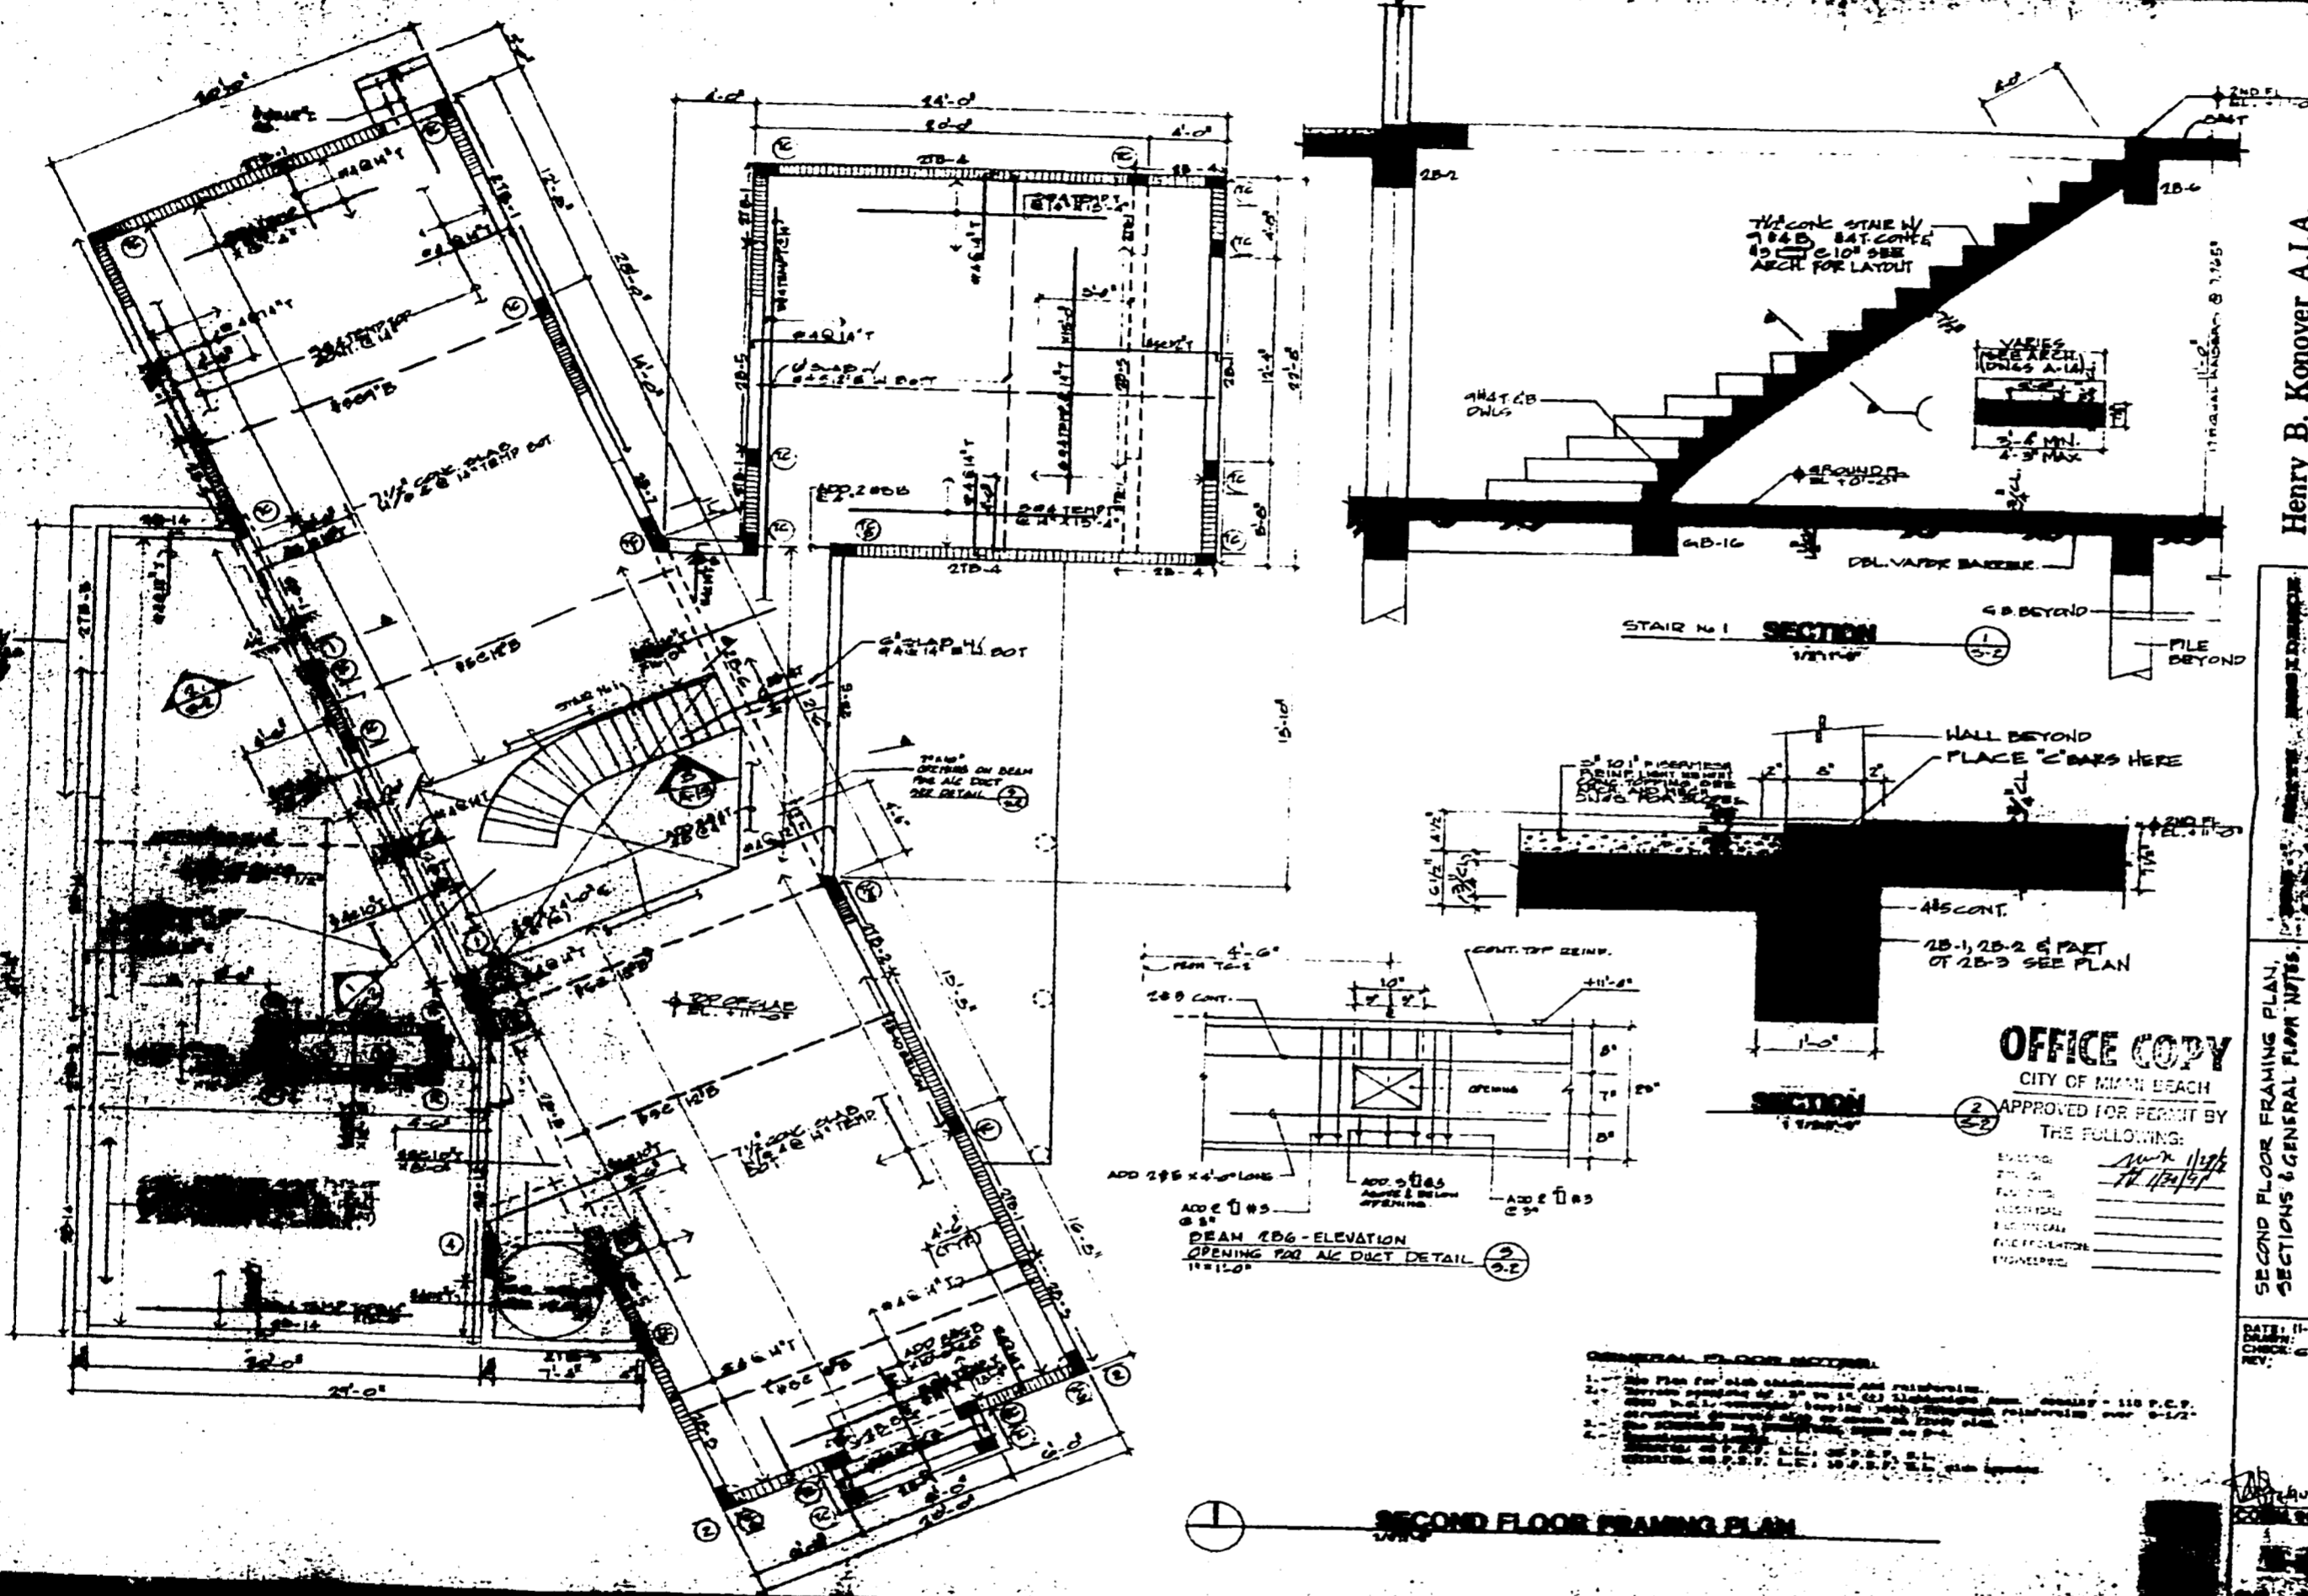

Henry B. Kover A.I.A.

Henry B. Kover Architects & Planners P.A.
4014 Chase Ave. Miami Beach, Florida 33140

OFFICE COPY
CITY OF MIAMI BEACH
APPROVED FOR PERMIT BY
THE FOLLOWING:

DATE: 7/1/57
BY: [Signature]

SECOND FLOOR FRAMING PLAN

500000-90
 000520

Building Department
 1700 Convention Ctr Drive, 2nd Floor
 Miami Beach, Florida 33139
 Inspections: (305) 673-7370
 Office: (305) 673-7610

Building Misc Fees

11-10-2009

Activity Number: BMS1000339

Status: APPROVED

Issued By: BUILARAG

Site Address: 424 W DILIDO DR MBCH
 Parcel #: 32320110280

Applied: 10/30/2009
 Approved: 11/10/2009

Valuation: \$0.00

Applicant: BMS CONSTRUCTION CORPORATION
 CLARENCE E. SMITH & W CAMILLE
 8460 TAFT ST
 HOLLYWOOD, FL 33024

Property Owner:
 424 WEST DILIDO DR
 MIAMI BEACH FL 331391164

Description: REVISION TO B1000129- NEW SKY LIGHTS 4 total
 Inspector Area: S Class Code:

DETAIL LIST

Miscellaneous Fees

Microfilm Copies - Per # of:	0	\$0.00
Photostatic Copies - Per # of:	0	\$0.00
Fax Transmittal Pages - Per # of:	0	\$0.00
Special Project Fee:		\$0.00
Occupant Content Certificate - Per # of:	0	\$0.00
Builders Bond:		\$0.00
Certified Copies - Per # of:	0	\$0.00
Flood Zone Determination - Per # of:	0	\$0.00

NSF Check Amounts & Charges

Building Work Permit:	\$0.00	\$0.00
Electrical Work Permit:	\$0.00	\$0.00
Mechanical Work Permit:	\$0.00	\$0.00
Plumbing Work:	\$0.00	\$0.00
Demolition Work Permit:	\$0.00	\$0.00
Certificate of Completion:	\$0.00	\$0.00
Certificate of Occupancy:	\$0.00	\$0.00
Recertification:	\$0.00	\$0.00
Microfilm:	\$0.00	\$0.00
Photostatic Copies:	\$0.00	\$0.00
Miscellaneous Fees:	\$0.00	\$0.00
Bonds:	\$0.00	\$0.00
Fire Safety Fees:	\$0.00	\$0.00
Marine Structures:	\$0.00	\$0.00
Elevator/Escalator Fees:	\$0.00	\$0.00

PAID
 NOV 10 2009
 CITY OF MIAMI BEACH
 BUILDING DEPARTMENT

Conversion Letters

Zoning Conversion Letter - Per # of:	0	\$0.00
Buildig Conversion Letter - Per # of:	0	\$0.00

Elevator Re-inspection Fees:

Elevator 1st Reinspection - Per Inspection:	0	\$0.00
Elevator Subsequent Inspection - Per Inspection:	0	\$0.00
Elevator - Other Fees:		\$0.00
Elevator - Explain Other Fees:		

Total of All Fees:		\$46.00
Total of Payments:		\$46.00
Balance Due:		\$0.00

Prj1000081

BUILDING DEPARTMENT
1700 Convention Center Drive
Miami Beach, FL 33139
Office: 305-673-7610 Fax: 305-673-7857

WORK PERMIT APPLICATION Bms1000 339
FLORIDA BUILDING CODE IN EFFECT

Date Oct 30 09 Permit # B1000129

Folio # 3232-011-0280 Job Address 424 W D. Lido Dr.

If subsidiary or revision: provide the Master building permit number here B: _____

IS THIS PERMIT ASSOCIATED WITH A VIOLATION? If so; BV # _____

Is this a City Owned Property? Yes No HISTORIC DISTRICT Yes No

Type of Property: Single Family Commercial Multi-Family/Condo *Condo Conversion

Type of Permit: Building Electrical Plumbing Mechanical

Type of Improvement: New Construction Renovation Demolition - Year Built _____

Type of Change: Change of Contractor Change of Architect/Engineer Revision

Description of Work: # of Units _____ # of Stories _____

NO SKYLIGHT 4 skylight openings

New Construction/Addition: Job Value \$ _____ Sq Ft _____

Alteration/Remodel/Renovation: Job Value \$ _____ Sq Ft _____

OTHER - Job Value \$ 400 Sq Ft _____ Linear Ft _____ Pool/Spa Gallage _____

Owner' Name Smith Drivers License No. _____

Address 424 W D. Lido Dr. Unit # _____

City/State/Zip Miami Beach Phone _____ Email _____

Tenant's Name _____ Address _____

City/State/Zip _____ Phone _____ Email _____

Fee Simple Title Holder's Name (if other than owner) _____

Address _____

City/State/Zip _____ Phone _____ Email _____

Contractor BMS Construction License No. 1327384 Cell # 954 4798090

Address 8460 TPT ST

City/State/Zip Pembroke Pines Office # 954 258 6226 Email _____

Architect _____ License No. _____ Cell # _____

Address _____

City/State/Zip _____ Office # _____ Email _____

Engineer _____ License No. _____ Cell # _____

Address _____

City/State/Zip _____ Office # _____ Email _____

Bonding Company Name _____

Address _____

City/State/Zip _____ Phone _____

Mortgage Lender's Name _____

Address _____

City/State/Zip _____ Phone _____

This application is hereby made to obtain a permit to do the work and installations as indicated. I certify that all work will be performed to meet the standards of all laws and construction regulations in this jurisdiction. I understand that a separate permit must be secured for Electrical Work, Plumbing, Signs, Wells, Pools, Furnaces, Boilers, Heaters, Tanks, and Air Conditioners, Etc.

***CONDO CONVERSIONS are a change use of the building and require a new certificate of occupancy. If this application implies a condo conversion, it shall be clearly stated in the description and on the plans; otherwise, the certificate of occupancy will be denied.**

OWNER'S AFFIDAVIT: I certify that all the foregoing information is accurate and that all work will be done in compliance with all applicable laws regulating construction and Zoning.

NOTICE: In addition to the requirements of this permit, there may be additional restrictions applicable to this property that may be found in the public records of this county, and there may be additional permits required from other governmental entities such as water management districts, state agencies or federal agencies.

Under penalties of perjury, I declare that to the best of my knowledge, the facts stated in this document are true. Any information found to be false may cause the revocation and/or denial of the permit and/or certificate of occupancy.

If the contractor is going to be hired by the tenant, check here.

Signature of Owner or Agent

Signature of Tenant

Brian M. Symula
Signature of Qualifier

Printed Name of Owner or Agent

Printed Name of Tenant

Brian M. Symula
Printed Name of Qualifier

Date _____

Date _____

Date *10-30-99*

Signature of Notary Public

Signature of Notary Public

Debra Snyder
Signature of Notary Public

Identification

Identification

Identification *S540-073-80-419-0*

Sworn to and subscribed before me this _____ day of _____ 20, _____
(SEAL)

Sworn to and subscribed before me this _____ day of _____ 20, _____
(SEAL)

Sworn to and subscribed before me this *30* day of *October* 20*00*
(SEAL) *Debra Snyder*
COMMISSION #00708656
EXPIRES: SEP 03, 2011
WWW.AARONNOTARY.com

If you are applying for this permit as Owner/Builder, please sign below only

WARNING TO OWNER: YOUR FAILURE TO RECORD A NOTICE OF COMMENCEMENT MAY RESULT IN YOUR PAYING TWICE FOR IMPROVEMENTS TO YOUR PROPERTY. IF YOU INTEND TO OBTAIN FINANCING, CONSULT WITH YOUR LENDER OR ATTORNEY BEFORE RECORDING YOUR NOTICE OF COMMENCEMENT. NOTICE OF COMMENCEMENT SHOULD BE FILED AT: 22 NW 1ST STREET, MIAMI, FL

STATE OF FLORIDA

COUNTY OF _____

Print Owner's Name

Owner's Signature

Sworn to and subscribed before me this _____ day of _____ 20, by: _____

() Personally Known () Produced Identification - Type of Identification _____

Signature of Notary Public

(Seal)

Application Approved By: _____ (Permit Clerk)

BMS 1000339

City of Miami Beach
Building Department

2 Pgs
ANY OVER
CAN
Review Type
Structural
Zoning
Engineering
Public Works
BLDG

SKYLIGHT PERMIT



BUILDING CODE COMPLIANCE OFFICE (BCCO)
PRODUCT CONTROL DIVISION

OFFICE MIAMI-DADE COUNTY, FLORIDA
METRO-DADE FLAGLER BUILDING

140 WEST FLAGLER STREET, SUITE 1603
MIAMI, FLORIDA 33130-1563
(305) 375-2901 FAX (305) 375-2908

NOTICE OF ACCEPTANCE (NOA)

Birdview Skylights

www.miamidadegov

11/10/09
11/10/09
JY

Scope: This NOA is being issued under the applicable rules and regulations governing the use of construction materials. The documentation submitted has been reviewed by Miami-Dade County Product Control Division and accepted by the Board of Rules and Appeals (BORA) in Miami Dade County and other areas where allowed by the Authority Having Jurisdiction (AHJ) of the state agency in which the product is being used.

This NOA shall not be valid after the expiration date below. The Miami-Dade County Product Control Division (In Miami Dade County) and/or the AHJ in other than Miami Dade County reserve the right to have this product or material tested for quality assurance purposes. If this product or material fails to perform in the accepted manner, the manufacturer will incur the expense of such testing and the AHJ may immediately revoke, modify, or suspend the use of such product or material within their jurisdiction. BORA reserves the right to revoke this acceptance, if it is determined by Miami-Dade County Product Control Division that this product or material fails to meet the requirements of the applicable building code.

This product is approved as described herein, and is designed to comply with the High Velocity Hurricane Zone of the Florida Building Code.

DESCRIPTION: Aluminum Framed Polycarbonate Dome Skylight.

APPROVAL DOCUMENT: Drawing No. DAD 0608.1 model "6SF-DADE", sheets 1 & 2 of 2, prepared by Birdview Skylights dated February 05, 2008, signed and sealed by Vipin N. Tolat, P.E., on July 08, 2008, bearing the Miami-Dade County Product Control Revision stamp with the Notice of Acceptance number and the expiration date by the Miami-Dade County Product Control Division.

MISSILE IMPACT RATING: Large & Small Missile Impact

LABELING: Each unit shall bear a permanent label with the manufacturer's name or logo, city, state and the following statement: "Miami-Dade County Product Control Approved", unless otherwise noted herein and the dome shall be properly marked by GE Plastics.

RENEWAL of this NOA shall be considered after a renewal application has been filed and there has been no change in the applicable building code negatively affecting the performance of this product.

TERMINATION of this NOA will occur after the expiration date or if there has been a revision or change in the materials, use, and/or manufacture of the product or process. Misuse of this NOA as an endorsement of any product, for sales, advertising or any other purposes shall automatically terminate this NOA. Failure to comply with any section of this NOA shall be cause for termination and removal of NOA.

ADVERTISEMENT: The NOA number preceded by the words Miami-Dade County, Florida, and followed by the expiration date may be displayed in advertising literature. If any portion of the NOA is displayed, then it shall be done in its entirety.

INSPECTION: A copy of this entire NOA shall be provided to the user by the manufacturer or its distributors and shall be available for inspection at the job site at the request of the Building Official.


This NOA revises & renews NOA # 03-0303.11 and it consists of this page 1, evidence submitted pages E-1 & E-2 as well as approval document mentioned above.

The submitted documentation was reviewed by Helmy A. Makar, P.E., M.S.



Helmy A. Makar
07/31/2008

NOA No. 06-061149
Expiration Date: 07/31/2013
Approval Date: 07/31/2008
Page 1

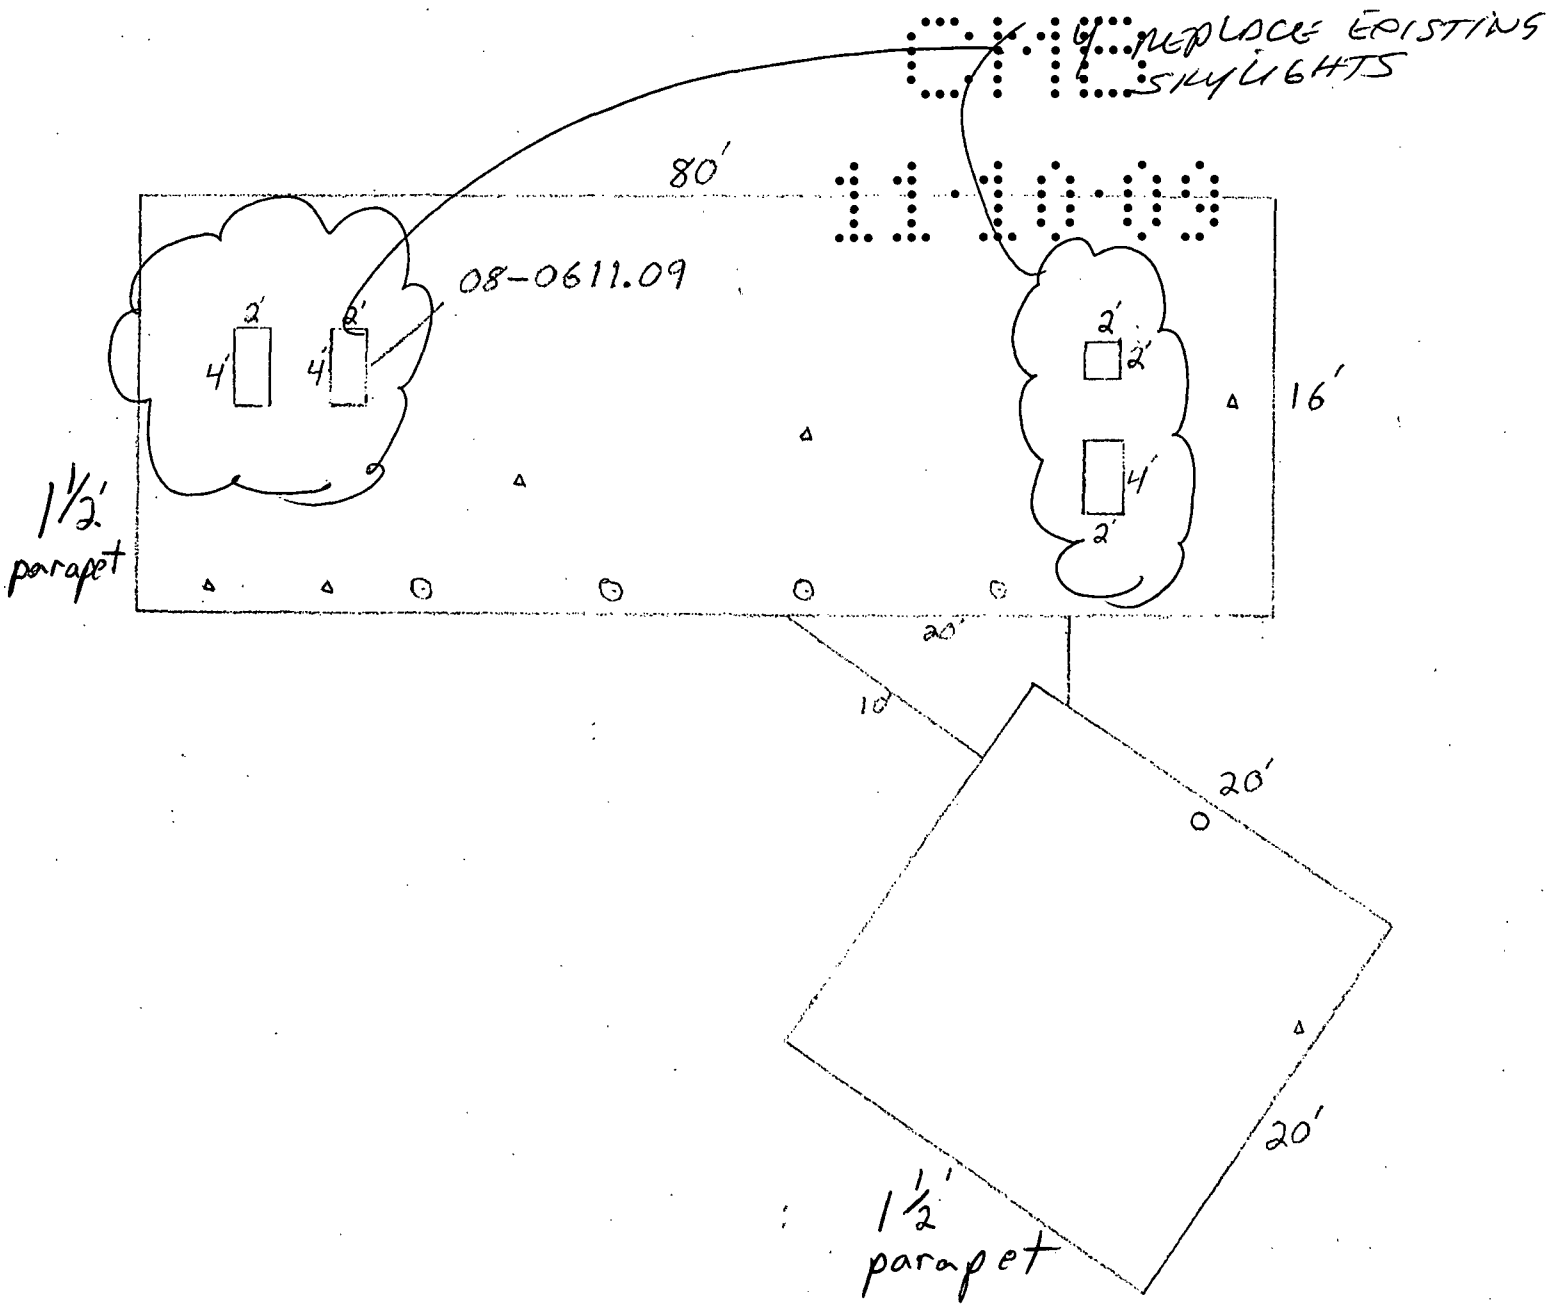

910

00.01.11

Birdview Skylights

NOTICE OF ACCEPTANCE: EVIDENCE SUBMITTED

1. EVIDENCE SUBMITTED UNDER PREVIOUS APPROVAL #03-0303.11

A. DRAWINGS

1. *Drawing No. EB696, sheets 1 & 1, model "6SFD-DADE", prepared by Birdview Skylights, dated 07/26/00, with no revisions, signed and sealed by V. N. Tolat, P.E.*

B. TESTS

1. *Test report on Large Missile Impact Test per PA 201, Cyclic Load Test per PA 203 and Uniform Static air Pressure Test per PA 202, on "Series 6SFD-DADE Self Flashing Aluminum/Polycarbonate Skylight", prepared by Miami Testing Laboratory, report No. K-49362 issued on 09/10/96, signed and sealed by D. G. Ober, P.E.*

C. CALCULATIONS

1. *Anchor Calculation, sheets 2 through 5, dated 08/21/96 and signed by D. A. Terwilleger, PE.*

D. MATERIAL CERTIFICATIONS

1. *Notice of Acceptance No. 00-0718.02 issued to General Electric Company on 09/08/2000, expiring on 07/02/2003.*
2. *Extrusion drawings No. BVS-X10947-A & BVS 8554 by Tel Tower Extrusions, LTD for Birdview Skylights.*

E. STATEMENTS

1. *No change letter issued by Birdview Skylights, on 08/10/2000 and signed by E. Bird.*
1. *No change letter issued by Birdview Skylights on 02/11/03 and signed by G. E. Bird.*

2. NEW EVIDENCE SUBMITTED

A. DRAWINGS

1. *Drawing No. DADE608.1, model "6SF-DADE", sheets 1 & 2 of 2, prepared by Birdview Skylights dated February 05, 2008, signed and sealed by Vipin N. Tolat, P.E., on July 08, 2008.*

B. TESTS

1. *Test report on Large Missile Impact Test per TAS 201, Cyclic Load Test per TAS 203 and Uniform Static air Pressure Test per TAS 202, on "Series 6SF-DADE Self Flashing Aluminum/Polycarbonate Skylight", prepared by American Test Lab of South Florida, report No. 0331.01-08, dated 05/23/2008, signed and sealed by William R. Mehner, P.E. and Henry Hattem, P.E.*



Helmy A. Makar, P.E., M.S.
Product Control Examiner
NOA No. 08-0611.09
Expiration Date: 07/02/2013
Approval Date: 07/31/2008

Birdview Skylights

NOTICE OF ACCEPTANCE: EVIDENCE SUBMITTED

C. CALCULATIONS


1. *Anchor Calculation, sheets 1 through 3 of 3, dated 06/09/2008, signed and sealed by Vipin N. Tolat, P.E.*

D. QUALITY ASSURANCE

1. *By Miami-Dade County Building Code Compliance Office.*

E. MATERIAL CERTIFICATIONS

1. *None.*

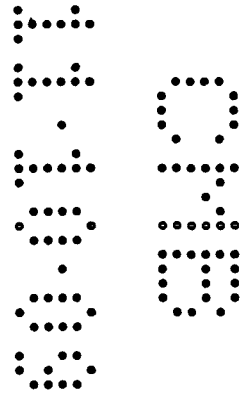

Henry A. Makar

Henry A. Makar, P.E., M.S.

Product Control Examiner

NOA No. 08-0611.09

Expiration Date: 07/02/2013

Approval Date: 07/31/2008

9/10/1968

CONFIDENTIAL - SECURITY INFORMATION

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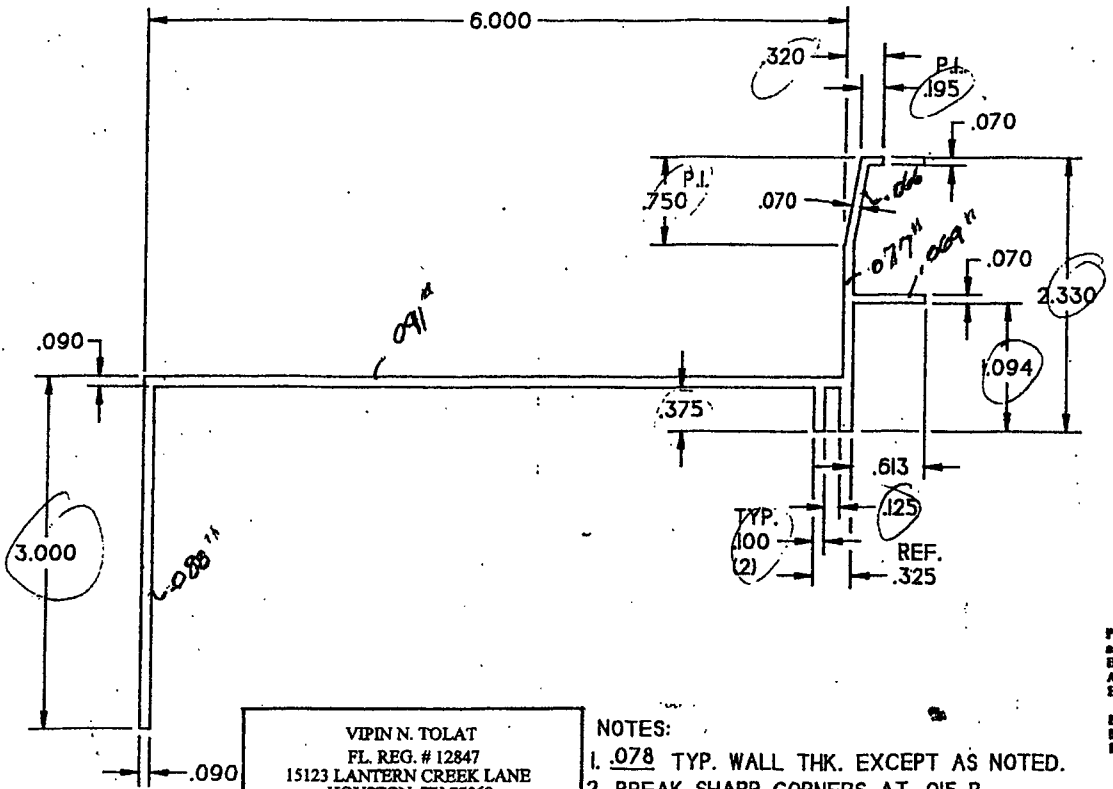
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DIE NO. BVS-XI0947-A
 REV. NO. LA.9702
 INCL. NO. LB.255
 FEEDER NO. F.P.9702



PRODUCT REVISED
 as complying with the Florida
 Building Code
 Acceptance No. 08-0611-09
 Expiration Date 07/09/2013
 By: *Heather H. Allen*
 Blended Dade Product Control
 Division

VIPIN N. TOLAT
 FL. REG. # 12847
 15123 LANTERN CREEK LANE
 HOUSTON, TX 77068


- NOTES:
 1. .078 TYP. WALL THK. EXCEPT AS NOTED.
 2. BREAK SHARP CORNERS AT .015 R.

BIRDVIEW SKYLIGHTS
THE CLEAR CHOICE
 201 LONGHORN RD. FT. WORTH TX. 76179
 TEL:817-439-9266 FAX:817-232-8468

DATE: 2-5-08	MODEL: 6SF-DADE
DRAWING# 608.1	DRAWN BY: E. BIRD
SHEET 2 OF 2	SCALE: NTS


E. Bird
 7/8/08

ALUMINUM ASSOCIATION STANDARD TOLERANCES TO APPLY UNLESS OTHERWISE SPECIFIED				tel. TOWER EXTRUSIONS, LTD.	
PART NO.				NAME	
BIRDVIEW SKYLIGHTS				BIRDVIEW SKYLIGHTS	
CLASS				END USE	
SOLID				6" SELF-FLASHING	
ALLOY				DIE NO.	
6063-T5				BVS-XI0947-A	

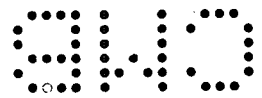

1000

042

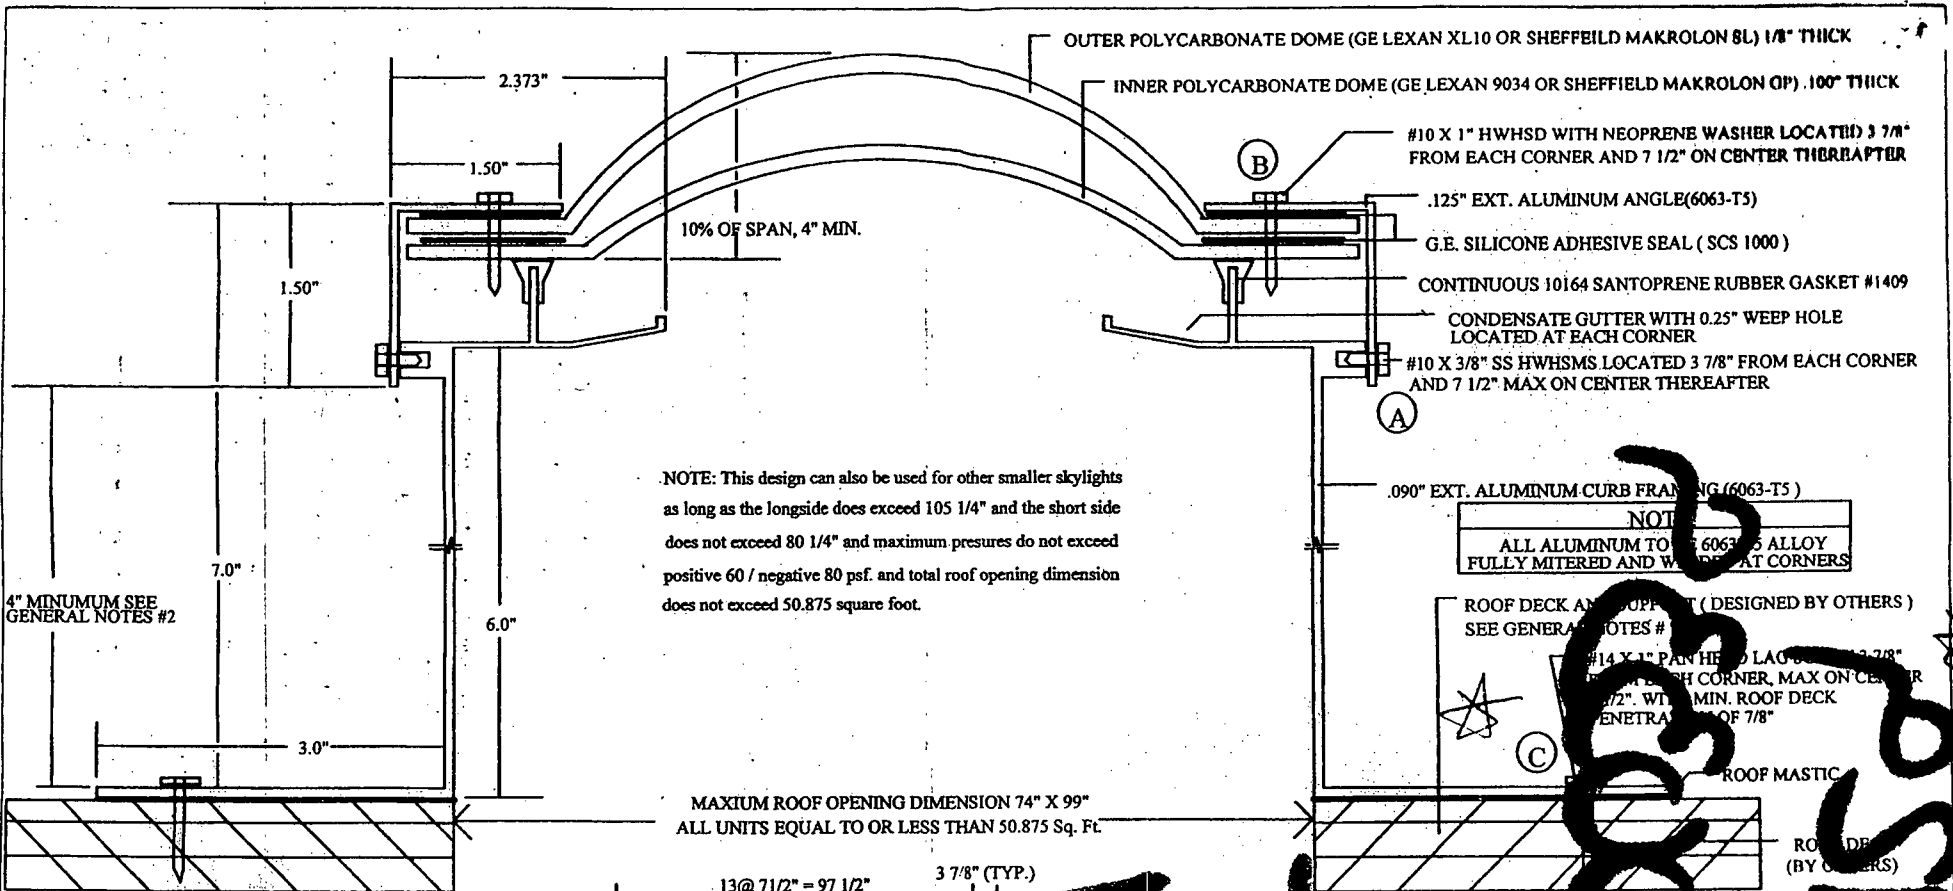

NOTE: This design can also be used for other smaller skylights as long as the longside does exceed 105 1/4" and the short side does not exceed 80 1/4" and maximum pressures do not exceed positive 60 / negative 80 psf. and total roof opening dimension does not exceed 50.875 square foot.


NOTICE
ALL ALUMINUM TO BE 6063-T5 ALLOY FULLY MITERED AND WELDED AT CORNERS

ROOF DECK AND SUPPORT (DESIGNED BY OTHERS) SEE GENERAL NOTES #

#14 X 1" PAN HEAD LAG BOLTS LOCATED 3 7/8" FROM EACH CORNER, MAX ON CENTER THEREAFTER 7 1/2". WITH MIN. ROOF DECK PENETRATION OF 7/8"

4" MINIMUM SEE GENERAL NOTES #2

DESIGN PRESSURE RATING
POSITIVE +60psf NEGATIVE -80psf
LARGE MISSILE IMPACT RESISTANT

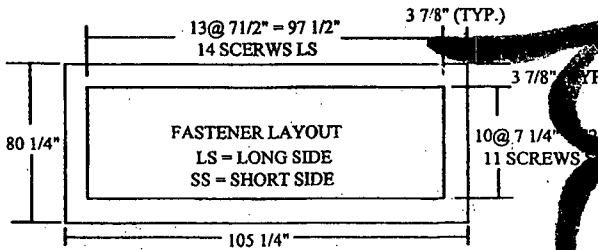

TOTAL 50 SCREWS AT LOCATIONS A, B & C FOR THIS SKYLIGHT. FOR OTHER SMALLER SIZES PROVIDE FASTENER LAYOUT ON CENTER EACH SIDE.

VIPIN N. T...
P.L. REG. # 347
15123... ANTER...
DUSTON, TX

- GENERAL NOTES
- ALL ROOFING DETAILS SHALL COMPLY WITH FBC 2007
 - 4" MINIMUM DISTANCE FROM ANGLE LIP TO ROOF SURFACE IS FOR SINGLE OR BUR WITHOUT INSULATION. FOR INSULATION AND ROOF TILES, ADD THE TILE HEIGHT AND THE INSULATION THICKNESS TO THE 4" MINIMUM HEIGHT.

DATE: 2-5-08	MODEL: 6SF-DADE
DR: WING # DADE608.1	DRAWN BY: F. BIRD
SHEET 1 OF 2	SCALE: NTS

[Large handwritten signature and scribbles in black ink, partially obscuring the drawing and text.]

B1000129

B151000339

Office
Copy

City of Miami Beach
Building Department
~~Roofing Permit~~ SKYLIGHT PERMIT
OFFICE COPY

Review Type	Initials	Date	Bond
Structural	KP	11/2/09	NA
Zoning	[Signature]	11/10/09	NA
Engineering	[Signature]	11.10.09	NA
Public Works	JY	11/10/09	

BLDG.

**PUBLIC WORKS
PLAN REVIEW NOTICE**

Phone 305-673-7080 Fax 305-673-7028

THIS PLAN REVIEW CONSTITUTES APPROVAL FOR
OBTAINING BUILDING PERMITS ONLY.

All construction and/or use of equipment in the right-of-way and/or easements, requires a separate Public Works Department permit prior to start of construction.

Permit Requirements: Proof of existing sidewalk/swale area conditions (pictures) and/or posting of sidewalk/roadway bonds (Public Works Inspection of the right-of-way will be required prior to final sign-off on the C.C. / C.O., or the release of bonds.)

Approved/Reviewed By: [Signature] Date: 11.10.09

Total Permits: 52

Permit No	COMP TYPE	SUB TYPE	DESCRIPTION	STATUS	APPLIED DATE	APPROVED DATE	EXPIRED/FINALED DATE	VAL TOTAL	PARCEL NO	STREET NO	DIR	STREET NAME
BC095060	BCOCC	NEW	FINAL C.O. FOR A 2 STORY RESIDENCE	APPROVED	2/14/1995	2/16/1995	1/1/0001	\$0.00	32320110280	424 W		DILIDO DR
BC095046	BCOCC	NEW	TEMPORARY C.O. FOR 2 STORY	FINAL	1/13/1995	1/13/1995	4/12/1995	\$0.00	32320110280	424 W		DILIDO DR
BD910020	BDEMO	DEMO	TOTAL DEMOLITION OF BUILDING	CLOSED	5/7/1991	5/28/1991	11/24/1991	\$4,000.00	32320110280	424 W		DILIDO DR
BE941217	BELEC	OTH	BURGLAR ALARM SYSTEM	CLOSED	6/10/1994	6/10/1994	12/10/1994	\$1,000.00	32320110280	424 W		DILIDO DR
BE920092	BELEC	NEW	OUTLETS,APPLS,A/C,LIGHT FIXTURES	FINAL	10/23/1991	10/23/1991	6/19/1995	\$10,000.00	32320110280	424 W		DILIDO DR
BE911177	BELEC	NEW	TEM FOR CONSTRUCTION	CLOSED	7/16/1991	7/16/1991	6/19/1995	\$600.00	32320110280	424 W		DILIDO DR
BM920233	BMECH	NEW	INST 15T SYS ST HT DT WK	CLOSED	12/13/1991	12/13/1991	6/27/1992	\$12,000.00	32320110280	424 W		DILIDO DR
BM151607	BMECH	A/C	RenewBM150508/Exact change out (5 ton)	FINAL	7/1/2015	7/6/2015	1/2/2016	\$5,610.00	32320110280	424 W		DILIDO DR
BM150508	BMECH	A/C	Exact change out (5 ton)	CLOSED	12/30/2014	12/30/2014	6/28/2015	\$5,610.00	32320110280	424 W		DILIDO DR
BM071502	BMECH	A/C	EXACT a/c changeout / 2 system	FINAL	9/24/2007	9/24/2007	8/27/2008	\$8,525.00	32320110280	424 W		DILIDO DR
BM071002	BMECH	A/C	EXACT a/c change out of 3 ton ac/8kw	FINAL	5/25/2007	5/25/2007	12/11/2007	\$4,849.39	32320110280	424 W		DILIDO DR
BM060691	BMECH	A/C	EXACT 2T C/O AND 1 SHTH	FINAL	3/28/2006	3/28/2006	9/24/2006	\$3,988.46	32320110280	424 W		DILIDO DR
BM040189	BMECH	A/C	repl St syst	FINAL	11/12/2003	11/12/2003	6/21/2004	\$4,700.00	32320110280	424 W		DILIDO DR
BM940832	BMECH	NEW	INST 13T SYS NEW DTWK UPSTAIRS	FINAL	4/29/1994	4/29/1994	6/12/1995	\$10,000.00	32320110280	424 W		DILIDO DR
BMS40700	BMISC	OTH	PERMIT #B9100085 EXTENSION	CLOSED	3/1/1994	3/1/1994	1/1/0001	\$0.00	32320110280	424 W		DILIDO DR
BMS40911	BMISC	OTH	PERMIT #B9100085 CONTRACTOR	CLOSED	4/5/1994	4/5/1994	1/1/0001	\$0.00	32320110280	424 W		DILIDO DR
BMS41542	BMISC	OTH	TRANSFER FEE-ELECTRIC P #BE920092	CLOSED	8/4/1994	8/5/1994	1/1/0001	\$0.00	32320110280	424 W		DILIDO DR
BMS41171	BMISC	OTH	TRANSFERING PLUMBING P #BP920035	CLOSED	5/25/1994	5/25/1994	1/1/0001	\$0.00	32320110280	424 W		DILIDO DR
BMS20990	BMISC	OTH	PERMIT #B9100085 EXTENTION	CLOSED	4/21/1992	4/21/1992	1/1/0001	\$0.00	32320110280	424 W		DILIDO DR
BMS20952	BMISC	OTH	TRANSFER FEE BLDG P #B9100085	CLOSED	4/14/1992	4/14/1992	1/1/0001	\$0.00	32320110280	424 W		DILIDO DR
BMS1000339	BMISC	REVISE	REVISION TO B1000129- NEW SKY	FINAL	10/30/2009	11/10/2009	5/9/2010	\$0.00	32320110280	424 W		DILIDO DR
BMS00822	BMISC	OTH	10 MICROFILM COPIES & 3 XEROX	FINAL	3/29/1990	3/29/1990	1/1/0001	\$0.00	32320110280	424 W		DILIDO DR
BP920035	BPLUM	OTH	RENEW PLUMBING SYSTEM	FINAL	10/16/1991	10/17/1991	6/14/1995	\$15,000.00	32320110280	424 W		DILIDO DR
BP911207	BPLUM	NEW	RENEW PL SYSTEM	CLOSED	9/26/1991	9/26/1991	6/19/1995	\$10,500.00	32320110280	424 W		DILIDO DR
BP941513	BPLUM	NEW	PORTABLE TOILET	FINAL	6/7/1994	6/7/1994	6/19/1995	\$300.00	32320110280	424 W		DILIDO DR
B1000129	BSBUILD	ROOFING	Re-Roof/ 1,780 Sq.Ft. Flat roof	FINAL	10/9/2009	10/23/2009	5/12/2010	\$9,900.00	32320110280	424 W		DILIDO DR
BS941857	BSBUILD	OTH	NEW FLAT ROOF ON EXISTING DECK	FINAL	4/15/1994	4/15/1994	6/19/1995	\$6,500.00	32320110280	424 W		DILIDO DR
B9100085	BUILD	NEW	CONSTRUCTION OF 2 STORY	FINAL	12/12/1990	4/16/1991	6/19/1995	\$300,000.00	32320110280	424 W		DILIDO DR
B9400324	BUILD	ALT	INST NEW WNDWS/SLDNG GLASS	CLOSED	5/16/1994	5/17/1994	6/19/1995	\$20,686.00	32320110280	424 W		DILIDO DR
CC943669	CCOMPL	OTH	ADVERTISING SIGNS IN RESIDENTIAL	CLOSED	5/2/1994	5/2/1994	5/3/1994	\$0.00	32320110280	424 W		DILIDO DR
CC941445	CCOMPL	OTH	ABANDONED CONSTRUCTION SITE &	CLOSED	1/5/1994	1/1/0001	1/6/1994	\$0.00	32320110280	424 W		DILIDO DR
CC941373	CCOMPL	OTH	EMPTY HOUSE OPEN & UNSECURED	CLOSED	1/3/1994	1/1/0001	1/5/1994	\$0.00	32320110280	424 W		DILIDO DR
CC941194	CCOMPL	OTH	SIDE OF CONST SITE NEEDS FENCE	CLOSED	12/20/1993	1/1/0001	4/6/1994	\$0.00	32320110280	424 W		DILIDO DR
CC930565	CCOMPL	OTH	OVERGROWN, TRASH & DEBRIS	CLOSED	11/2/1992	1/1/0001	2/5/1993	\$0.00	32320110280	424 W		DILIDO DR
CC910454	CCOMPL	OTH	ALLOWING SHRUBS TO MATERIALLY	VOID	10/26/1990	10/26/1990	11/10/1990	\$0.00	32320110280	424 W		DILIDO DR
CC910283	CCOMPL	OTH	CHECK FOR VISIBILITY DUE TO SHRUBS	CLOSED	10/16/1990	10/16/1990	10/31/1990	\$0.00	32320110280	424 W		DILIDO DR
CE14012928	CMVIO	SEAWALL	-Section of the code 66-106(a).	CLOSED	8/27/2014	9/15/2014	9/29/2015	\$0.00	32320110280	424 W		DILIDO DR
CE12007360	CNOISE	CONSTRN	CONSTRUCTION NOISE	NOTAPPLY	3/19/2012	1/1/0001	1/1/0001	\$0.00	32320110280	424 W		DILIDO DR
CE07006816	CPMIVIO	GENERAL	Graffiti on fence and metal deteriorated	CLOSED	7/20/2007	7/20/2007	1/18/2007	\$0.00	32320110280	424 W		DILIDO DR
CR940254	CROLL	OTH	20YD PVT. PRTY	CLOSED	5/2/1994	5/2/1994	7/1/1994	\$0.00	32320110280	424 W		DILIDO DR
CE14000975	CSVIO	ILLEGAL	pile of tree trimmings etc. dumped on swale	CLOSED	10/30/2013	10/30/2013	10/31/2013	\$0.00	32320110280	424 W		DILIDO DR
CE08008129	CSVIO	OTHER	pile of trash placed on the swale in front of	BILLOWE	8/18/2008	8/18/2008	1/8/2009	\$0.00	32320110280	424 W		DILIDO DR
ZV940753	CZVIO	OTH	CONSTRUCTION SIGN	CLOSED	4/28/1994	1/1/0001	8/2/1994	\$0.00	32320110280	424 W		DILIDO DR
ZV910067	CZVIO	OTH	ALLOWING SHRUBS TO MATERIALLY	CLOSED	10/26/1990	1/1/0001	11/26/1990	\$0.00	32320110280	424 W		DILIDO DR
BMS91917	MISC	OTH	TWO MICROFILM COPIES	CLOSED	9/26/1989	9/26/1989	1/1/0001	\$0.00	32320110280	424 W		DILIDO DR
BMS91414	MISC	OTH	TWO MICROFILM COPIES	CLOSED	6/28/1989	6/28/1989	1/1/0001	\$0.00	32320110280	424 W		DILIDO DR
BMS91406	MISC	OTH	TWO MICROFILM COPIES	CLOSED	6/27/1989	6/27/1989	1/1/0001	\$0.00	32320110280	424 W		DILIDO DR
WR110837	WROWAY	UTILITY	CMB R/W; OCCUPY R/W TO INSTALL	APPROVED	9/26/2011	1/4/2012	6/30/2012	\$0.00	32320110280	424 W		DILIDO DR
XC07003263	XC-COMP2	COMPLNT	Graffiti on the wall facing the venitan cross	VIO	7/23/2007	1/1/0001	7/20/2007	\$0.00	32320110280	424 W		DILIDO DR
XC07003099	XC-COMP2	COMPLNT	GRAFFITI WRITTEN ON WHITE WALL SW	VIO-C	7/3/2007	7/5/2007	7/23/2007	\$0.00	32320110280	424 W		DILIDO DR
XC07002887	XC-COMP2	COMPLNT	Stones and boat on front yard.	INVALID	6/15/2007	1/1/0001	6/19/2007	\$0.00	32320110280	424 W		DILIDO DR
XC07003643	XC-COMP2	PATROL	pile of trash in front of property	INVALID	8/21/2007	1/1/0001	8/31/2007	\$0.00	32320110280	424 W		DILIDO DR

Permit Number	Description	Address	Parcel	Permit Status	Apply Date	Issue Date	Permit Type	Work Type	Square Ft	Valuation
BPI2327241	roof coating	424 W W DI LIDO DR	0232320110280	Closed	9/26/2023		Building Online Application	Building Online Application	2200	14760.00
BRR2110896	permit drawings for home.	424 W W DI LIDO DR	0232320110280	Closed	11/1/2021		Building - Records Requests	Records Requests	0	0.00
BRR2211954	Requesting All Architectural Plans Building Records for 424 W Dilido Dr Miami Beach FL. Please share all documents related to this address	424 W W DI LIDO DR	0232320110280	Closed	1/12/2022		Building - Records Requests	Records Requests	0	0.00
BRR2421480	i need all plans for this residence. arch elect surveys etc	424 W W DI LIDO DR	0232320110280	Closed	1/31/2024		Building - Records Requests	Records Requests	0	0.00
BRR2422662	We would like very legible and clear Microfilm record of this existing building from past to present; Architectural, Structural, MEP, Civil, etc	424 W W DI LIDO DR	0232320110280	Initial	4/24/2024		Building - Records Requests	Records Requests	0	0.00
PRJ1500666		424 W DILIDO DR	0232320110280	Closed	7/1/2015	7/1/2015	ZZConverted	Converted Permits	0	0.00
PWD0217-0630		424 E DI LIDO DR	0232320110280	Issued	2/9/2017	2/13/2017	Roll-Off	Private	0	0.00
RFR2302318	roof coating	424 W W DI LIDO DR	0232320110280	Finald	10/2/2023	10/30/2023	Roofing - Residential	Waterproofing	2200	14760.00
RWP0118-2592	FP&L: WR # 7633774 - REPLACE 12 POLES & 3 ANCHORS;REMOVE 2 ANCHORS - W DILIDO DR FROM VENETIAN WAY TO 1 TER ; 2 TFR -3 TFR -4 TFR	412 DI LIDO DR ROW	0232320110280	Void	1/9/2018		ROW (Right-of-Way)	Underground Utilities	0	0.00
RWP0822-9552	FPL -WR# 6137837; REPLACE 1 POLE; INSTALL 1 POLE & 1 ANCHOR; 322 E DI LIDO DR; 435 W DI LIDO DR; 424 W DI LIDO DR	424 W DI LIDO DR ROW	0232320110280	Applied	8/11/2022	8/18/2022	ROW (Right-of-Way)	Underground Utilities	0	0.00

City of Miami Beach

Last Completed Item Reviews Across All Submittals

MIAMI BEACH

Print Date & Time: 10/26/2023 5:00:40 AM

BUILDING DEPARTMENT

Permit Type: Roofing - Residential Work Class: Waterproofing Application Date: 10/02/2023 Status: Applied

Reviewed For Compliance

Address: 424 W W DI LIDO DR

Permit: RFR2302318

RFR2302318

Item Review Type	Status	Version	Completed Date	Assigned User
Planning Review	Pass	1	10/02/2023	Daniela Bonilla
Permit Intake Review -1	Pass	1	10/02/2023	Aldo Fundora
Submittal Version Complete	Pass	2	10/28/2023	Vinson Pressley
Roofing Review - 1	Pass	2	10/25/2023	Lancelot Bacchus

10/28/2023 5:31:49 AM

Reviewed For Compliance

MIAMI BEACH



Permit Application

Building Department
1700 Convention Center Drive, 2nd Floor
Miami Beach, Florida 33139
P: 305-533-7710
miami-beach.fl.gov/building

RFR2302318

10/28/2023 5:31:49 AM

Applicant Information (Blue or Black Ink Only)			
Office Use Only	Master Permit Number (If applicable):		
Submittal Date: ___/___/___	Florida Statute 553.79 (16) regarding permit timelines. Please select one (Required):		
Permit #: _____	<input type="checkbox"/> Opt IN <input checked="" type="checkbox"/> Opt OUT		
Property Address: 424 W Dilido Dr. Miami Beach, FL 33139	Unit #: _____	Parcel/Folio Number: 02-3232-011-0280	
For more information, see attached F.S.553.79(16)			
Permit Type (select one)	Permit Request (select all that apply)	Property Information (select one)	
<input checked="" type="checkbox"/> Building <input type="checkbox"/> Electrical <input type="checkbox"/> Mechanical <input type="checkbox"/> Plumbing <input type="checkbox"/> Roofing <input type="checkbox"/> Phased Permit <input type="checkbox"/> Demo year-built <input type="checkbox"/> Generator <input type="checkbox"/> Temp Structure <input type="checkbox"/> Fire <input type="checkbox"/> Shop Drawings <input type="checkbox"/> Sub-permit	<input checked="" type="checkbox"/> New Permit <input type="checkbox"/> Change of Contractor <input type="checkbox"/> Change of Arch/Engr <input type="checkbox"/> LEED <input type="checkbox"/> Interior, Non-Structural <input type="checkbox"/> Affordable Housing <input type="checkbox"/> Permit Extension <input type="checkbox"/> Permit Renewal <input type="checkbox"/> Permit Revision <input type="checkbox"/> Private Provider <input type="checkbox"/> City Project <input type="checkbox"/> Reprieve Permit	<input type="checkbox"/> Commercial <input type="checkbox"/> Multi-Family Residential <input checked="" type="checkbox"/> Residential: Single-Family Residence/Duplex	
Occupancy Classification:			
(Attach a copy of the construction code book used to determine occupancy classification.)			
Type of Work	Value of Work	Area of Work (SqFt)	
(This amount cannot be changed once awarded.)			
New Construction/Additions:	\$		
Alterations/Reconfig of space:	\$ 14,760	2200	
Description of Work:			
ROOF COATING			
Property Owner		Contractor	
Name: Clarence Smith		Name: Pioneer Roofing	
Address: 424 West Dilido Drive		Address: 2026 Grant Street	
City: Miami Beach	State: FL	City: Hollywood	State: FL
Zip Code: 33139	Zip Code: 33020	Contractor License Number: CCC-1332507	
E-Mail Address (REQUIRED): CESMITHMD@HOTMAIL.COM		E-Mail Address: proffice@pioneerroofingcompany.com	
Daytime phone: 305 531 4004		Daytime phone: 954-920-7688	
Architect		Structural Engineer	
Name:		Name:	
License Number:		License Number:	
E-Mail Address:		E-Mail Address:	
Daytime phone:		Daytime phone:	
Notice & Certification			
<p>This application is hereby made to obtain a permit to do the work and installations as indicated. I certify that all work will be performed to meet the standards of all laws and construction regulations in this jurisdiction. I understand that a separate permit must be secured for Electrical, Elevator, Fire, Mechanical, Plumbing, Signs, Wells, Pools, Furnaces, Boilers, Heaters, Tanks, Air Conditioners, etc.</p> <p>Owner's Affidavit: I certify that all the foregoing information is correct. Owner Certifies that the aforementioned Contractor has the authorization to perform the work as specified above.</p> <p>Lessee's Affidavit: Lessee certifies that he has full consent and authorization from owner of subject property to perform the above-mentioned work and to hire above captioned contractor. In addition to the requirements of this permit, there may be additional restrictions applicable to this property that may be found in the public records of this county, and there may be additional permits required from other governmental entities such as: the Environmental Division of Miami-Dade County; Permitting, Environment and Regulatory Affairs, Water & Sewer Department, Department of Environmental Protection, South Florida Water Management District, Miami-Dade County Impact Fee, water management districts, state agencies, and/or federal agencies.</p> <p>I, the undersigned, declare that I have read the foregoing information and that the information furnished is true and correct. I understand that a false statement is guilty of the crime of perjury. I declare that I am not a minor and I am not a person who has been declared incompetent by a court of law.</p>			
<input type="checkbox"/> Owner/Lessee for new permits (Documentation establishing ownership may be requested). <input type="checkbox"/> Owner Builder Permit (must complete Owner Builder Affidavit) <input type="checkbox"/> Master Permit Contractor of Record (For sub-permit / change of contractor).			
<p>WARNING TO OWNER: YOUR FAILURE TO RECORD A NOTICE OF COMMENCEMENT MAY RESULT IN YOUR PAYING TWICE FOR IMPROVEMENTS TO YOUR PROPERTY. A NOTICE OF COMMENCEMENT IS REQUIRED FOR ANY WORK WITH COST EXCEEDING \$2,500.00.</p>			
Signature of Owner/Agent or GC (for Sub-permits): <i>Clarence E. Smith</i> PRINT NAME: CLARENCE E. SMITH MD STATE OF: FLORIDA COUNTY OF: MIAMI-DADE		Signature of Qualifier: <i>Nathan Dapour</i> PRINT NAME: Nathan Dapour STATE OF: FL COUNTY OF: BROWARD	
<p>The foregoing instrument was acknowledged before me, by means of <input checked="" type="checkbox"/> physical presence or <input type="checkbox"/> online notarization, this <u>25</u> day of <u>September</u>, 20<u>23</u> by <u>Clarence E. Smith</u> Signature of Notary Public: <i>Gregory E. Noll</i> PRINT NAME: Gregory E. Noll (SEAL) Personally known _____ or Produced Identification <u>FL D.U.</u> </p>		<p>The foregoing instrument was acknowledged before me, by means of <input type="checkbox"/> physical presence or <input checked="" type="checkbox"/> online notarization, this <u>26</u> day of <u>September</u>, 20<u>23</u> by <u>Nathan Dapour</u> Signature of Notary Public: <i>Gregory E. Noll</i> PRINT NAME: Gregory E. Noll (SEAL) Personally known <input checked="" type="checkbox"/> or Produced Identification _____ </p>	

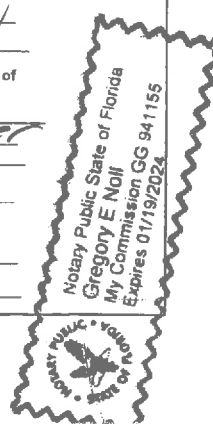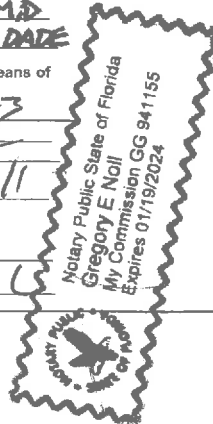

RFR2302318
10/28/2023 5:31:49 AM

Construction Cost Affidavit

I, CLARENCE SMITH, acting as agent (owner, registered agent, or legal representative) and I (general contractor/ sub-contractor), PIONEER ROOFING do hereby attest that the construction costs indicated herein for Permit Number _____ at property address 124 W DILDO DR. are accurate for this construction project.

Note: This affidavit is only required for job values that are \$5,000 or greater.

Master Permits:

Building cost (excludes roofing, windows, doors, railings, other, and MEP)\$: _____

Stand alone and sub-permits

Roofing \$: 14,760 Windows/Doors \$: _____ Railings \$: _____
Electrical \$: _____ Mechanical \$: _____ Plumbing \$: _____
Other \$: _____ Description: _____

Total Project Cost \$: 14,760

Under penalties of perjury, I declare that I have read the foregoing affidavit and that the facts stated in it are true.

Registered Owner/Agent or GC: CLARENCE E SMITH MD Registered Contractor: Nathan Daper / Pioneer Roofing
Signature of Owner/Agent or GC (for Sub-permits): [Signature] Signature of Qualifier: [Signature]

The foregoing instrument was acknowledged before me, by means of physical presence or online notarization,

this 25 day of September 2023

by Clarence Smith, who is personally known to me or

who has produced FLDL as identification

Notary Public, State of FL

County of Broward

Printed Name and Signature Gregory E. Nell [Signature]

Commission Number: _____
Commission Expires: _____

The foregoing instrument was acknowledged before me, by means of physical presence or online notarization,

this 26 day of September 2023

by Nathan Daper, who is personally known to me or

who has produced _____ as identification.

Notary Public, State of FL

County of Broward

Printed Name and Signature Gregory E. Nell [Signature]

Commission Number: _____
Commission Expires: _____

RFR2302318
10/28/2023 5:31:49 AM

Section A (General Information)

Master Permit Number: _____ Process Number: _____

Job Address: 424 W Dilido Dr Miami Beach

Contractor Name: Pioneer Roofing Company

Waterproofing Category

Balcony Parking Garage Plaza Deck Other: roof system

Waterproofing System Information

Low slope roof area (ft²): 2237 Steep Sloped area (ft²): _____ Total (ft²): 2237

Section B (Section Plan)

Sketch Section Plan: Illustrate all levels and sections, roof drains, scuppers, overflow scuppers and overflow drains. Include dimensions of sections and levels, clearly identify dimensions of elevated pressure zones and location of parapets.

Perimeter width .6(h): _____ ft Corner length .6(h): _____ ft
Corner width .2(h): _____ ft Separate roof plan provided: Yes No

SEE
ATTACHED

Reset Page


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ROOF AREA
424 DILIDO DR MIAMI BEACH

RFR2302318

10/28/2023 5:31:50 AM

-  Ridge
—
-  Hip
—
-  Valley
—
-  Rake
—
-  Eave
24'
-  Flashing
270' 11"
-  Step Flashing
27' 8"

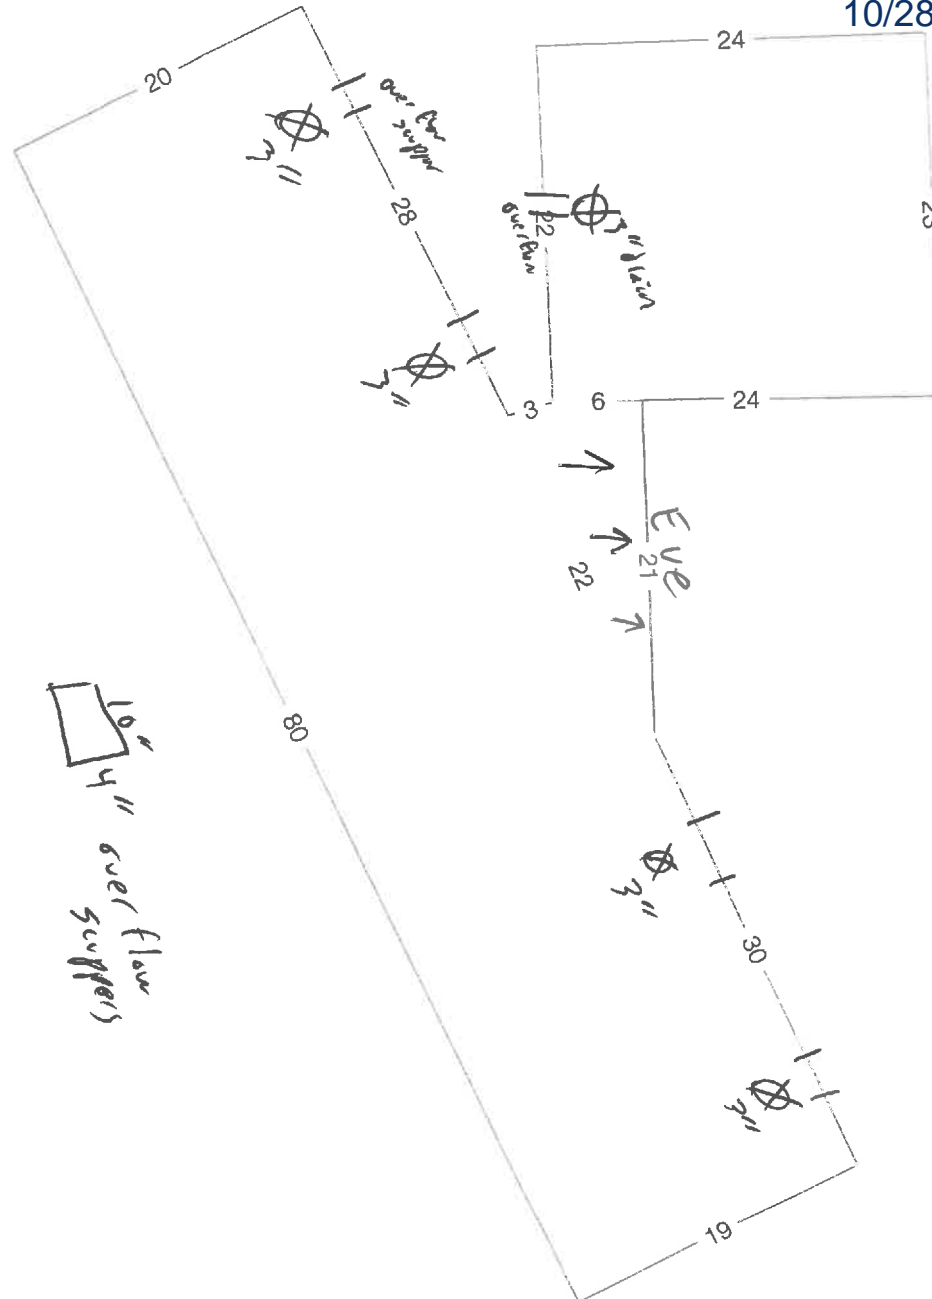

RFR2302318

Master permit number: _____

Process number: 10/28/2023 5:31:50 AM

Florida Product Approval (PA) or MDC Notice of Acceptance (NOA) number: 22-0809.06

Roof slope: 11.4 : 12 Roof height (h): 20 ft Perimeter width: _____ ft

Does this roof assembly comply with the requirements for a fire rating per section 1519.16.3 HVHZ Florida Building Code?

Yes No

Plaza Deck Balcony Parking Garage Other: _____

Minimum design wind pressures (psf) from 2020 RAS 128, or calculations per ASCE 7-16.

Exposure Category: C D

P(1') Field: _____ P(1) Field: _____ P(2) Perimeter: _____ P(3) Corner: _____

Maximum design pressure (psf) from PA or NOA: _____

Deck type: concrete / wood

Initial Primer: Tropical #996

Coverage: 1 100 ft²/gal

Insulation/Fire Barrier type & size: NA

Primer: NR

Coverage: _____ 100 ft²/gal

Base or anchor sheet: NA

Base Coat: NA

Coverage: _____ 100 ft²/gal

Membrane: NA

Intermediate Coat: NA

Coverage: _____ 100 ft²/gal

Top coat: Tropical #924

Coverage: 1.2 100 ft²/gal

Insulation/Fire Barrier attachment method: NA

Number of Fasteners per Insulation Board: NA

P(1)': _____ P(1): _____ P(2)': _____ P(3): _____

Base sheet attachment method: _____

Fastener spacing for base sheet attachment: _____

Fastener spacing for base sheet attachment: _____

	Lap spacing	Row spacing	Spacing in field of base sheet
P(1')	_____ in o/c	_____ row(s)	_____ in o/c
P(1)	_____ in o/c	_____ row(s)	_____ in o/c
P(2)	_____ in o/c	_____ row(s)	_____ in o/c
P(3)	_____ in o/c	_____ row(s)	_____ in o/c

Surfacing: _____

Overburden: _____

Reset Page

Print Page



A. TOMASSI ROOF TESTING, INC. Reviewed For Compliance

Roof Testing Services * Fastener Withdrawal Resistance * Tile Static Uplift * Moisture Surveys * Membrane Adhesion

RF2302318
10/28/2023 5:31:50 AM

October 18th, 2023

File # 1848-23

Mr. Greg Noll – Project Coordinator
Pioneer Roofing
2026 Grant Street
Hollywood, Florida 33020

Re: Roof Moisture Survey (TAS-126)
Smith Residence – Flat Decks
424 West Dilido Drive
Miami Beach, Florida 33139

Dear Mr. Noll,

As per your request, we have performed the enclosed roof moisture survey at the above referenced site.

The purpose of this examination was to assist with determining moisture levels in the existing roof system in accordance with the requirements of the Florida Building Code, Chapter 15, Section 1521.12.

No other warranties are expressed or implied.


It was my pleasure working with you on this project.

Please contact me if you have any questions regarding this report.

Sincerely,


Robert Flynn
General Manager

Digitally signed by John E Flynn
Date: 2023.10.18 17:41:14 -04'00'

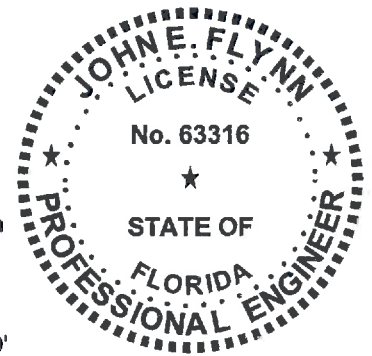

John Flynn (report review)
PE63316

This item has been digitally signed and sealed by John E Flynn, PE on the date shown.

Printed copies of this document are not considered signed and sealed and the signature must be verified on any electronic copies.

BUILDING DESCRIPTION:

The surveyed roofs of this residential building are comprised of three conjoined flat roof sections. Each individual roof section was scanned and cored for roof system composition and for gravimetric core analysis.

REF 2302318
10/28/2023 5:31:50 AM


For the purpose of this report, the roofs are labeled and designated as the Main Roof, the Center Connector Roof and the Outer East Roof on the following roof graph at the end of this report.

ROOF SYSTEM CONSTRUCTION

MAIN ROOF & OUTER EAST ROOF:

The tested flat roof systems both consisted of granular surfaced, asphalt applied built up roof systems installed over approximately 1/2" thick wood fiber insulation.

The decks are wood.

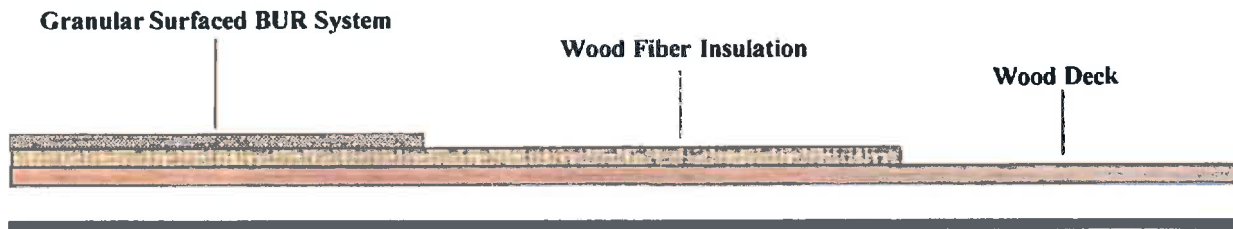

CENTER CONNECTOR ROOF:

The tested flat roof system consisted of a granular surfaced, asphalt applied built up roof system installed over approximately 1/2" thick perlite insulation.

The deck is concrete.



All above roof system descriptions are from our roof core locations.

METHOD:

A nuclear roof moisture test & Impedance testing in accordance with the requirements of the Florida Building Code & Troxler Electronic Laboratory was performed for informational purposes to assist with locating moisture intrusion, using a model 3216 roof moisture gauge and a DEK roof scanner gauge. Core samples were taken at several intervals, including the high and low reading sites. The Core samples were then gravimetrically tested to determine the percentage of moisture contained in each sample.

Reviewed For Compliance

GRAVIMETRIC ANALYSIS:

The core samples were placed in airtight containers at the job site, transported to our office laboratory facility, weighed as a wet sample, then oven dried for 24 hours at 230 F, then reweighed as a dry sample. The percentage of moisture was then calculated.

RF R2302318

10/28/2023 5:31:50 AM

GRAVIMETRIC CORE ANALYSIS RESULTS

Chart A

Gravimetric Core Analysis

Sample I D - C = Core	Core Sample Composition	Percent of moisture
C-1 reading = 13	Granulated BUR Membrane Sample	.16 %
C-1 Location C-14	Wood Fiber Insulation Sample	1.37%
C-2 reading = 20	Granulated BUR Membrane Sample	.54 %
C-2 Location D-10	Wood Fiber Insulation Sample	.78%
C-3 reading = 20	Granulated BUR Membrane Sample	.39%
C-3 Location I-8	Wood Fiber Insulation Sample	.93
C-4 reading = 29	Granulated BUR Membrane Sample	.28 %
C-4 Location A-6	Wood Fiber Insulation Sample	NA-No Sample
C-5 reading = 43	Granulated BUR Membrane Sample	.11 %
C-5 Location E-8	Perlite Insulation Sample	.78%

MOISTURE PERCENTAGES HIGHLITED RED = HIGH MOISTURE – Not Detected

FLORIDA BUILDING CODE, MOISTURE ALLOWANCES:

The (FBC) Florida Building Code sets an allowable maximum limit of moisture in the roof system as 5 % in the roof membrane, and 8 % in the rigid board commercially manufactured insulation.

The Grid Pattern Selected By Our Test Director Was 5' X 5' Maximum.

CONCLUSIONS:

The surveyed flat Main Roof and Outer East Roof both consisted of granular surfaced asphalt applied built up roof systems installed over wood fiber insulation. The roof decks are wood.

The flat Center Connector Roof consisted of a granular surfaced asphalt applied built up roof system installed over perlite insulation. The roof deck is concrete.

The roof areas surveyed encompassed a combined area of approximately 2,100 SF total.

Our survey determined & verified that high moisture levels were not detected to be entrapped in the existing BUR system and/or in the underlying insulation.

The entire 2,100 SF of combined roof areas were found to be within the allowable moisture levels of the Florida Building Code, at the time of this survey.


Higher readings were determined to be caused by variations in membrane thicknesses.

Our testing verified that high moisture levels were not detected at the time of this survey. Therefore, all surveyed flat roofs are currently in compliance with the requirements of the FBC for reroofing, recovering, roof repairs and or roof maintenance & coatings.

All other Code requirements must be followed. See attached roof graph for additional information.

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MOISTURE SURVEY READINGS

5' X 5' GRID PATTERN MAXIMUM

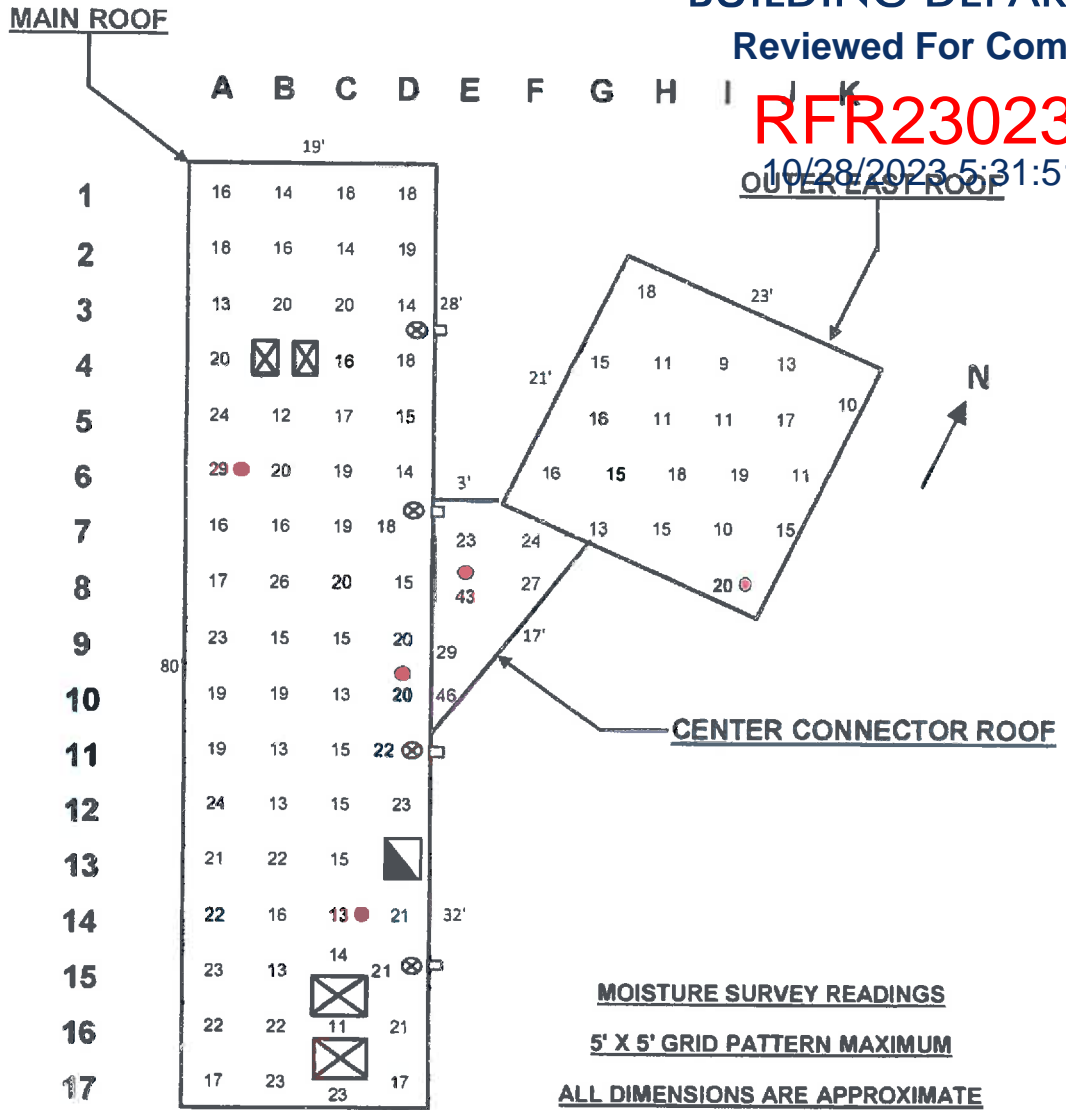ALL DIMENSIONS ARE APPROXIMATE

All blue shaded areas represent areas of high moisture levels - ■

Moisture levels exceeding the maximum allowable limits of the FBC, Chapter 15, Section 1521.12, was not detected at the time of this survey.

Survey Date: October 16th, 2023
Weather Conditions: Sunny - 83 F
Core Locations - ●
HVAC on Curbs or Equipments Stands - ■
Internal Drain - ⊗
Skylight - ⊗
Scuppers - □

Project:
Residential Flat Deck
424 West Dilido Drive
Miami Beach, Fl.

Certificate of Calibration

KELC-935245

Kimball Electronic Laboratory, Inc.



RFR2302318

10/28/2023 5:31:51 AM



Calibration Performed By:

KIMBALL ELECTRONIC LABORATORY, INC.
8081 W 21 LANE
HIALEAH, FL. 33016

Purchase Order

For: A.509
A. TOMASSI ROOF TESTING INC
5451 NW 24 STREET
#3
MARGATE FL 33063

Equipment Information KELI I.D.: ATO-51340

Description: OVEN
Manufacturer: QUINCY
Model Number: 30GC
Part Number: 30GC
Serial Number: 40694SL
Customer ID: N/A
Cust. Barcode: N/A
Cust. Dept.: N/A

Cal Date: 31-Jul-23
Cal. Due Date: 31-Oct-23
Cal. Interval: 3 MONTHS - DAY-MONTH-YEAR
Received: IN TOLERANCE
Calibration Result: PASS
Environmental Conditions: 78 DEG F / 50 % RH
Performed By: JESUS SITGES
Procedure: SYN1504

Cal Location: ON-SITE
Range: VARIOUS

Specifications: MANUFACTURER

This is to certify that the above listed instrument meets or exceeds all specifications as stated in the referenced procedure at the points tested (unless otherwise noted). It has been calibrated using measurement standards traceable to the SI units of measurement via NIST, or to NIST accepted intrinsic standards of measurement, or derived by the ratio type of self-calibration techniques. This calibration is in accordance with Kimball Electronic Laboratory, Inc Quality Assurance Manual. KELI's Quality system is A2LA-Accredited to ISO/IEC-17025:2017 and compliant with MIL-STD-45662A and ANSI/NCSL Z540-1-1994. TURS when applicable are greater than or equal to 4:1 except where noted with expanded uncertainty used to calculate the Test Uncertainty Ratio, with a coverage factor of K=2 at a confidence level of approximately 95%, unless otherwise noted. All measuring equipment used for calibration meets a 4:1 TAR or better, except where noted. Any number of factors may cause the calibration item to drift out of calibration before the recommended interval has expired. KELI will not take into account measurement uncertainty on conditional statements such as in tolerance, out of tolerance, pass and fail. Kel's conditional statements will only take into account the nominal value at a specific test point +/- the tolerance. Measurement uncertainty will be stated on the certificate and where applicable at each measured test point. KELI shall allow the customer to assess and conclude if the results meet their specific needs.

Calibration Remarks

THIS UNIT WAS FOUND TO BE IN TOLERANCE AT THE TIME OF CALIBRATION. PERFORMED ROUTINE CAL. NO ADJUSTMENTS REQUIRED

Standards Used To Calibrate Equipment

Company	I.D.	Manufacturer	Model/PN	Description	Serial Number	Last Cal.	Cal. Due Date
KIM001	2082	OMEGA	CL23A	TEMPERATURE CALIBRATOR	T-198769	09-Nov-22	30-Nov-23

Signatures:

Technician: 172
JESUS
SITGES

31-Jul-23 9:40:25 AM

Quality Assurance:
JAVIER
BALCEIRO

01-Aug-23 9:41:12 AM

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Kimball Electronic Laboratory, Inc. - 8081 W. 21st Lane - Hialeah, FL. 33016
Tel: 305-822-5792 - Toll Free: 800-393-1094 - Fax: 305-362-3125 - Web: www.kelilabs.com

Certificate of Calibration

KELC-935260

Kimball Electronic Laboratory, Inc.



RFR2302318

10/28/2023 5:31:51 AM



Calibration Performed By:

KIMBALL ELECTRONIC LABORATORY, INC.
8081 W 21 LANE
HIALEAH, FL. 33016

Purchase Order

For: A.509

A. TOMASSI ROOF TESTING INC
5451 NW 24 STREET
#3

Equipment Information KELI I.D.: KEL-120305

MARGATE FL 33063

Description: DIGITAL SCALE

Manufacturer: ACCULAB
Model Number: ALC-2100.2
Part Number: ALC-2100.2
Serial Number: 19250514
Customer ID: N/A
Cust. Barcode: N/A
Cust. Dept.: N/A

Cal Date: 31-Jul-23
Cal. Due Date: 31-Oct-23
Cal. Interval: 3 MONTHS - DAY-MONTH-YEAR

Received: IN TOLERANCE
Calibration Result: PASS
Environmental Conditions: 78 DEG F / 50 % RH
Performed By: JESUS
SITGES
Procedure: SYN141

Cal Location: ON-SITE

Range: 0-2100 GRAMS

Specifications: +/- 0.02 GRAMS

This is to certify that the above listed instrument meets or exceeds all specifications as stated in the referenced procedure at the points tested (unless otherwise noted). It has been calibrated using measurement standards traceable to the SI units of measurement via NIST, or to NIST accepted intrinsic standards of measurement, or derived by the ratio type of self-calibration techniques. This calibration is in accordance with Kimball Electronic Laboratory, Inc Quality Assurance Manual. KELI's Quality system is A2LA-Accredited to ISO/IEC-17025:2017 and compliant with MIL-STD-46082A and ANSI/NCCL Z540-1-1994. TURs when applicable are greater than or equal to 4:1 except where noted with expanded uncertainty used to calculate the Test Uncertainty Ratio, with a coverage factor of K=2 at a confidence level of approximately 95%, unless otherwise noted.

All measuring equipment used for calibration meets a 4:1 TAR or better, except where noted

Any number of factors may cause the calibration item to drift out of calibration before the recommended interval has expired.

KELI will not take into account measurement uncertainty on conditional statements such as in tolerance, out of tolerance, pass and fail. Kel's conditional statements will only take into account the nominal value at a specific test point +/- the tolerance. Measurement uncertainty will be stated on the certificate and where applicable at each measured test point. KELI shall allow the customer to assess and conclude if the results meet their specific needs.

Calibration Remarks

THIS UNIT WAS FOUND TO BE IN TOLERANCE AT THE TIME OF CALIBRATION.
PERFORMED ROUTINE CAL. NO ADJUSTMENTS REQUIRED

Standards Used To Calibrate Equipment

Company	I.D.	Manufacturer	Model/PN	Description	Serial Number	Last Cal.	Cal. Due Date
KIM001	970	RICE LAKE	1G-1KG	WEIGHT SET	N/A	02-Jan-23	31-Jan-24

Signatures:

Technician: 172

JESUS

SITGES

31-Jul-23

9:45:16 AM

Quality Assurance:

JAVIER

BALCEIRO

01-Aug-23

9:46:02 AM

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Tel: 305-822-5792 - Toll Free: 800-393-1094 - Fax: 305-362-3125 - Web: www.kelilabs.com

Date of Issue: 01-Aug-23

Page 1 of 1



DEPARTMENT OF REGULATORY AND ECONOMIC RESOURCES (RER)
BOARD AND CODE ADMINISTRATION DIVISION
NOTICE OF ACCEPTANCE (NOA)

MIAMI DADE COUNTY
PRODUCT CONTROL SECTION
RER2302318
10/28/2023 8:31:51 AM
11805 SW 26 Street, Room 208
Miami, Florida 33175-2474
T (786)315-2590 F (786) 31525-99
www.miamidade.gov/economy

Tropical Roofing Products Florida, LLC
1818 SW 31 Ave.
Hallandale, FL 33009

SCOPE:

This NOA is being issued under the applicable rules and regulations governing the use of construction materials. The documentation submitted has been reviewed and accepted by Miami-Dade County RER - Product Control Section to be used in Miami-Dade County and other areas where allowed by the Authority Having Jurisdiction (AHJ).

This NOA shall not be valid after the expiration date stated below. The Miami-Dade County Product Control Section (in Miami-Dade County) and/or the AHJ (in areas other than Miami-Dade County) reserve the right to have this product or material tested for quality assurance purposes. If this product or material fails to perform in the accepted manner, the manufacturer will incur the expense of such testing and the AHJ may immediately revoke, modify, or suspend the use of such product or material within their jurisdiction. RER reserves the right to revoke this acceptance if it is determined by Miami-Dade County Product Control Section that this product or material fails to meet the requirements of the applicable building code.

This product is approved as described herein and has been designed to comply with the Florida Building Code including the High Velocity Hurricane Zone of the Florida Building Code.

DESCRIPTION: Eterna-Sil Series Silicone Roofing Cements, Adhesives, and Coatings

LABELING: Each unit shall bear a permanent label with the manufacturer's name or logo, city, state and following statement: "Miami-Dade County Product Control Approved", unless otherwise noted herein.

RENEWAL of this NOA shall be considered after a renewal application has been filed and there has been no change in the applicable building code negatively affecting the performance of this product.

TERMINATION of this NOA will occur after the expiration date or if there has been a revision or change in the materials, use, and/or manufacture of the product or process. Misuse of this NOA as an endorsement of any product, for sales, advertising or any other purposes shall automatically terminate this NOA. Failure to comply with any section of this NOA shall be cause for termination and removal of NOA.

ADVERTISEMENT: The NOA number preceded by the words Miami-Dade County, Florida, and followed by the expiration date may be displayed in advertising literature. If any portion of the NOA is displayed, then it shall be done in its entirety.

INSPECTION: A copy of this entire NOA shall be provided to the user by the manufacturer or its distributors and shall be available for inspection at the job site at the request of the Building Official.

This NOA renews and revises NOA 19-0307.02 consists of pages 1 through 7.
The submitted documentation was reviewed by Jorge L. Acebo.



ROOFING COMPONENT APPROVAL

Category: Roofing
Sub-Category: Cement-Adhesive-Coatings
Materials: Silicone

SCOPE:

This approves the roof maintenance and restoration coating system **Eterna-Sil Series Silicone Roofing Cements, Adhesives, and Coatings** to be used on existing roof assemblies as manufactured by, Tropical Roofing Products, and as described in this Notice of Acceptance, designed to comply with the Florida Building Code and the High Velocity Hurricane Zone of the Florida Building Code.

TRADE NAMES OF PRODUCTS MANUFACTURED OR LABELED BY APPLICANT:

TABLE 1

Test

Specification

Product

Description

<u>Product</u>	<u>Dimensions</u>	<u>Specification</u>	<u>Product Description</u>
Tropical Roofing Products #923 Eterna-Sil Premium Silicone Roof Coating silicone coating. <i>Manufacturing Location #1</i>	1, 5, and 55 gallons.	ASTM D6694	#923 Eterna-Sil Premium Silicone Roof Coating is a solvent based, single-component, silicone moisture cured roof coating.
Tropical Roofing Products #924 Eterna-Sil Premium Silicone Roof Coating ALSAN COATING SIL 402 <i>Manufacturing Location #1</i>	1, 5, 55, and 275 gallons.	ASTM D6694	#924 Eterna-Sil Premium Silicone Roof Coating or ALSAN COATING SIL 402 are solvent-free, high solids, single-component, silicone moisture cured roof coatings.
Tropical Roofing Products #997 Universal Acrylic & Silicone Primer ALSAN COATING Universal Primer <i>Manufacturing Location #2</i>	5 and 55 gallons.	Proprietary	Single component, water-based primer.
Tropical Roofing Products #996 Eterna-Sil Premium Asphalt Bleed Blocker ALSAN COATING Asphalt Bleed Blocking Primer <i>Manufacturing Location #1</i>	5 and 55 gallons.	Proprietary	Eterna-Sil Premium Asphalt Bleed Blocker or ALSAN COATING Asphalt Bleed Blocking Primer are acrylic single component, water based primers.
Tropical Roofing Products #9300 Eterna-Sil Premium Silicone Wet Patch Roof Repair RX <i>Manufacturing Location #1</i>	1 and 2 gallons.	Proprietary	A solvent-based, fibrated, single-component, silicone moisture cured roofing cement, mastic, and patch/repair product.
Tropical Roofing Products #9400 Eterna-Sil Premium Silicone Mastic ALSAN COATING SIL 402 Flashing <i>Manufacturing Location #1</i>	1 and 2 gallons.	Proprietary	A solvent-free, high solids, single-component, silicone moisture cured roofing cement, mastic, and seam sealer.



MANUFACTURING LOCATION:

1. Hallandale, FL
2. La Mirada, CA

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EVIDENCE SUBMITTED:

<u>Test Agency</u>	<u>Test Identifier</u>	<u>Test Name/Report</u>	<u>Date</u>
PRI Construction Materials Materials Technologies LLC	TRA-145-02-01	ASTM D 6694	03/09/18
	TRA-162-02-01	ASTM D2697/D1644/D2370/D624	04/24/18
	TRA-163-02-01	ASTM D2697/D1644/D2370/D624	04/24/18
	TRA-164-02-01	ASTM D 6694	03/06/18
	TRA-178-02-01	ASTM D2196/D1475/D1644/D4017/D3960	03/01/18
	TRA-178-02-01	ASTM D2196/D1475/D1644/D4017/D3960	03/01/18
	TRA-227-02-01	ASTM D 6694	01/15/19
	878T0044	ASTM D6694/D903	01/12/23
	878T0072	ASTM D1475/ D2196/D1644/D2697	08/10/23

BUILDING PERMIT REQUIREMENTS:

Application for building permit shall be accompanied by copies of the following:

1. This Notice of Acceptance.
2. Any other documents required by the Building Official or applicable Building Code in order to properly evaluate the installation of this system.

PHYSICAL PROPERTIES OF COMPONENTS

Trade names: Tropical Roofing Products #9300 Eterna-Sil Fibrated Silicone Mastic / Roof Repair RX

Application Rate: This material is applied by trowel or brush at a coverage rate of 80-120 linear feet.

Specifications: Proprietary

Description: A solvent-based, fibrated, single-component, silicone moisture cured roofing cement, mastic, and patch/repair product.

Container Size: 1, 2, and 5 gallons. Note all precautions on container.

Trade names: Tropical Roofing Products #9400 Eterna-Sil Premium Silicone Mastic / ALSAN COATING SIL 402 Flashing

Application Rate: This material is applied by trowel or brush at a coverage rate of 80-120 linear feet.

Specifications: Proprietary

Description: A solvent-free, high solids, single-component, silicone moisture cured roofing cement, mastic, and seam sealer.

Container Size: Tubes, 1, 2, and 5 gallons. Note all precautions on container.



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- Trade names:** Tropical Roofing Products #924 Eterna-Sil Premium Silicone Roof Coating/
ALSAN COATING SIL 402
- Thickness:** See scope of use below.
- Specifications:** ASTM D 6694
- Description:** A solvent-free, high solids, single-component, silicone moisture cured roof coating to be applied to the specified surfaces only as follows:
- **Asphalt Built-Up Roofing Granulated:** Prepare surface as per manufacturer's specification prior to application.
 - Option 1 – Apply #924 coating or ALSAN COATING SIL 402 directly to the substrate at a minimum rate of 1.20 gallons per 100 ft² or 18 mils Dry Film Thickness (DFT).
 - Option 2 – Apply Tropical Roofing Products #996 Eterna-Sil Premium Bleed Blocker or ALSAN COATING Asphalt Bleed Blocking Primer at a minimum rate of 1.0 gallon per 100 ft² or 7 mils Dry Film Thickness (DFT). Allow #996 or ALSAN COATING Asphalt Bleed Blocking Primer to fully cure, then apply #924 or ALSAN COATING SIL 402 at a minimum rate of 1.20 gallons per 100 ft² or 18 mils Dry Film Thickness (DFT).
 - **SBS Modified Bitumen Granulated:** Prepare surface as per manufacturer's specification prior to application.
 - Option 1 – Apply #924 coating or ALSAN COATING SIL 402 directly to the substrate at a minimum rate of 1.20 gallons per 100 ft² or 18 mils Dry Film Thickness (DFT).
 - Option 2 – Apply Tropical Roofing Products #996 Eterna-Sil Premium Bleed Blocker or ALSAN COATING Asphalt Bleed Blocking Primer at a minimum rate of 1.0 gallon per 100 ft² or 7 mils Dry Film Thickness (DFT). Allow #996 or ALSAN COATING Asphalt Bleed Blocking Primer to fully cure, then apply #924 or ALSAN COATING SIL 402 at a minimum rate of 1.20 gallons per ft² or 18 mils Dry Film Thickness (DFT)
 - **SBS Modified Bitumen Smooth:** Prepare surface as per manufacturer's specification prior to application. Apply Tropical Roofing Products #996 Eterna-Sil Premium Bleed Blocker or ALSAN COATING Asphalt Bleed Blocking Primer at a minimum rate of 1.0 gallon per 100 ft² or 7 mils Dry Film Thickness (DFT). Allow #996 or ALSAN COATING Asphalt Bleed Blocking Primer to fully cure, then apply #924 or ALSAN COATING SIL 402 at a minimum rate of 1.20 gallons per 100 ft² or 18 mils Dry Film Thickness (DFT).
 - **APP Modified Bitumen Granulated:** Prepare surface as per manufacturer's specification prior to application. Apply Tropical Roofing Products #996 Eterna-Sil Premium Bleed Blocker or ALSAN COATING Asphalt Bleed Blocking Primer at a minimum rate of 1.0 gallon per 100 ft² or 7 mils Dry Film Thickness (DFT). Allow #996 or ALSAN COATING Asphalt Bleed Blocking Primer to fully cure, then apply #924 or ALSAN COATING SIL 402 at a minimum rate of 1.20 gallons per 100 ft² or 18 mils Dry Film Thickness (DFT).
 - **Spray Polyurethane Foam:** Prepare surface as per manufacturer's specification prior to application. Then apply #924 coating or ALSAN COATING SIL 402 directly to the substrate at a minimum rate of 1.20 gallons per 100 ft² or 18 mils Dry Film Thickness (DFT).
- Container Size:** 1, 5, 55, and 275 gallons. Note all precautions on container.

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- Trade names:** Tropical Roofing Products #924 Eterna-Sil Premium Silicone Roof Coating / ALSAN COATING SIL 402 (Continued)
- Thickness:** See scope of use below.
- Specifications:** ASTM D 6694
- Description:** A solvent-free, high solids, single-component, silicone moisture cured roof coating to be applied to the specified surfaces only as follows:
- **PVC Single Ply Membrane:** Prepare surface as per manufacturer's specification prior to application. Then apply #924 coating or ALSAN COATING SIL 402 directly to the substrate at a minimum rate of 1.20 gallons per 100 ft² or 18 mils Dry Film Thickness (DFT).
 - **EPDM Single Ply Membrane:** Prepare surface as per manufacturer's specification prior to application.
 - Option 1 – Apply #924 coating or ALSAN COATING SIL 402 directly to the substrate at a minimum rate of 1.20 gallons per 100 ft² or 18 mils Dry Film Thickness (DFT).
 - Option 2 – Apply Tropical Roofing Products #997 Universal Acrylic & Silicone Primer or ALSAN COATING Universal Primer at a minimum rate of 1 gallon per 100 ft² or 16 mils Wet Film Thickness (WFT). Allow #997 to fully cure, then apply #924 coating or ALSAN COATING SIL 402 directly to the substrate at a minimum rate of 1.20 gallons per 100 ft² or 18 mils Dry Film Thickness (DFT).
 - **Galvanized Steel:** Prepare surface as per manufacturer's specification prior to application.
 - Option 1 – Then apply #924 coating or ALSAN COATING SIL 402 directly to the substrate at a minimum rate of 1.20 gallons per 100 ft² or 18 mils Dry Film Thickness (DFT).
 - Option 2 – Apply Tropical Roofing Products #997 Universal Acrylic & Silicone Primer or ALSAN COATING Universal Primer at a minimum rate of 1 gallon per 100 ft² or 16 mils Wet Film Thickness (WFT). Allow #997 to fully cure, then apply #924 coating or ALSAN COATING SIL 402 directly to the substrate at a minimum rate of 1.20 gallons per 100 ft² or 18 mils Dry Film Thickness (DFT).
 - **Concrete*:** Prepare surface as per manufacturer's specification prior to application.
 - Option 1 – Then apply #924 coating or ALSAN COATING SIL 402 directly to the substrate at a minimum rate of 1.20 gallons per 100 ft² or 18 mils Dry Film Thickness (DFT).
 - Option 2 – Apply Tropical Roofing Products #997 Universal Acrylic & Silicone Primer or ALSAN COATING Universal Primer at a minimum rate of 1 gallon per 100 ft² or 16 mils Wet Film Thickness (WFT). Allow #997 to fully cure, then apply #924 coating or ALSAN COATING SIL 402 directly to the substrate at a minimum rate of 1.20 gallons per 100 ft² or 18 mils Dry Film Thickness (DFT).
 - **Aluminum:** Prepare surface as per manufacturer's specification prior to application. Then apply Tropical Roofing Products #997 Universal Acrylic & Silicone Primer or ALSAN COATING Universal Primer at a minimum rate of 1 gallon per 100 ft² or 16 mils Wet Film Thickness (WFT). Allow #997 to fully cure, then apply #924 coating or ALSAN COATING SIL 402 directly to the substrate at a minimum rate of 1.20 gallons per 100 ft² or 18 mils Dry Film Thickness (DFT).
- *Note: See Limitation #1.
- Container Size:** 1, 5, 55, and 275 gallons. Note all precautions on container.

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- Trade names:** Tropical Roofing Products #923 Eterna-Sil Silicone Roof Coating
- Thickness:** See scope of use below.
- Specifications:** ASTM D 6694
- Description:** A solvent based, single-component, silicone moisture cured roof coating to be applied to the specified surfaces only as follows:
- **Asphalt Built-Up Roofing Granulated:** Prepare surface as per manufacturer's specification prior to application. Apply Tropical Roofing Products #996 Eterna-Sil Premium Bleed Blocker or ALSAN COATING Asphalt Bleed Blocking Primer at a minimum rate of 1.0 gallon per 100 ft² or 7 mils Dry Film Thickness (DFT). Allow #996 or ALSAN COATING Asphalt Bleed Blocking Primer to fully cure, then apply #923 at a minimum rate of 1.60 gallons per 100 ft² or 18 mils Dry Film Thickness (DFT).
 - **Asphalt Built-Up Roofing Smooth:** Prepare surface as per manufacturer's specification prior to application. Apply Tropical Roofing Products #996 Eterna-Sil Premium Bleed Blocker or ALSAN COATING Asphalt Bleed Blocking Primer at a minimum rate of 1.0 gallon per 100 ft² or 7 mils Dry Film Thickness (DFT). Allow #996 or ALSAN COATING Asphalt Bleed Blocking Primer to fully cure, then apply #923 at a minimum rate of 1.60 gallons per 100 ft² or 18 mils Dry Film Thickness (DFT).
 - **SBS Modified Bitumen Granulated:** Prepare surface as per manufacturer's specification prior to application. Apply Tropical Roofing Products #996 Eterna-Sil Premium Bleed Blocker or ALSAN COATING Asphalt Bleed Blocking Primer at a minimum rate of 1.0 gallon per 100 ft² or 7 mils Dry Film Thickness (DFT). Allow #996 or ALSAN COATING Asphalt Bleed Blocking Primer to fully cure, then apply #923 at a minimum rate of 1.60 gallons per 100 ft² or 18 mils Dry Film Thickness (DFT).
 - **SBS Modified Bitumen Smooth:** Prepare surface as per manufacturer's specification prior to application. Apply Tropical Roofing Products #996 Eterna-Sil Premium Bleed Blocker or ALSAN COATING Asphalt Bleed Blocking Primer at a minimum rate of 1.0 gallon per 100 ft² or 7 mils Dry Film Thickness (DFT). Allow #996 or ALSAN COATING Asphalt Bleed Blocking Primer to fully cure, then apply #923 at a minimum rate of 1.60 gallons per 100 ft² or 18 mils Dry Film Thickness (DFT).
 - **APP Modified Bitumen Granulated:** Prepare surface as per manufacturer's specification prior to application. Apply Tropical Roofing Products #996 Eterna-Sil Premium Bleed Blocker or ALSAN COATING Asphalt Bleed Blocking Primer at a minimum rate of 1.0 gallon per 100 ft² or 7 mils Dry Film Thickness (DFT). Allow #996 or ALSAN COATING Asphalt Bleed Blocking Primer to fully cure, then apply #923 at a minimum rate of 1.60 gallons per 100 ft² or 18 mils Dry Film Thickness (DFT).
 - **Galvanized Steel:** Prepare surface as per manufacturer's specification prior to application. Then apply #923 coating directly to the substrate at a minimum rate of 1.60 gallons per 100 ft² or 18 mils Dry Film Thickness (DFT).
 - **Concrete*:** Prepare surface as per manufacturer's specification prior to application. Then apply #923 coating directly to the substrate at a minimum rate of 1.60 gallons per 100 ft² or 18 mils Dry Film Thickness (DFT).
- *Note: See Limitation #1.
- Container Size:** 1, 5, and 55 gallons. Note all precautions on container.

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GENERAL LIMITATIONS:

1. Tropical Roofing Products Eterna-Sil Series Silicone Roofing Cements, Adhesives, and Coatings are not approved as and shall not be used as a Roof or Waterproofing System as required by the Florida Building Code Chapter 15 HVHZ..
2. Fire classification is not part of this acceptance; refer to a current Approved Roofing Materials Directory for fire rating of this product.
3. Tropical Roofing Products, Eterna-Sil Series Silicone Roofing Cements, Adhesives, and Coatings shall not be applied in inclement weather conditions.
4. Tropical Roofing Products Eterna-Sil Series Silicone Roofing Cements, Adhesives, and Coatings, shall not be applied over asphaltic shingles, metal shingles, fiber-cement shingles, quarry slate, cement or clay roofing tile, or wood shingles or shakes.
5. The products listed herein are components of roof assemblies and are approved for use with roof assemblies that list any of the products listed herein as part of their Roof Assembly's Notice of Acceptance.
6. All approved products listed herein shall be labeled in compliance with TAS 121 and shall bear the imprint or identifiable marking of the manufacturer's name or logo, city, state and following statement: "Miami-Dade County Product Control Approved" or the Miami-Dade County Product Control Seal as shown below.



7. Tropical Roofing Products, Eterna-Sil Series Silicone Roofing Cements, Adhesives, and Coatings, shall only be applied by a factory trained and certified applicators and in accordance with manufacturer's published application instructions.
8. All products listed herein shall have an unannounced follow-up quality control program from an approved listing agency. Follow up test results shall be made available to Miami-Dade Product Control upon request.
9. Change in materials use, or manufacture of any of the products listed herein shall be cause for termination of this Notice of Acceptance.
10. All products listed herein shall have a quality assurance audit in accordance with the Florida Building Code and Rule 61G20-3 of the Florida Administrative Code.

END OF THIS ACCEPTANCE

